

**UTILITY PROVIDERS:**

SANITARY SEWER & POTABLE WATER  
ECUA  
P.O. BOX 15311  
PENSACOLA, FLORIDA 32514  
PH: 850-476-4080  
FAX: 850-494-7346

ELECTRICAL POWER:  
GULF POWER COMPANY  
9220 ONE ENERGY PLACE  
PENSACOLA, FLORIDA 32501  
PH: 850-505-5600

TELEPHONE:  
AT&T  
603 WEST GARDEN STREET  
PENSACOLA, FLORIDA 32501  
PH: 850-436-1616

CABLE TELEVISION:  
COX COMMUNICATIONS  
3405 McLEMORE DRIVE  
PENSACOLA, FLORIDA 32514  
PH: 850-857-4551  
850-232-5044

NATURAL GAS:  
PENSACOLA ENERGY  
1625 ATWOOD DRIVE  
PENSACOLA, FLORIDA 32514  
PH: 850-874-5319

SUNSHINE 811  
11 PLANTATION ROAD  
DEBARY, FL 32713  
PH: 800-432-4770

**SITE DATA:**

TAX APPRAISER'S PROPERTY  
REFERENCE NUMBER:  
00-05-00-9400-000-100

ZONING:  
WRD = WATERFRONT REDEVELOPMENT DISTRICT

**CIVIL ENGINEERING PLANS  
FOR**

**COMMUNITY MARITIME PARK  
DAY USE  
MARINA DESIGN PROJECT**

**FOR**



**PENSACOLA, FLORIDA**

**JUNE 2021**

PROJECT NO. 29001.13


**PREPARED BY**



**BASKERVILLE-DONOVAN, INC.  
ENGINEERING THE SOUTH SINCE 1927**

449 W. MAIN ST., PENSACOLA, FL 32502 (850)438-9661  
ENGINEERING BUSINESS: EB-0000340

Pensacola - Panama City Beach - Tallahassee - Mobile

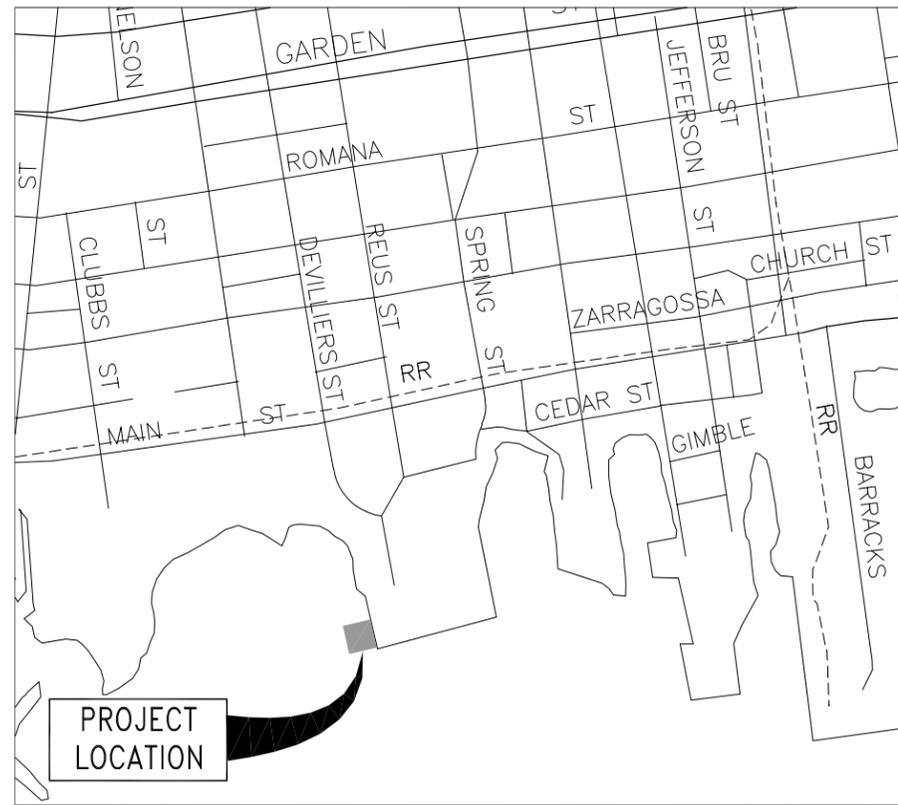

**VICINITY MAP**

NOT TO SCALE



**INDEX OF SHEETS**

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100% SUBMITTAL  
JUNE 2021


STANDARD MANATEE CONDITIONS FOR IN-WATER WORK

2011  
 PERMIT NO: SAJ-2007-04728-SP-EPS

THE PERMITTEE SHALL COMPLY WITH THE FOLLOWING CONDITIONS INTENDED TO PROTECT MANATEES FROM DIRECT PROJECT EFFECTS:

1. ALL PERSONNEL ASSOCIATED WITH THE PROJECT SHALL BE INSTRUCTED ABOUT THE PRESENCE OF MANATEES AND MANATEE SPEED ZONES, AND THE NEED TO AVOID COLLISIONS WITH AND INJURY TO MANATEES. THE PERMITTEE SHALL ADVISE ALL CONSTRUCTION PERSONNEL THAT THERE ARE CIVIL AND CRIMINAL PENALTIES FOR HARMING, HARASSING, OR KILLING MANATEES WHICH ARE PROTECTED UNDER THE MARINE MAMMAL PROTECTION ACT, THE ENDANGERED SPECIES ACT, AND THE FLORIDA MANATEE SANCTUARY ACT.
2. ALL VESSELS ASSOCIATED WITH THE CONSTRUCTION PROJECT SHALL OPERATE AT "IDLE SPEED/NO WAKE" AT ALL TIMES WHILE IN THE IMMEDIATE AREA AND WHILE IN WATER WHERE THE DRAFT OF THE VESSEL PROVIDES LESS THAN A FOUR-FOOT CLEARANCE FROM THE BOTTOM. ALL VESSELS WILL FOLLOW ROUTES OF DEEP WATER WHENEVER POSSIBLE.
3. SILTATION OR TURBIDITY BARRIERS SHALL BE MADE OF MATERIAL IN WHICH MANATEES CANNOT BECOME ENTANGLED, SHALL BE PROPERLY SECURED, AND SHALL BE REGULARLY MONITORED TO AVOID MANATEE ENTANGLEMENT OR ENTRAPMENT. BARRIERS MUST NOT IMPEDE MANATEE MOVEMENT.
4. ALL ON-SITE PROJECT PERSONNEL ARE RESPONSIBLE FOR OBSERVING WATER-RELATED ACTIVITIES FOR THE PRESENCE OF MANATEE(S). ALL IN-WATER OPERATIONS, INCLUDING VESSELS, MUST BE SHUT DOWN IF A MANATEE(S) COMES WITHIN 50 FEET OF THE OPERATION. ACTIVITIES WILL NOT RESUME UNTIL THE MANATEE(S) HAS MOVED BEYOND THE 50-FOOT RADIUS OF THE PROJECT OPERATION, OR UNTIL 30 MINUTES ELAPSES IF THE MANATEE(S) HAS NOT REAPPEARED WITHIN 50 FEET OF THE OPERATION. ANIMALS MUST NOT BE HERDED AWAY OR HARASSED INTO LEAVING.
5. ANY COLLISION WITH OR INJURY TO A MANATEE SHALL BE REPORTED IMMEDIATELY TO THE FLORIDA FISH AND WILDLIFE CONSERVATION COMMISSION (FWC) HOTLINE AT 1-888-404-3922. COLLISION AND/OR INJURY SHOULD ALSO BE REPORTED TO THE U.S. FISH AND WILDLIFE SERVICE IN JACKSONVILLE (1-904-731-3336) FOR NORTH FLORIDA OR VERO BEACH (1-772-562-3909) FOR SOUTH FLORIDA, AND TO FWC AT IMPERILEDSPESIES@MYFWC.COM
6. TEMPORARY SIGNS CONCERNING MANATEES SHALL BE POSTED PRIOR TO AND DURING ALL IN-WATER PROJECT ACTIVITIES. ALL SIGNS ARE TO BE REMOVED BY THE PERMITTEE UPON COMPLETION OF THE PROJECT. TEMPORARY SIGNS THAT HAVE ALREADY BEEN APPROVED FOR THIS USE BY THE FWC MUST BE USED. ONE SIGN WHICH READS CAUTION: BOATERS MUST BE POSTED. A SECOND SIGN MEASURING AT LEAST 8 1/2" BY 11" EXPLAINING THE REQUIREMENTS FOR "IDLE SPEED/NO WAKE" AND THE SHUTDOWN OF IN-WATER OPERATIONS MUST BE POSTED IN A LOCATION PROMINENTLY VISIBLE TO ALL PERSONNEL ENGAGED IN WATER-RELATED ACTIVITIES. THESE SIGNS CAN BE VIEWED AT MYFWC.COM/MANATEE. QUESTIONS CONCERNING THESE SIGNS CAN BE SENT TO THE EMAIL ADDRESS LISTED ABOVE.

LEGEND

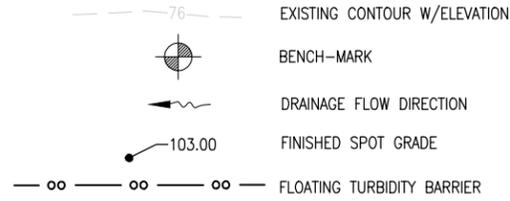

GENERAL NOTES:

1. THE CONTRACTOR IS CAUTIONED TO VISIT THE SITE AND FAMILIARIZE HIMSELF WITH THE PROJECT PRIOR TO BIDDING.
2. ELEVATIONS SHOWN ARE RELATIVE TO N.G.V.D. 88.
3. THE CONTRACTOR IS RESPONSIBLE TO DETERMINE THE EXACT LOCATIONS AND DEPTHS OF ALL UTILITIES INCLUDING, BUT NOT LIMITED TO, WATER LINES, BURIED TELEPHONE LINES, BURIED ELECTRICAL LINES AND GAS MAINS PRIOR TO COMMENCEMENT OF CONSTRUCTION. CONTRACTOR IS TO COORDINATE WITH UTILITY COMPANIES FOR REMOVAL AND/OR RELOCATION OF EXISTING UTILITY POLES, AERIAL LINES, BURIED CABLE AND OTHER UTILITIES.
4. THE CONTRACTOR SHALL NOTIFY THE ENGINEER IMMEDIATELY OF ANY CONFLICTS BETWEEN CONTRACT DOCUMENTS AND EXISTING CONDITIONS. THESE DRAWINGS REPRESENT KNOWN STRUCTURES AND UTILITIES LOCATED IN THE PROJECT AREA. THE CONTRACTOR IS CAUTIONED THAT OTHER STRUCTURES AND UTILITIES, ABOVE OR BELOW GROUND, MAY BE ENCOUNTERED DURING THE COURSE OF THE PROJECT. THE CONTRACTOR SHOULD NOTIFY THE UTILITY, THEN THE ENGINEER, IMMEDIATELY UPON ENCOUNTERING ANY UNEXPECTED STRUCTURE, UTILITY LINE, OR OTHER UNUSUAL CONDITION. EXISTING CONDITIONS ARE BASED ON SURVEYS BY BASKERVILLE-DONOVAN, INC.
5. CONTRACTOR SHALL SAFETY-BARRICADE ALL EXCAVATIONS AND OTHER HAZARDS.
6. CONTRACTOR SHALL PROVIDE ACCESS TO PROPERTIES ADJACENT TO THE CONSTRUCTION AREAS. ADEQUATE BARRICADES, CONSTRUCTION SIGNAGE AND OTHER TRAFFIC CONTROL DEVICES SHALL BE PROVIDED IN ACCORDANCE WITH FDOT CONSTRUCTION STANDARDS.
7. THE CONTRACTOR SHALL EMPLOY THE USE OF SILT FENCES, HAY BALES, DITCHES OR WHATEVER MEANS NECESSARY TO CONTROL EROSION AND SEDIMENTATION AT ALL TIMES. WATERS OF THE STATE, ADJACENT PROPERTIES, AND ANY NEW DRAINAGE CONSTRUCTION SHALL BE PROTECTED DURING THE CONSTRUCTION PERIOD. EROSION CONTROL MEASURES SHALL BE INSTALLED PRIOR TO THE START OF CONSTRUCTION AND SHALL REMAIN UNTIL THE COMPLETION OF CONSTRUCTION AND ACCEPTANCE BY THE OWNER.
8. ADEQUATE PROVISIONS SHALL BE MADE FOR THE FLOW OF SEWERS, DRAINS, WATER COURSES AND OTHER UTILITIES ENCOUNTERED DURING CONSTRUCTION.
9. ALL TREES IN THE PROJECT AREA ARE TO REMAIN UNDAMAGED UNLESS NOTED FOR REMOVAL OR APPROVED BY THE ENGINEER.
10. THE CONTRACTOR IS TO REPLACE TO EXISTING CONDITIONS OR BETTER ANY FENCES, SPRINKLER SYSTEMS, TREES AND SHRUBS, MAINTAINED FLOWER BEDS, OR OTHER EXISTING IMPROVEMENTS IMPACTED DURING CONSTRUCTION, WHETHER DEPICTED IN THE PLANS OR NOT.
11. ALL NEW CONCRETE FOR SITE WORK SHALL ACHIEVE A 28 DAY STRENGTH OF 3000 PSI (MIN.), UNLESS OTHERWISE SPECIFIED.
12. NO SITE WORK ACTIVITIES SHALL TAKE PLACE WITHOUT CITY SITE REVIEW AND APPROVAL OF PROPOSED EROSION CONTROL MEASURES AND ADVANCED NOTIFICATION OF THE REQUESTED INSPECTION IS REQUIRED.

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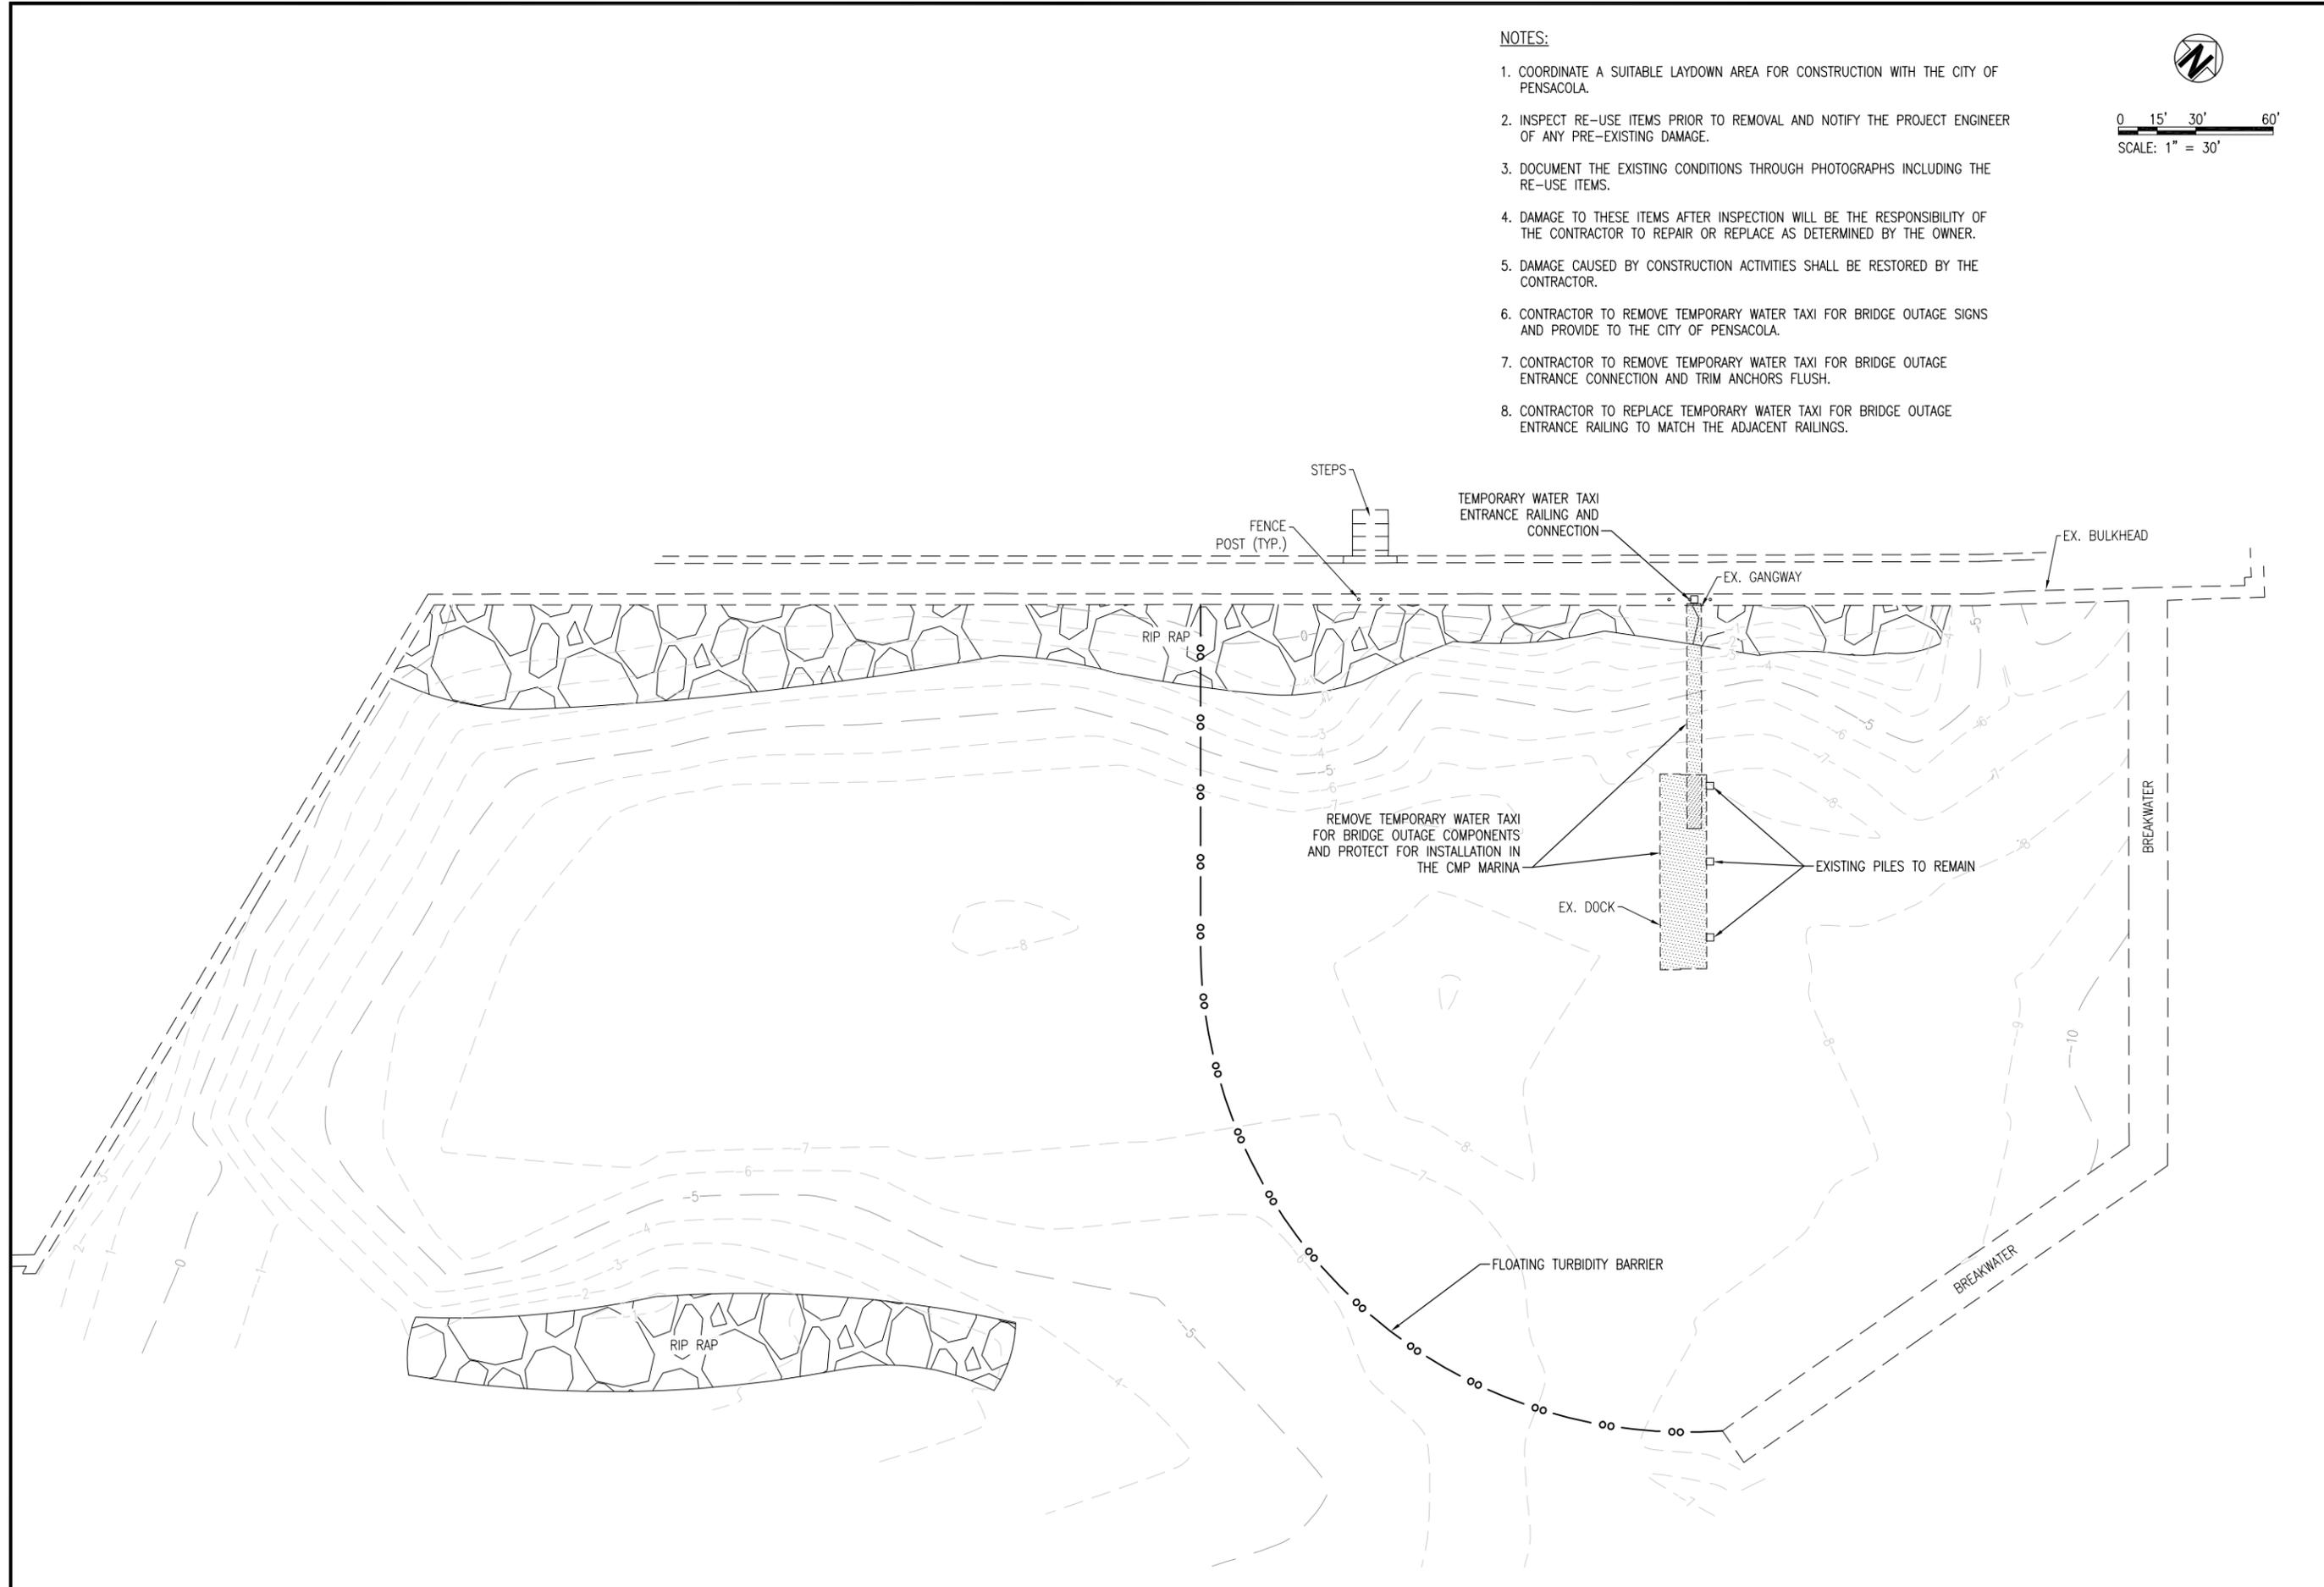
JASON J. FRICK, P.E.  
 FL. Reg. Engineer #60469

**COMMUNITY MARITIME  
 PARK DAY USE  
 MARINA DESIGN  
 PROJECT**

PROJECT NO:	NO.	DATE	APPR.	REVISION/ACTION TAKEN
29001.13				
DESIGNED BY:				
DRAWN BY: RGG				
CHK'D BY: MDL				
PROJ. MGR: MDL				
DATE: JUNE 2021				


**GENERAL NOTES,  
 LEGEND & SITE DATA**

**G-001**





**NOTES:**

1. COORDINATE A SUITABLE LAYDOWN AREA FOR CONSTRUCTION WITH THE CITY OF PENSACOLA.
2. INSPECT RE-USE ITEMS PRIOR TO REMOVAL AND NOTIFY THE PROJECT ENGINEER OF ANY PRE-EXISTING DAMAGE.
3. DOCUMENT THE EXISTING CONDITIONS THROUGH PHOTOGRAPHS INCLUDING THE RE-USE ITEMS.
4. DAMAGE TO THESE ITEMS AFTER INSPECTION WILL BE THE RESPONSIBILITY OF THE CONTRACTOR TO REPAIR OR REPLACE AS DETERMINED BY THE OWNER.
5. DAMAGE CAUSED BY CONSTRUCTION ACTIVITIES SHALL BE RESTORED BY THE CONTRACTOR.
6. CONTRACTOR TO REMOVE TEMPORARY WATER TAXI FOR BRIDGE OUTAGE SIGNS AND PROVIDE TO THE CITY OF PENSACOLA.
7. CONTRACTOR TO REMOVE TEMPORARY WATER TAXI FOR BRIDGE OUTAGE ENTRANCE CONNECTION AND TRIM ANCHORS FLUSH.
8. CONTRACTOR TO REPLACE TEMPORARY WATER TAXI FOR BRIDGE OUTAGE ENTRANCE RAILING TO MATCH THE ADJACENT RAILINGS.

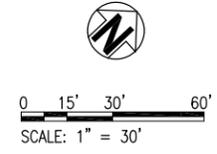

 <b>BASKERVILLE-DONOVAN, INC.</b> ENGINEERING THE SOUTH SINCE 1927 <small>449 W. MAIN ST., PENSACOLA, FL 32502 (850)438-9861          ENGINEERING BUSINESS: EB-0000340          Pensacola - Panama City Beach - Tallahassee - Mobile</small>		<small>This drawing is the property of BASKERVILLE-DONOVAN, INC. and is not to be reproduced in whole or in part. It is not to be used on any other project and is to be returned upon request.</small>	
<small>JASON J. FRICK, P.E.          FL. Reg. Engineer #96469</small>		<b>COMMUNITY MARITIME          PARK DAY USE          MARINA DESIGN          PROJECT</b>	
PROJECT NO:	29001.13	NO.	NO.
DESIGNED BY:	JJF	APPR.	
DRAWN BY:	RCG	DATE	
CHK'D BY:	MOL	REVISION/ACTION TAKEN	
PROJ. MGR:	MOL	NOT RELEASED FOR CONSTRUCTION BY	DATE
DATE:	JUNE 2021		
<b>EXISTING CONDITIONS          AND EROSION CONTROL          CONTROL PLAN</b>		<b>C-100</b>	

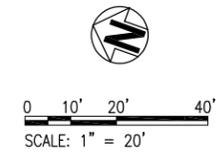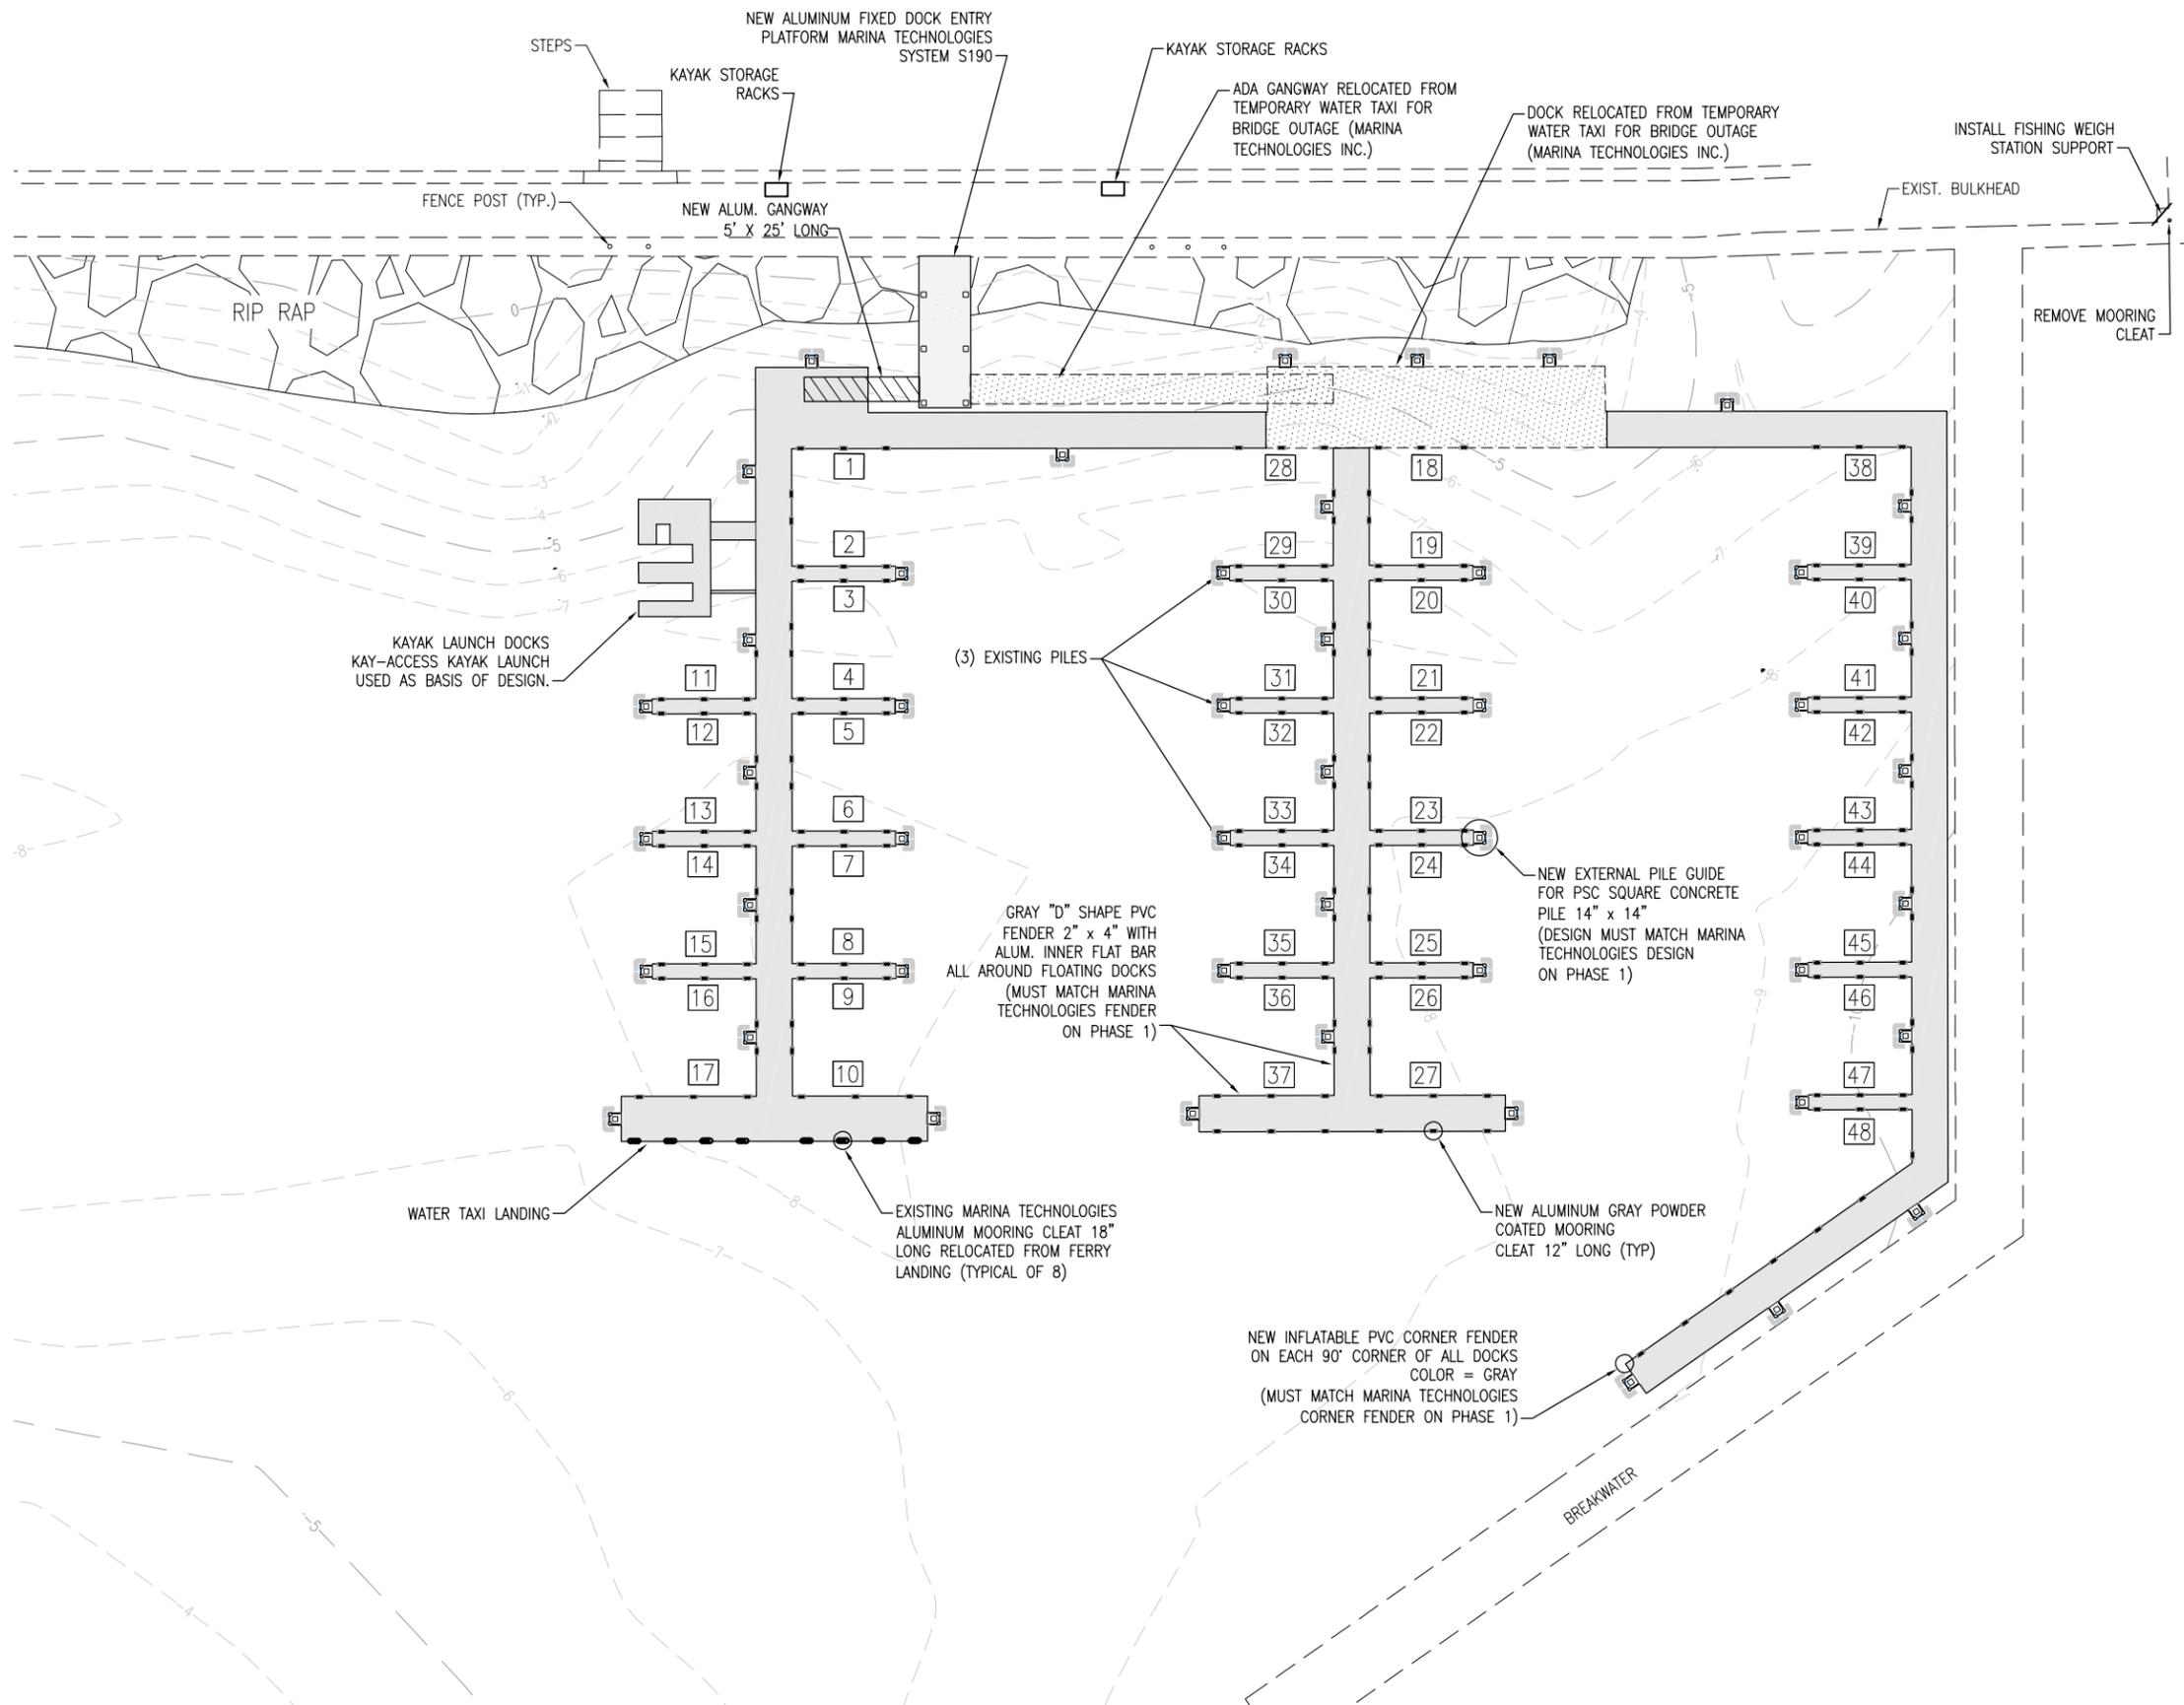

- LEGEND**
- NEW ALUMINUM FLOATING DOCKS
  - NEW ALUMINUM FIXED DOCKS
  - RE-USE DOCKS AND GANGWAY
  - NEW GANGWAY
  - 42 SLIP NUMBER
  - NEW ALUMINUM EXTERNAL PILE GUIDE 14"
  - NEW ALUMINUM POWDER COATED MOORING CLEAT 12"
  - RE-USE MARINA TECHNOLOGIES ALUMINUM MOORING CLEAT 18"

- NOTES:**
1. MARINA TECHNOLOGIES MARINA USED AS BASIS OF DESIGN FOR THE MARINA.
  2. KAY-ACCESS SYSTEM USED AS BASIS OF DESIGN FOR THE KAYAK LAUNCH.
  3. THE CONTRACTOR SHALL MODIFY/FABRICATE THE EXISTING RAILING TO ALLOW ACCESS TO THE MARINA.
  4. CONTRACTOR TO FURNISH AND INSTALL A WEIGH STATION.
  5. SHOP DRAWINGS OF THE WEIGH STATION SHALL BE APPROVED BY THE CITY OF PENSACOLA.

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**COMMUNITY MARITIME  
PARK DAY USE  
MARINA DESIGN  
PROJECT**

JOHN J. FRICK, P.E.  
FL. Reg. Engineer #96469

NO.	DATE	APPR.	REVISION/ACTION TAKEN

PROJECT NO: **29001.13**

DESIGNED BY: JJF

DRAWN BY: RGG

CHK'D BY: MDL

PROJ. MGR: MDL



DATE: JUNE 2021

NOT RELEASED FOR CONSTRUCTION BY \_\_\_\_\_ DATE \_\_\_\_\_

**SITE PLAN**

C-101



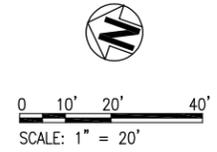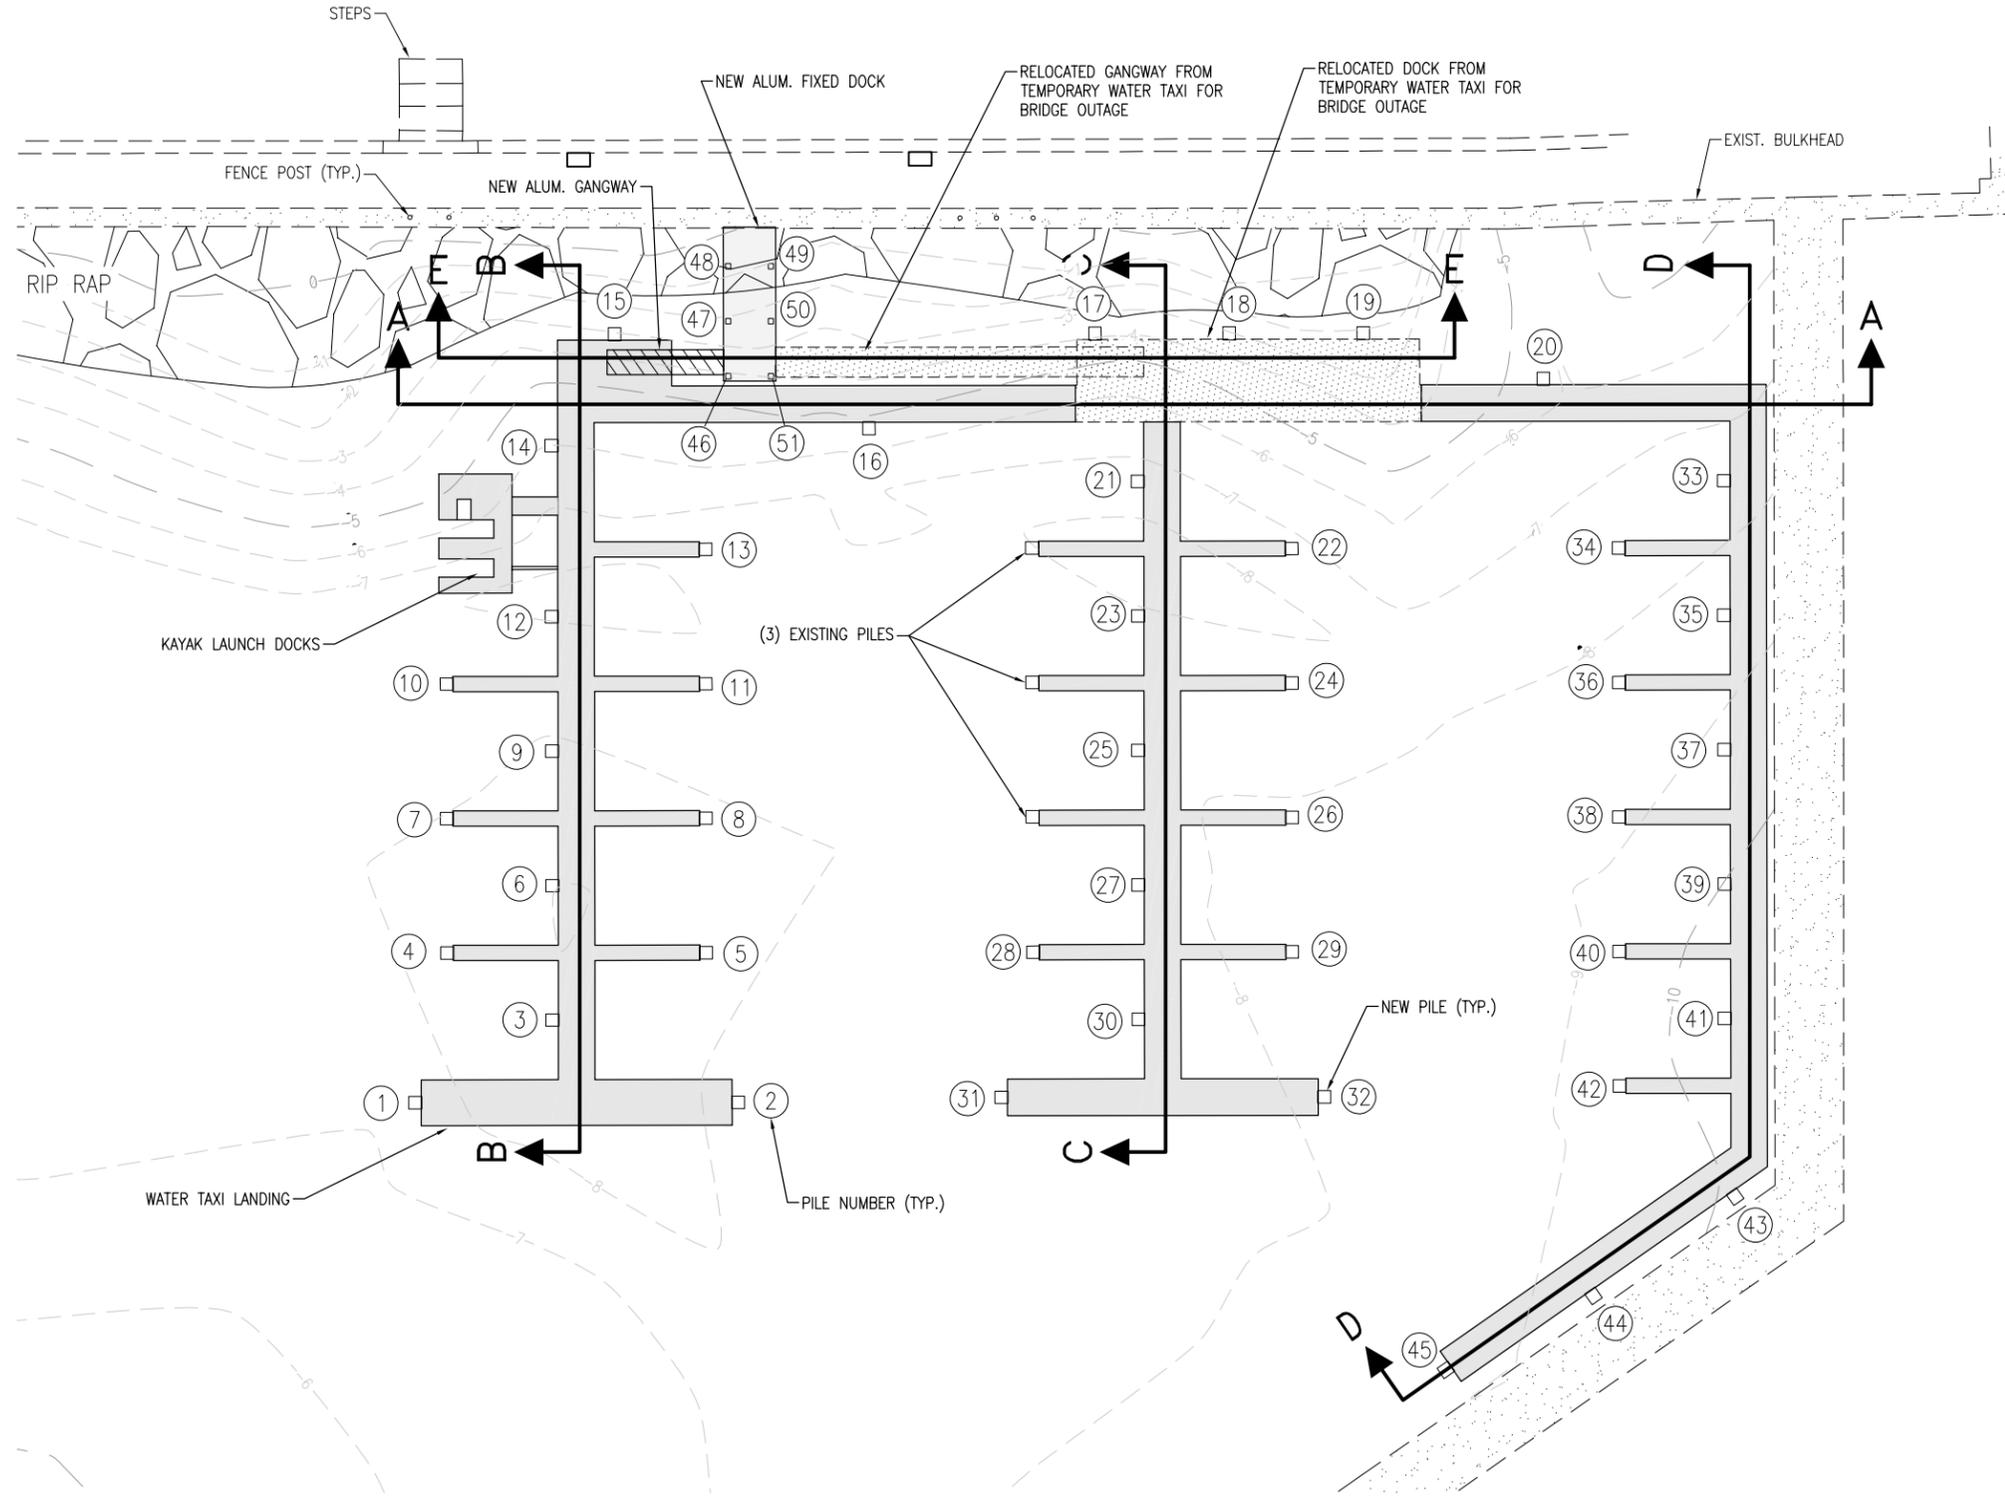

- LEGEND**
- NEW ALUMINUM FLOATING DOCKS
  - NEW ALUMINUM FIXED DOCKS
  - RE-USE DOCKS AND GANGWAY
  - NEW GANGWAY
  - 42 PILE NUMBER
  - NEW ALUMINUM EXTERNAL PILE GUIDE 14"

**BASKERVILLE-DONOVAN, INC.**  
**ENGINEERING THE SOUTH SINCE 1927**  
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 Pensacola - Panama City Beach - Tallahassee - Mobile

JASON J. FRICK, D.E.  
 FL. Reg. Engineer #96469



**COMMUNITY MARITIME  
 PARK DAY USE  
 MARINA DESIGN  
 PROJECT**

NO.	DATE	APPR.	REVISION/ACTION TAKEN


PROJECT NO: **29001.13**  
 DESIGNED BY: JJF  
 DRAWN BY: RGG  
 CHK'D BY: MDL  
 PROJ. MGR: MDL  
 DATE: JUNE 2021

**SECTION LAYOUT**

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PLAN

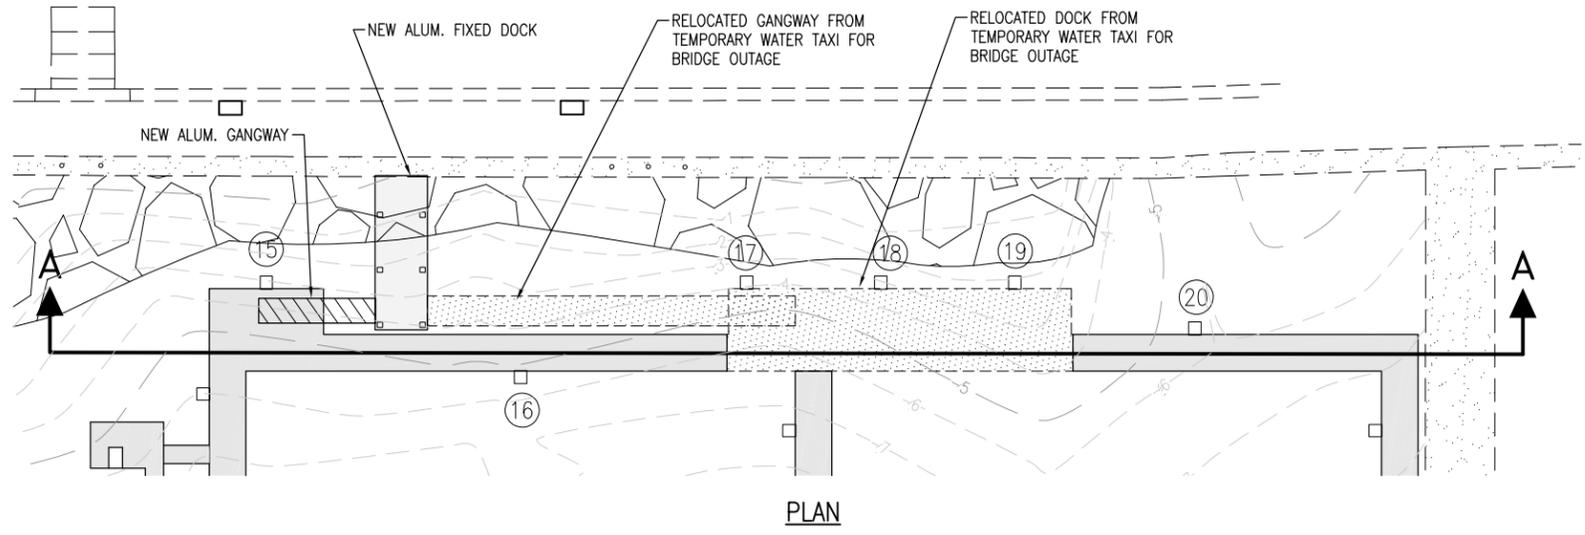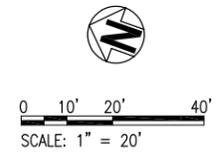

SECTION A

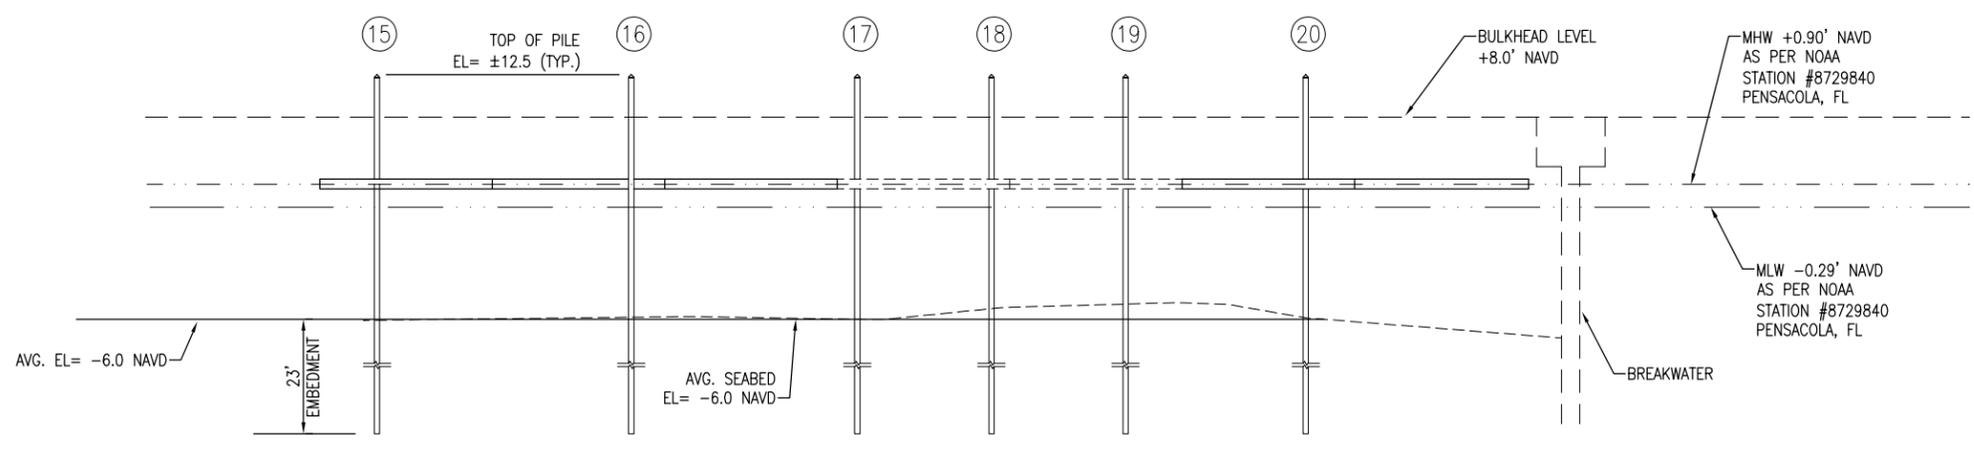PILE SUMMARY SECTION A

QUANTITY OF PILES = 6  
 TOP OF PILE EL = 12.5 NAVD (TYP.)  
 PSC DIMENSIONS = 14" x 14"  
 EMBEDMENT = 23.0'  
 PILE LENGTH = 42'

- LEGEND**
- NEW ALUMINUM FLOATING DOCKS
  - NEW ALUMINUM FIXED DOCKS
  - RE-USE DOCKS AND GANGWAY
  - NEW GANGWAY
  - PILE NUMBER
  - NEW ALUMINUM EXTERNAL PILE GUIDE 14"


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 FL Reg. Engineer #96469


**COMMUNITY MARITIME  
 PARK DAY USE  
 MARINA DESIGN  
 PROJECT**

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PROJECT NO: 29001.13  
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 DATE: JUNE 2021  
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PLAN




SECTION B

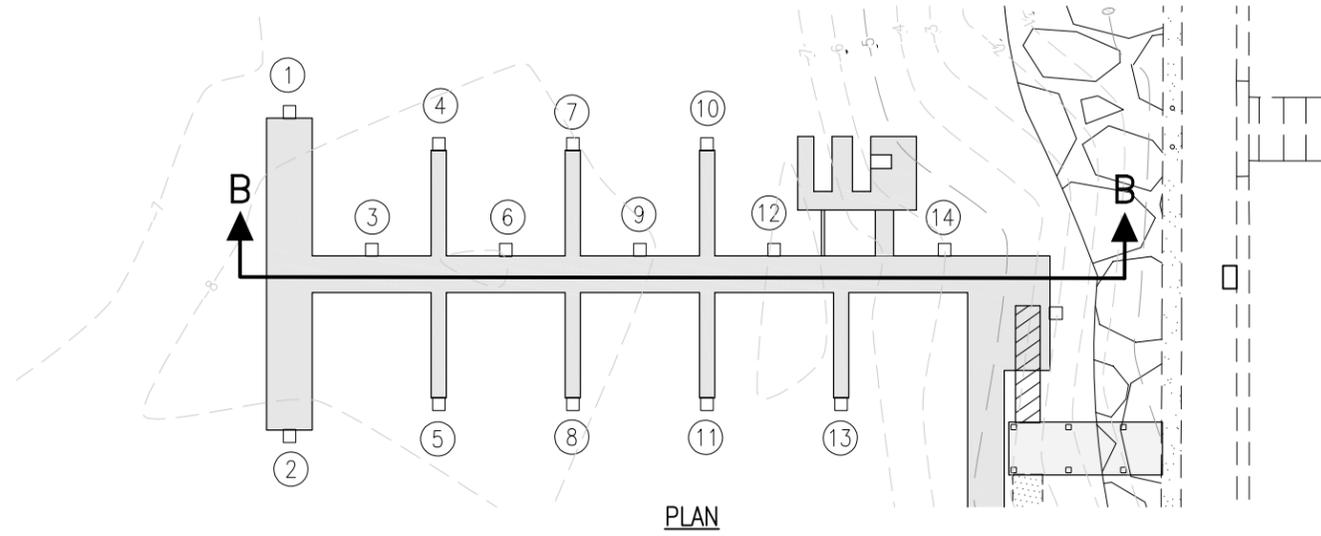PILE SUMMARY SECTION B

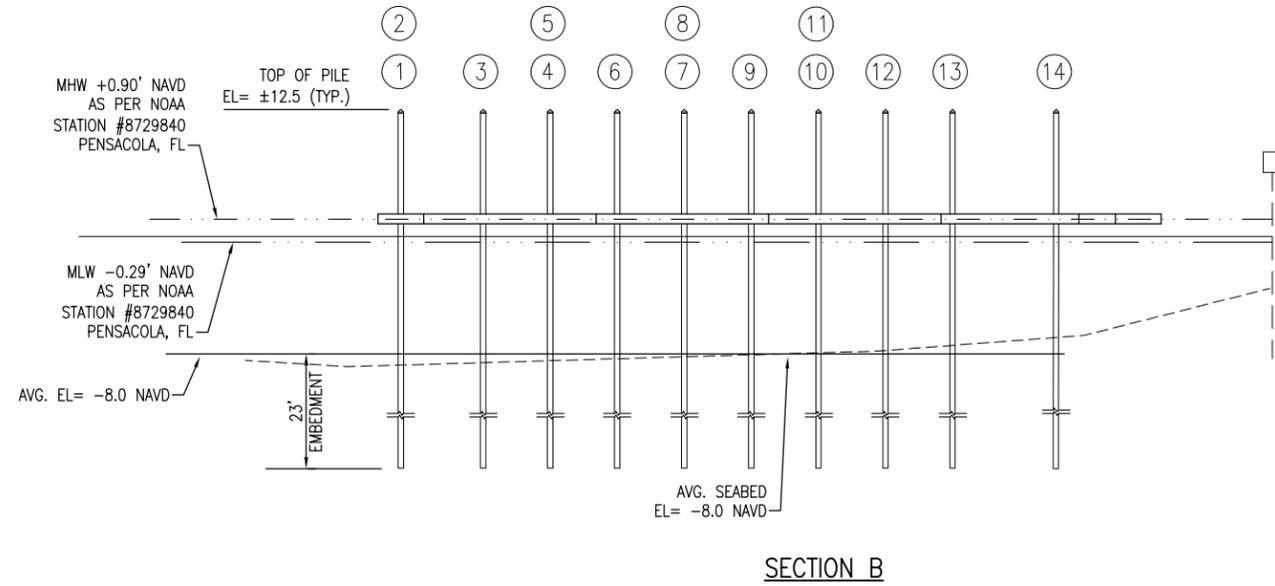QUANTITY OF PILES = 14  
 TOP OF PILE EL = 12.5 NAVD (TYP.)  
 PSC DIMENSIONS = 14" x 14"  
 EMBEDMENT = 23.0'  
 PILE LENGTH = 44'

- LEGEND
- NEW ALUMINUM FLOATING DOCKS
  - NEW ALUMINUM FIXED DOCKS
  - RE-USE DOCKS AND GANGWAY
  - NEW GANGWAY
  - PILE NUMBER
  - NEW ALUMINUM EXTERNAL PILE GUIDE 14"

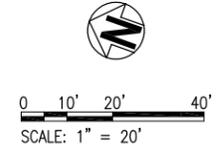

SECTION B

C-105




COMMUNITY MARITIME  
 PARK DAY USE  
 MARINA DESIGN  
 PROJECT

PROJECT NO:	NO.	DATE	APPR.	REVISION/ACTION TAKEN
29001.13				
DESIGNED BY: JJF				
DRAWN BY: RGG				
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DATE: JUNE 2021				

JASON J. FRICK D.E.  
 FL. Reg. Engineer #96469

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PILE SUMMARY SECTION C

QUANTITY OF PILES = 12  
 EXISTING PILES = 3  
 TOP OF PILE EL = 12.5 NAVD (TYP.)  
 PSC DIMENSIONS = 14" x 14"  
 EMBEDMENT = 23.0'  
 PILE LENGTH = 44'

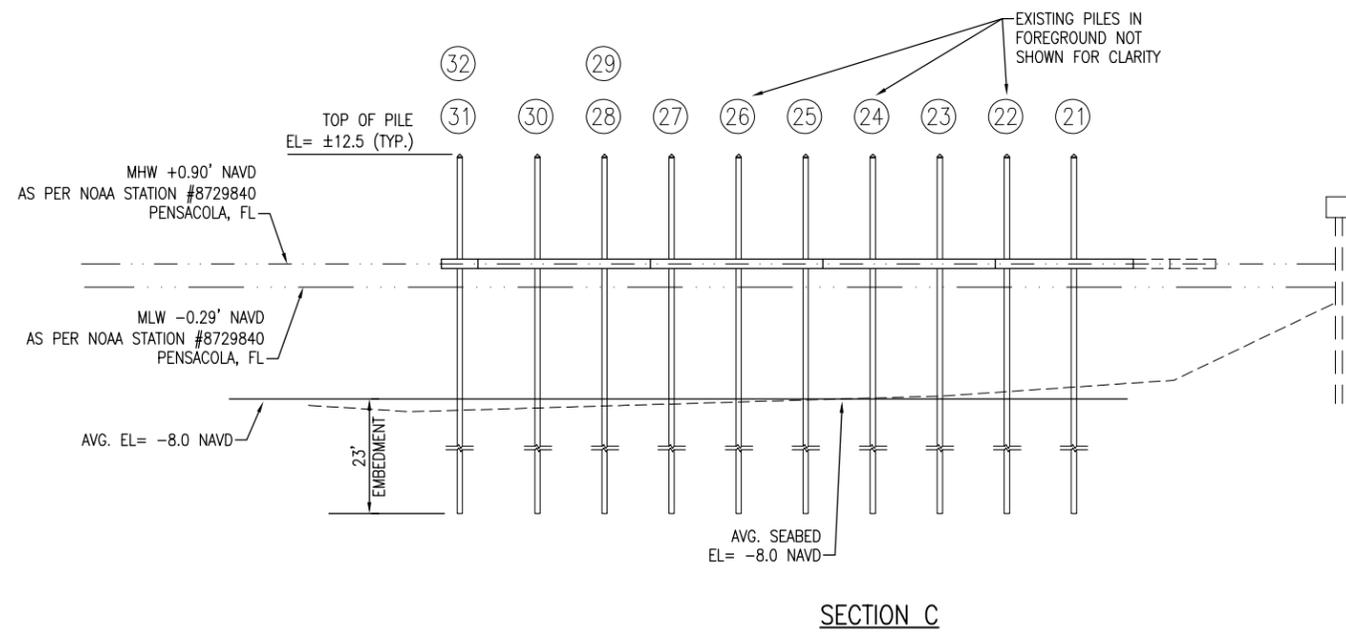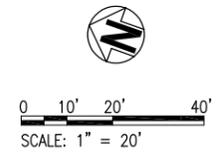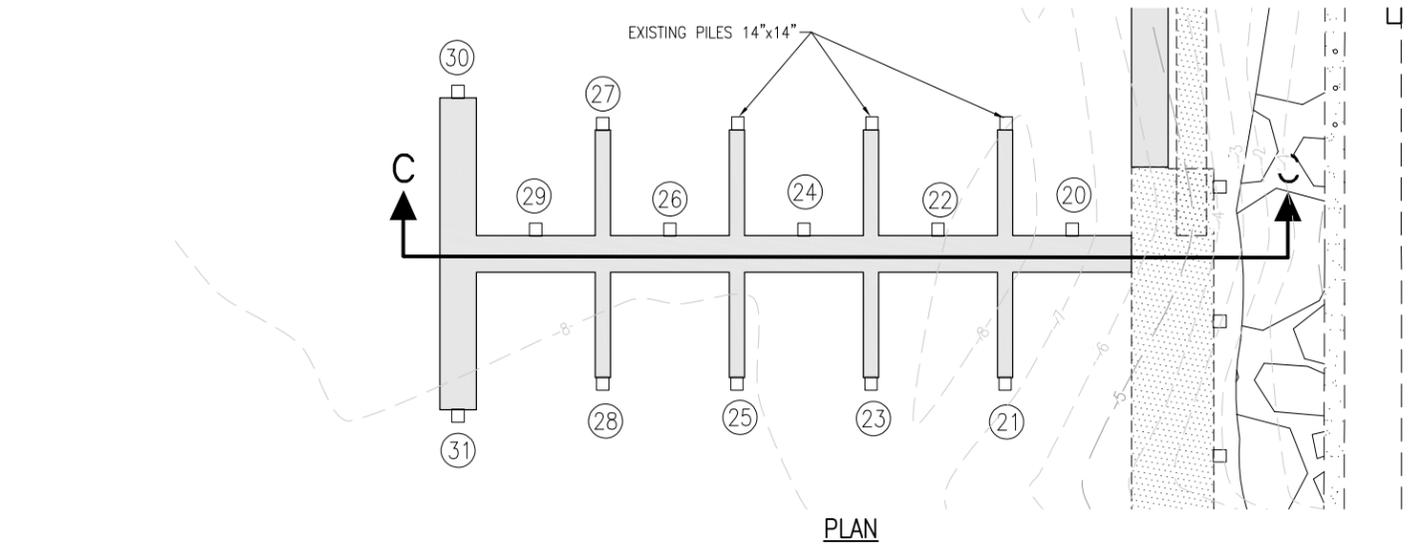- LEGEND
- NEW ALUMINUM FLOATING DOCKS
  - NEW ALUMINUM FIXED DOCKS
  - RE-USE DOCKS AND GANGWAY
  - NEW GANGWAY
  - PILE NUMBER
  - NEW ALUMINUM EXTERNAL PILE GUIDE 14"




<b>SECTION C</b>	PROJECT NO: 29001.13	DESIGNED BY: JJF	DRAWN BY: RGG	CHK'D BY: MDL	PROJ. MGR: MDL	DATE: JUNE 2021
	NO.	DATE	APPR.	REVISION/ACTION TAKEN	NOT RELEASED FOR CONSTRUCTION BY _____ DATE _____	
COMMUNITY MARITIME PARK DAY USE MARINA DESIGN PROJECT						
<b>BASKERVILLE-DONOVAN, INC.</b> ENGINEERING THE SOUTH SINCE 1927 <small>449 W. MAIN ST., PENSACOLA, FL 32502 (850)438-9861                  ENGINEERING BUSINESS: EB-0000340                  Pensacola - Panama City Beach - Tallahassee - Mobile</small>						
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C-106						



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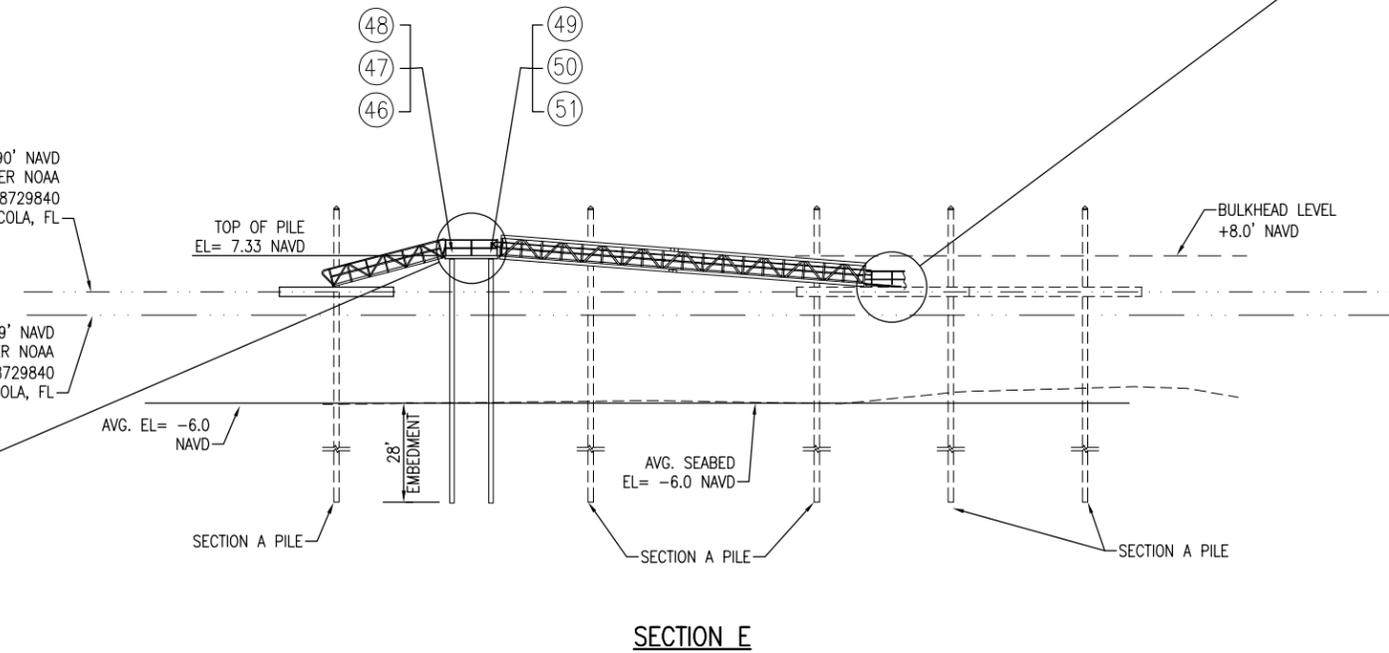


0 10' 20' 40'  
SCALE: 1" = 20'

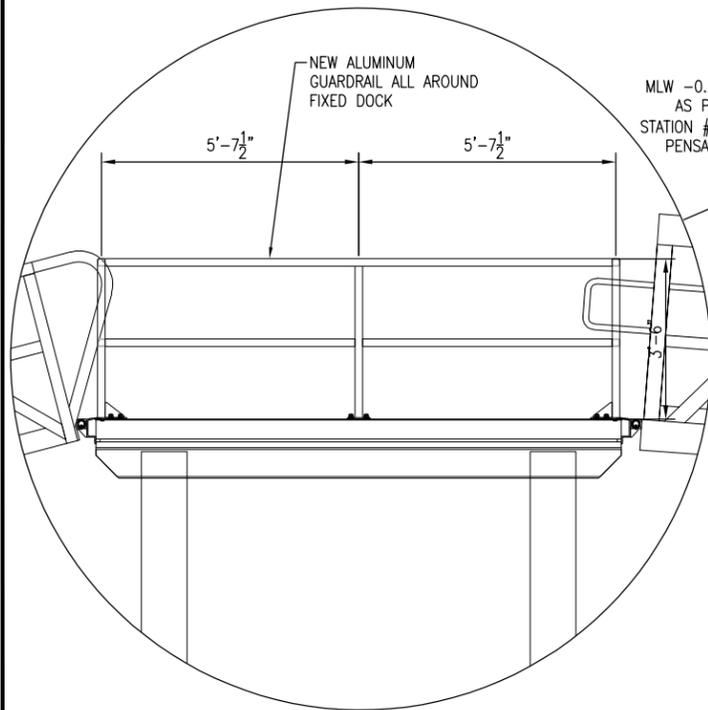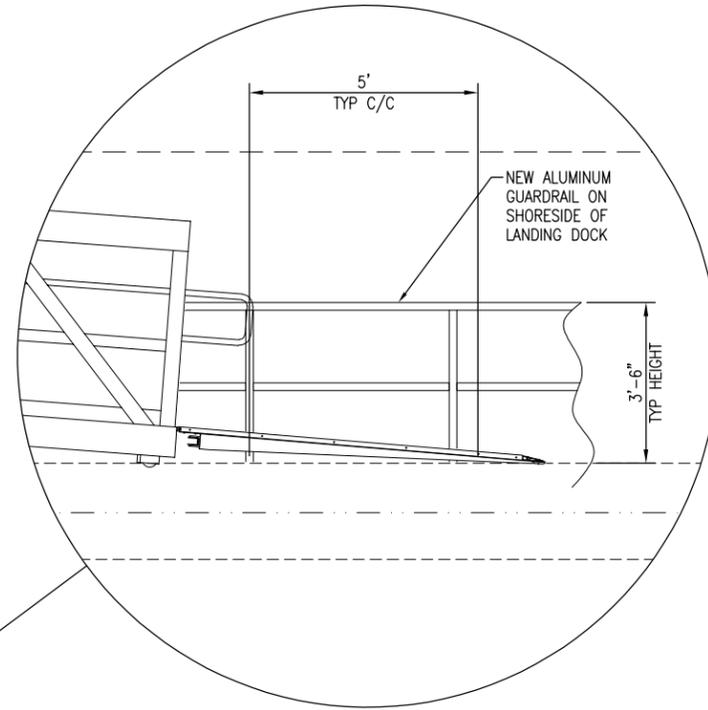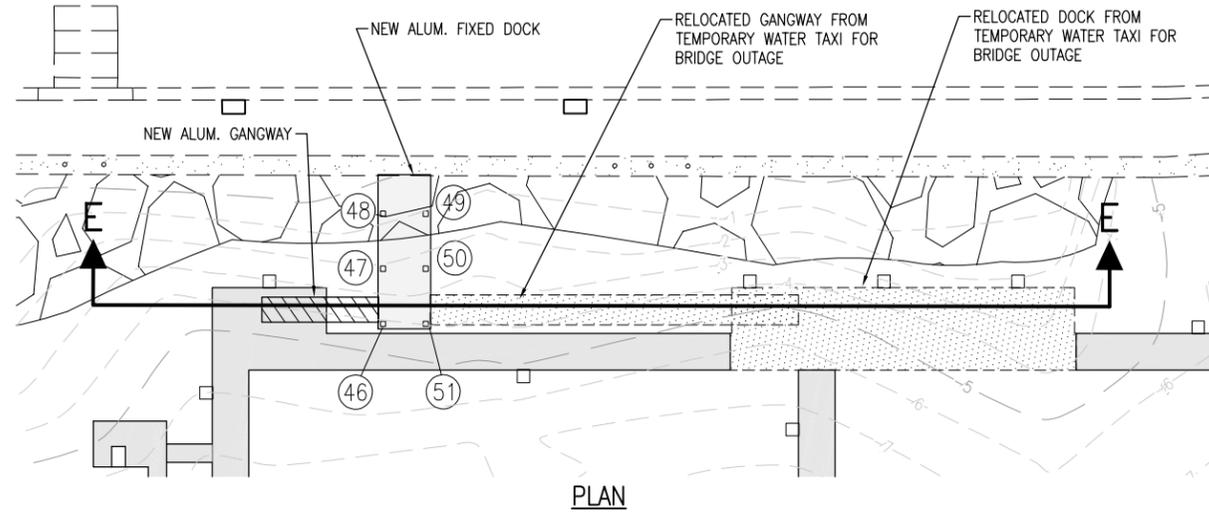

MHW +0.90' NAVD  
AS PER NOAA  
STATION #8729840  
PENSACOLA, FL

MLW -0.29' NAVD  
AS PER NOAA  
STATION #8729840  
PENSACOLA, FL



PILE SUMMARY SECTION E

QUANTITY OF PILES = 6  
TOP OF PILE EL = 7.33' NAVD  
PSC DIMENSIONS = 14" x 14"  
EMBEDMENT = 28'  
PILE LENGTH = 42'

LEGEND

- NEW ALUMINUM FLOATING DOCKS
- NEW ALUMINUM FIXED DOCKS
- RE-USE DOCKS AND GANGWAY
- NEW GANGWAY
- PILE NUMBER
- NEW ALUMINUM EXTERNAL PILE GUIDE 14"

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**COMMUNITY MARITIME  
PARK DAY USE  
MARINA DESIGN  
PROJECT**


PROJECT NO:	NO.	DATE	APPR.	REVISION/ACTION TAKEN
29001.13				
DESIGNED BY: JJF				
DRAWN BY: RGG				
CHK'D BY: MDL				
PROJ. MGR: MDL				
DATE: JUNE 2021				

**SECTION E**  
**C-108**

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**BASKERVILLE-DONOVAN, INC.**  
**ENGINEERING THE SOUTH SINCE 1927**  
 449 W. MAIN ST., PENSACOLA, FL 32502 (850)438-9861  
 ENGINEERING BUSINESS: EB-0000340  
 Pensacola - Panama City Beach - Tallahassee - Mobile  
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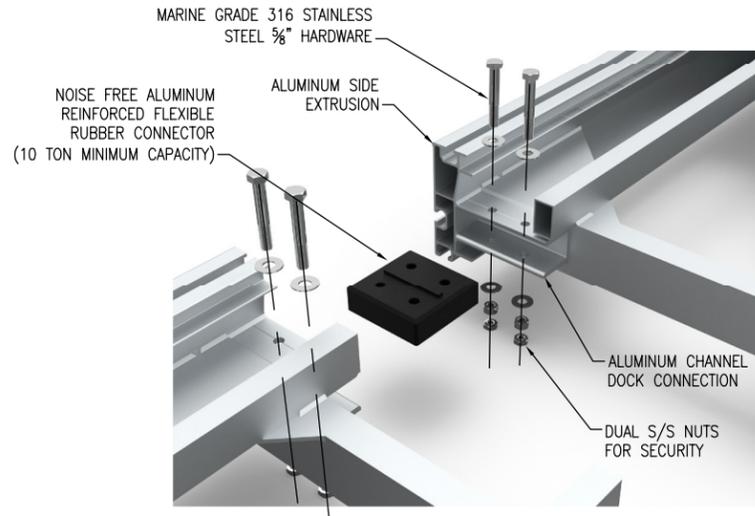
JOHN J. FRICK, D.E.  
 FL Reg. Engineer #96469

**COMMUNITY MARITIME**  
**PARK DAY USE**  
**MARINA DESIGN**  
**PROJECT**


PROJECT NO:	DESIGNED BY:	DRAWN BY:	CHK'D BY:	PROJ. MGR:	DATE:	NO.	DATE	APPR.	REVISION/ACTION TAKEN
29001.13	JJF		MOL		JUNE 2021				

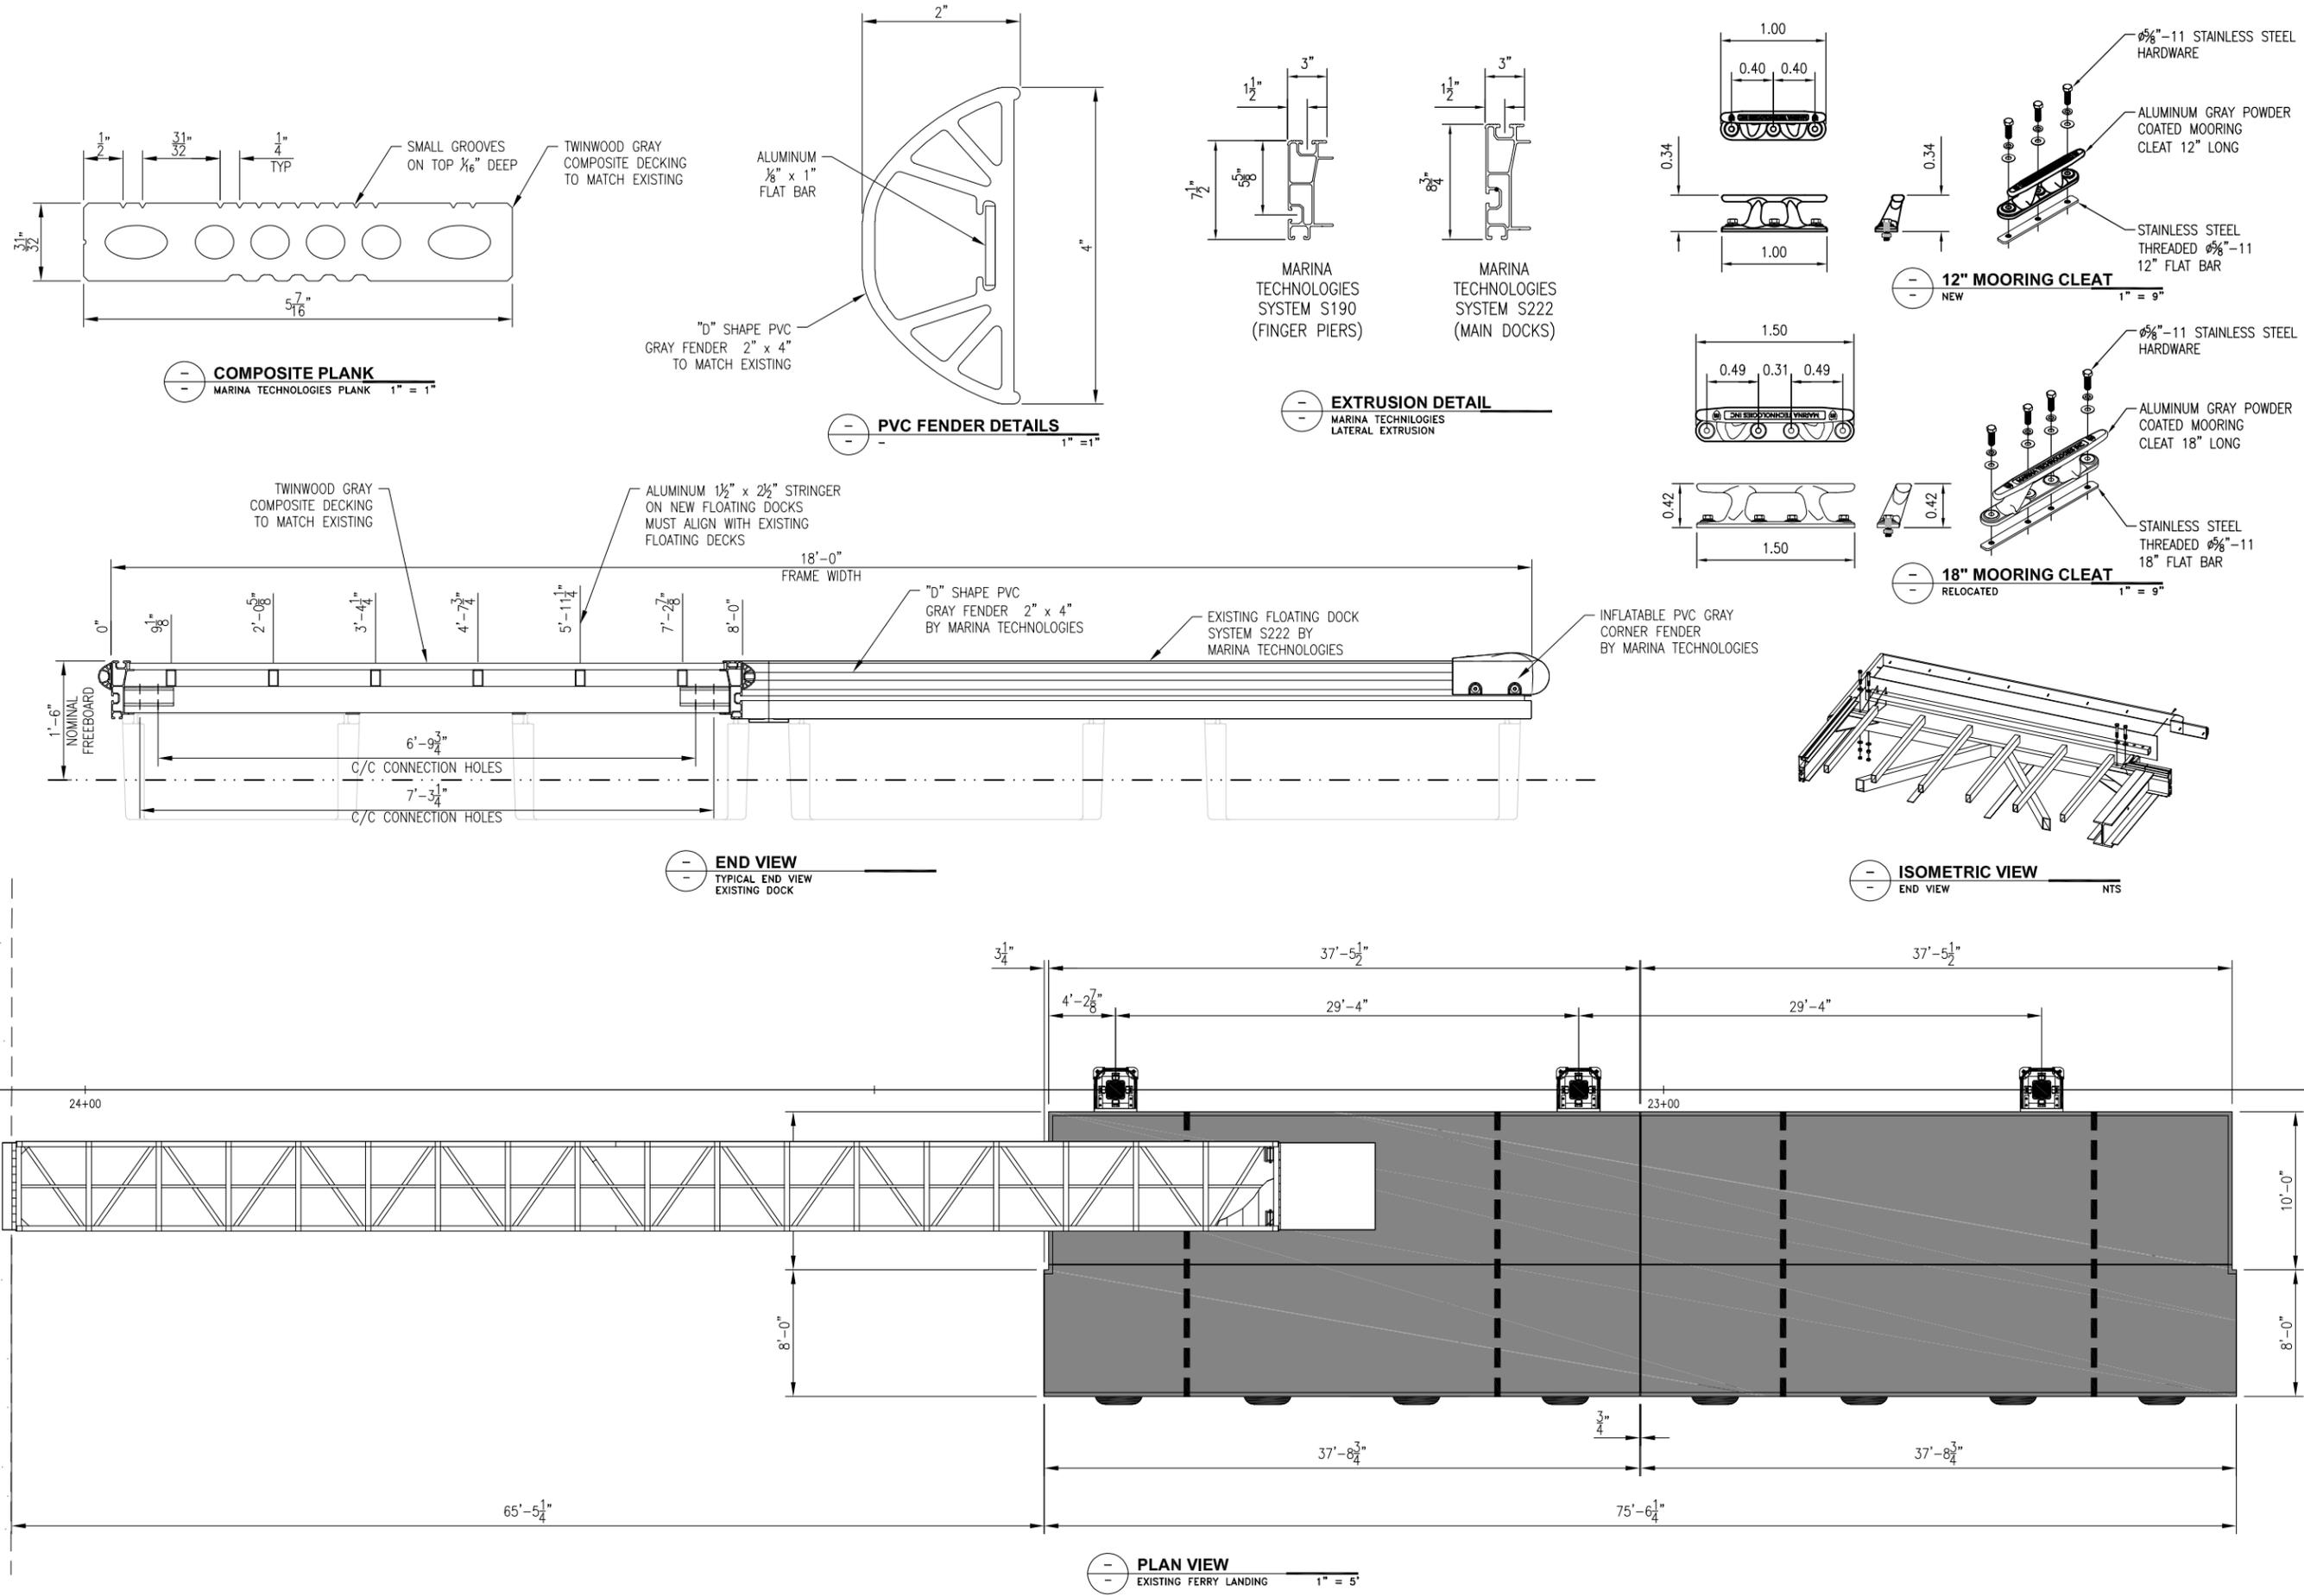**RELOCATION DETAILS**


**C-901**




**DOCK CONNECTOR**  
TYPICAL DOCK CONNECTION  
BY MARINA TECHNOLOGIES

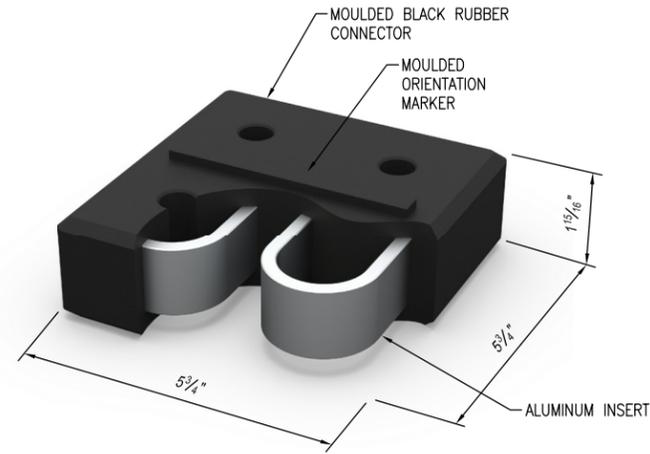



**REINFORCED RUBBER BLOCK**  
TYPICAL CONNECTOR DETAIL  
BY MARINA TECHNOLOGIES

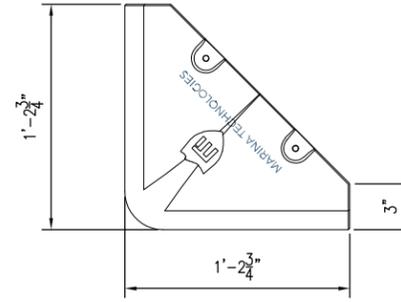


**DOCK CORNER FENDER**  
INFLATABLE PVC CORNER FENDER  
BY MARINA TECHNOLOGIES

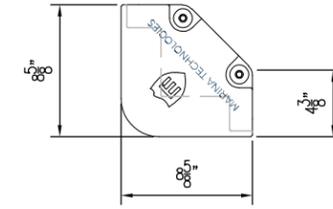



**FINGER CORNER FENDER**  
INFLATABLE PVC CORNER FENDER  
BY MARINA TECHNOLOGIES

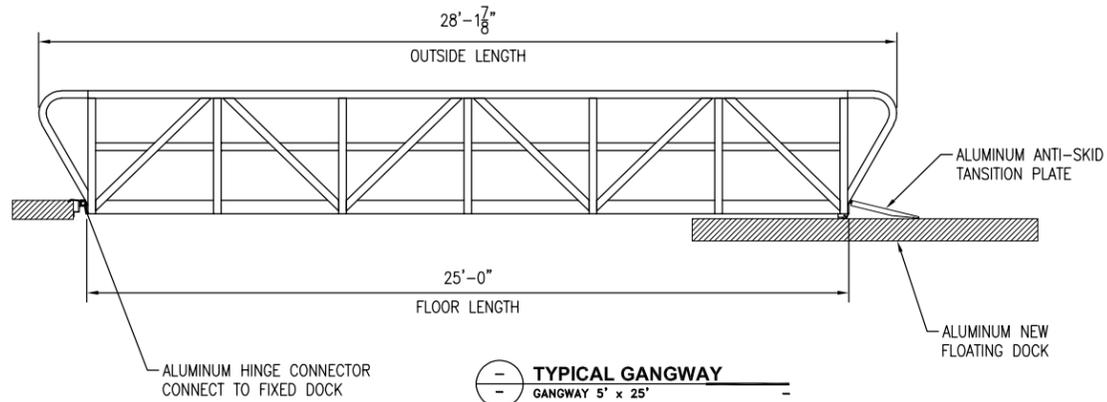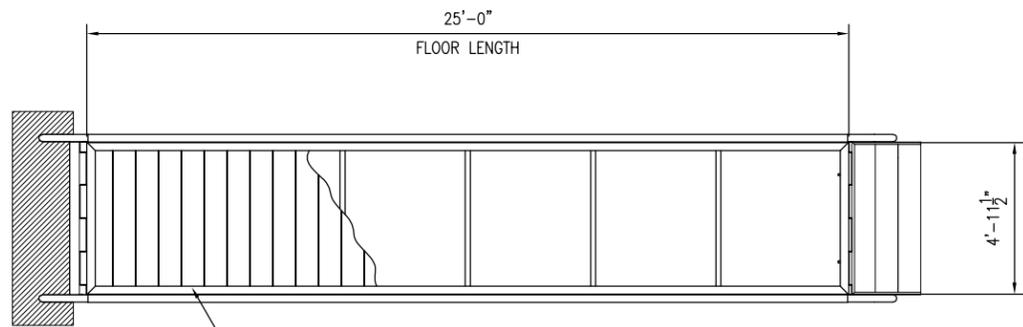

**TYPICAL GANGWAY**  
GANGWAY 5' x 25'

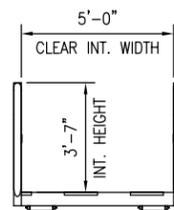

**EXTERNAL PILE GUIDE**  
DESIGN AS PER  
MARINA TECHNOLOGIES

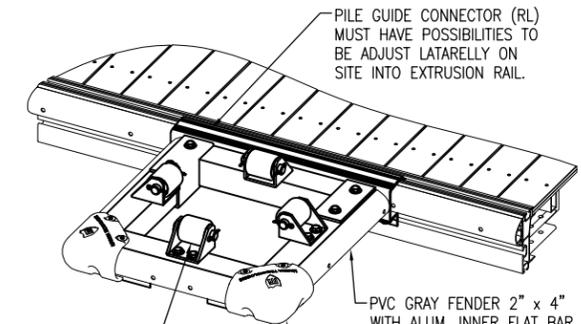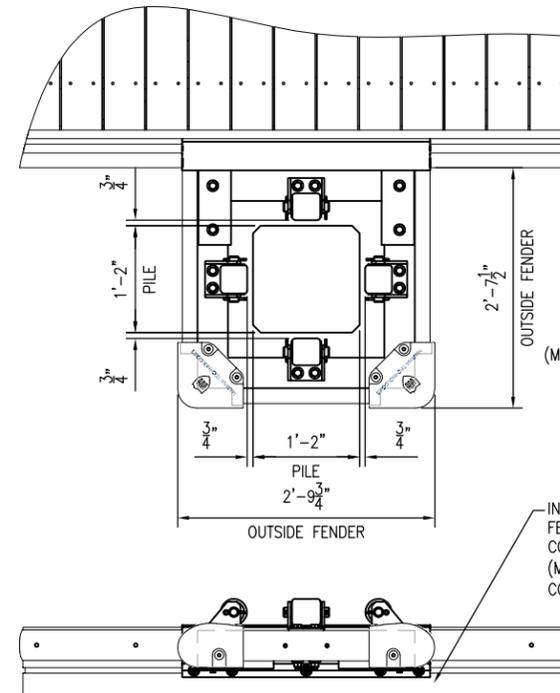

BLACK UHMW ROLLER  
Ø3 1/2" x 3 3/4" LONG  
(MUST BE REMOVABLE WITHOUT  
CHANGING PILE GUIDE)


INFLATABLE PVC CORNER  
FENDER ON EXPOSED CORNERS  
COLOR = GRAY  
(MUST MATCH MARINA TECHNOLOGIES  
CORNER FENDER ON PHASE 1)

INFLATABLE PVC CORNER  
FENDER ON EXPOSED CORNER  
COLOR = GRAY  
(MUST MATCH MARINA TECHNOLOGIES  
CORNER FENDER ON PHASE 1)





BLACK UHMW ROLLER  
Ø3 1/2" x 3 3/4" LONG  
(MUST BE REMOVABLE WITHOUT  
CHANGING PILE GUIDE)

NO.	DATE	APPR.	REVISION/ACTION TAKEN

E:\DWG\290 29001.13 Marina\C-902-903 Dock Detail.dwg, Jun 23, 2021 - 8:09:36AM, rgeiger

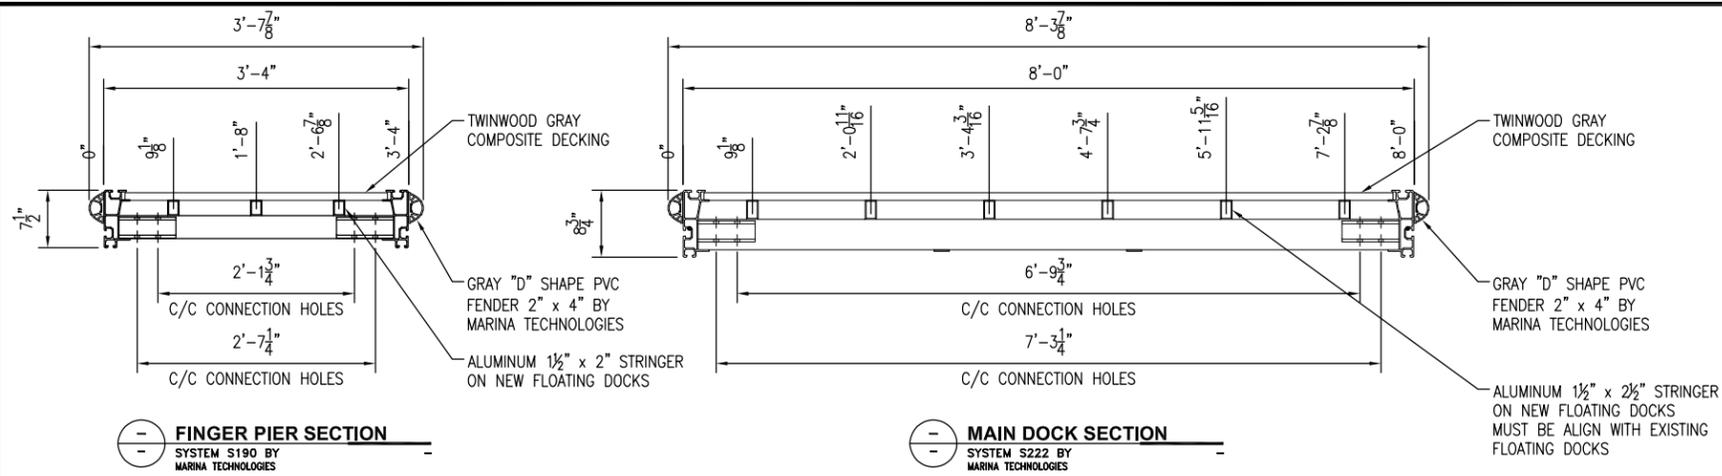

NOTE:  
FIXED ACCESS DOCK GUARDRAILS AND GANGWAYS ARE NOT SHOWN ON THIS DRAWING.

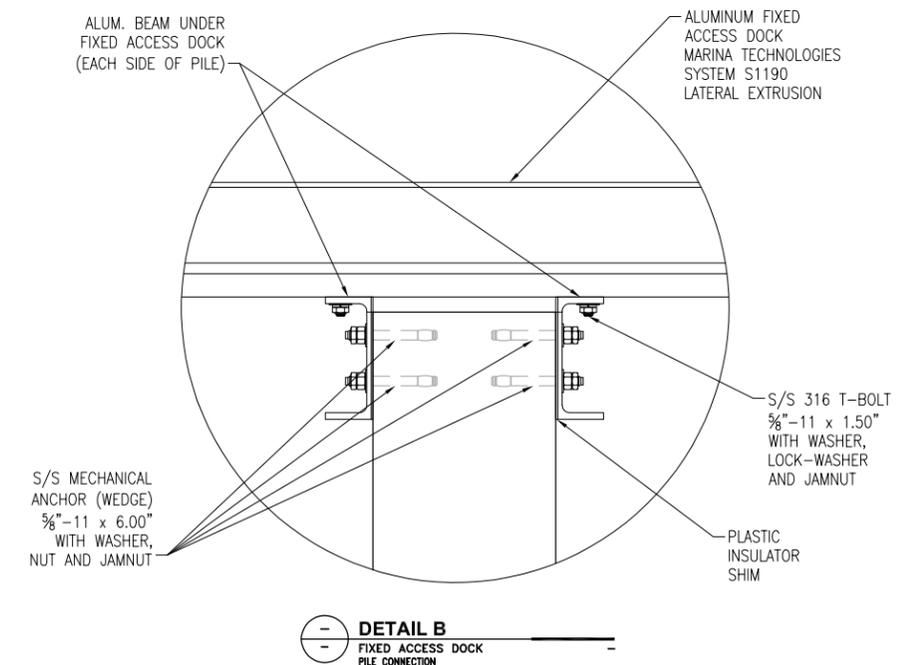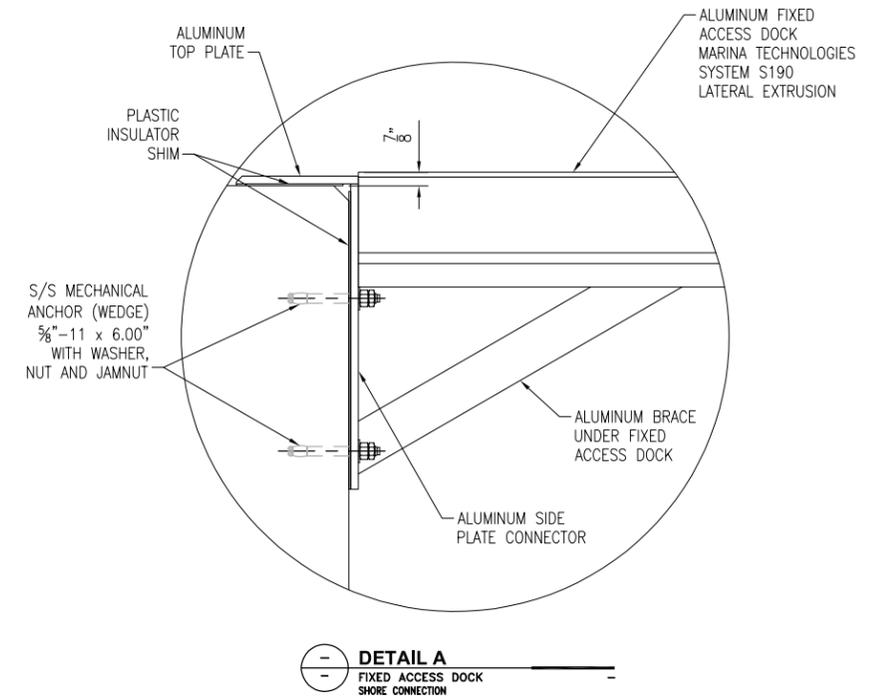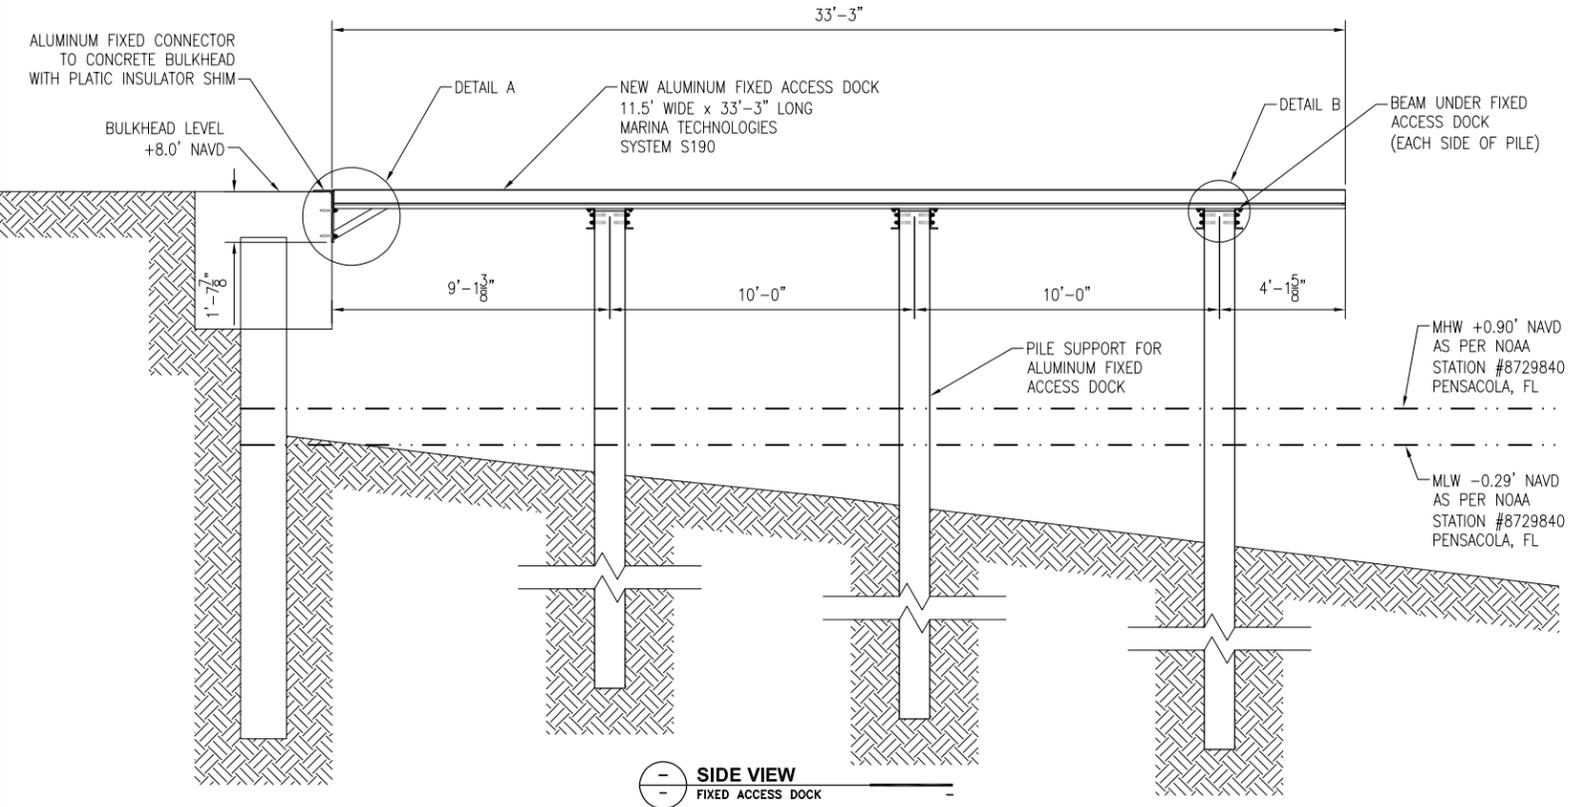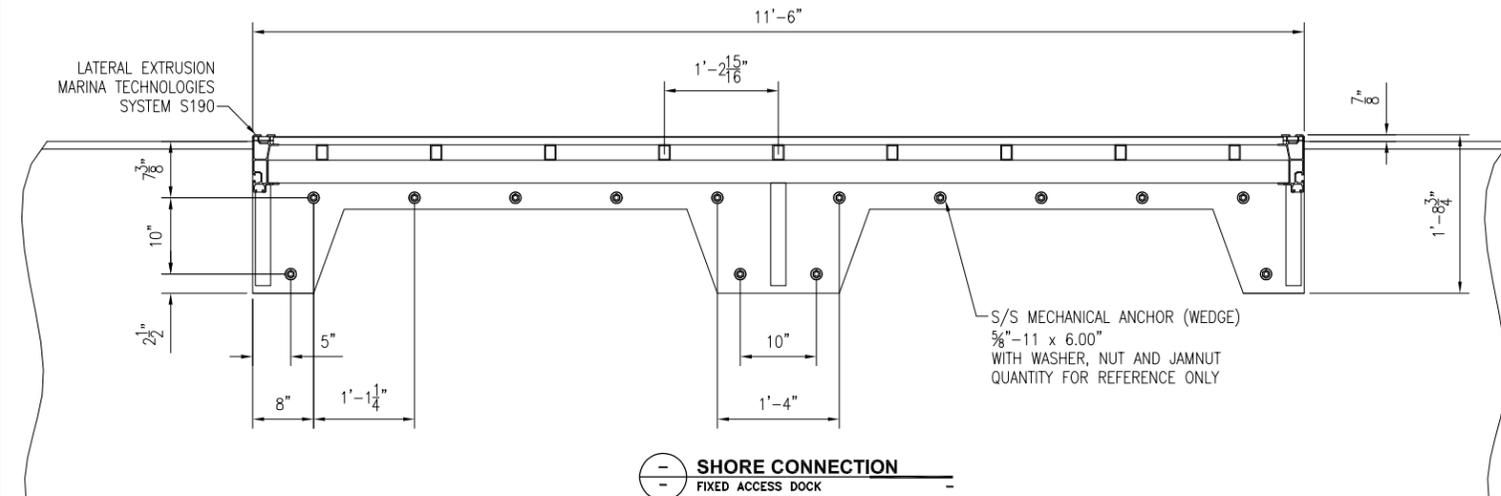

PROJECT NO:	NO.	DATE	APPR.	REVISION/ACTION TAKEN
29001.13				
DESIGNED BY: CB				
DRAWN BY: CB				
CHK'D BY: RM				
PROJ. MGR: MOL				
DATE: JUNE 2021				
				NOT RELEASED FOR CONSTRUCTION BY DATE