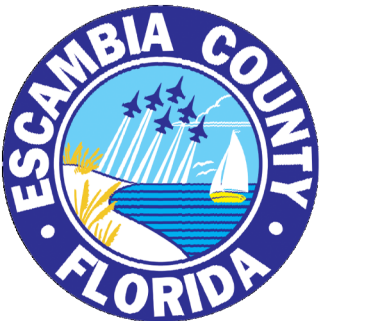


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**PENSACOLA**  
FLORIDA'S FIRST & FUTURE

HOLLICE T. WILLIAMS  
STORMWATER PARK  
1601 North Hayne Street  
Pensacola, FL 32503

DATE	DESCRIPTION
08/16/2021	30% DESIGN DEVELOPMENT
12/03/2021	60% DESIGN DEVELOPMENT


HDR Project Number: 10236372

**PRELIMINARY**  
NOT FOR CONSTRUCTION

Sheet Name  
**OVERALL  
SITE PLAN**

Scale  
1" = 120'-0"

Sheet Number  
**L-100**

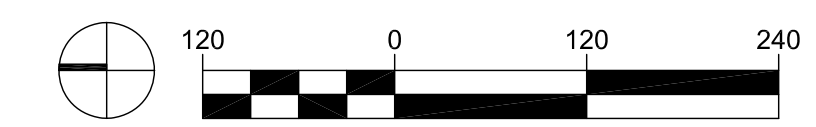

**CONSTRUCTION NOTES**

- CONTRACTOR SHALL PROTECT ALL ADJACENT LANDS FROM DAMAGE DURING DEMOLITION WORK. ANY OFF-SITE AREAS DISTURBED SHALL BE RETURNED TO A CONDITION EQUAL TO OR BETTER THAN THE EXISTING CONDITION.
- DIRT FOR FILL SHALL BE CLEAN, COHESIVE CLAY OR SANDY CLAY, FREE OF DEBRIS, ORGANICS, DELETERIOUS MATERIAL AND ROCKS GREATER THAN 3" DIA.
- MAX CUT OR FILL SLOPES SHALL BE 2:1 (H:V).
- CONTRACTOR TO VERIFY ELEVATIONS OF ALL TIE-IN POINTS FOR INSTALLATION OF UTILITIES, CURB AND GUTTER, AND PAVING.
- TRENCH BACKFILL MATERIAL SHALL BE COMPACTED TO NOT LESS THAN 95% OF THE OPTIMUM COMPACTION FOR ANY SOIL CLASSIFICATIONS AS DETERMINED BY THE STANDARD PROCTOR TEST, AASHTO T-180
- METHOD 'A'. BACKFILL MATERIAL SHALL BE CLEAN AND FREE OF ROOTS, ROCKS, OR DELETERIOUS MATTER. CONTRACTOR SHALL CORRECT ANY DAMAGE TO CURBING OR PAVING CAUSED BY TRENCH SETTLEMENT WITHIN 12 MONTHS OF PROJECT ACCEPTANCE.
- PAVEMENT DESIGN FOR ROADWAY/PARKING AREAS INCLUDING OPTIONAL BASE GROUP AND PAVEMENT SELECTION SHALL CONFORM WITH THE CURRENT FDOT STANDARD PLANS AND SPECIFICATIONS FOR ROAD AND BRIDGE CONSTRUCTION UNLESS OTHERWISE NOTED IN THE PLANS.
- ALL FILL AREAS MUST BE COMPACTED TO A MINIMUM 95% STANDARD PROCTOR. A REPORT FROM THE GEOTECHNICAL ENGINEER MAY BE REQUIRED BY THE CONSTRUCTION INSPECTOR FOR ALL FILL AREAS WITHIN THE RIGHT-OF-WAY.
- IF UTILITIES ARE TO REMAIN AND HAVE BEEN LEFT ACTIVE, THE CONTRACTOR SHALL CAREFULLY PROTECT THEM AND IS RESPONSIBLE FOR RESTORING THEM TO THEIR PREVIOUS CONDITION OR BETTER IF DAMAGED.
- THE CONTRACTOR SHALL LEAVE THE SITE IN A CLEAN AND NEAT CONDITION. ALL DEBRIS, REMOVED VEGETATION, LUMBER, CONCRETE, ETC SHALL BE PROPERLY DISPOSED OF OFF-SITE.











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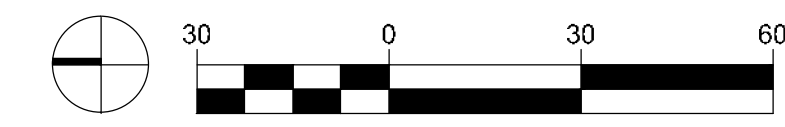
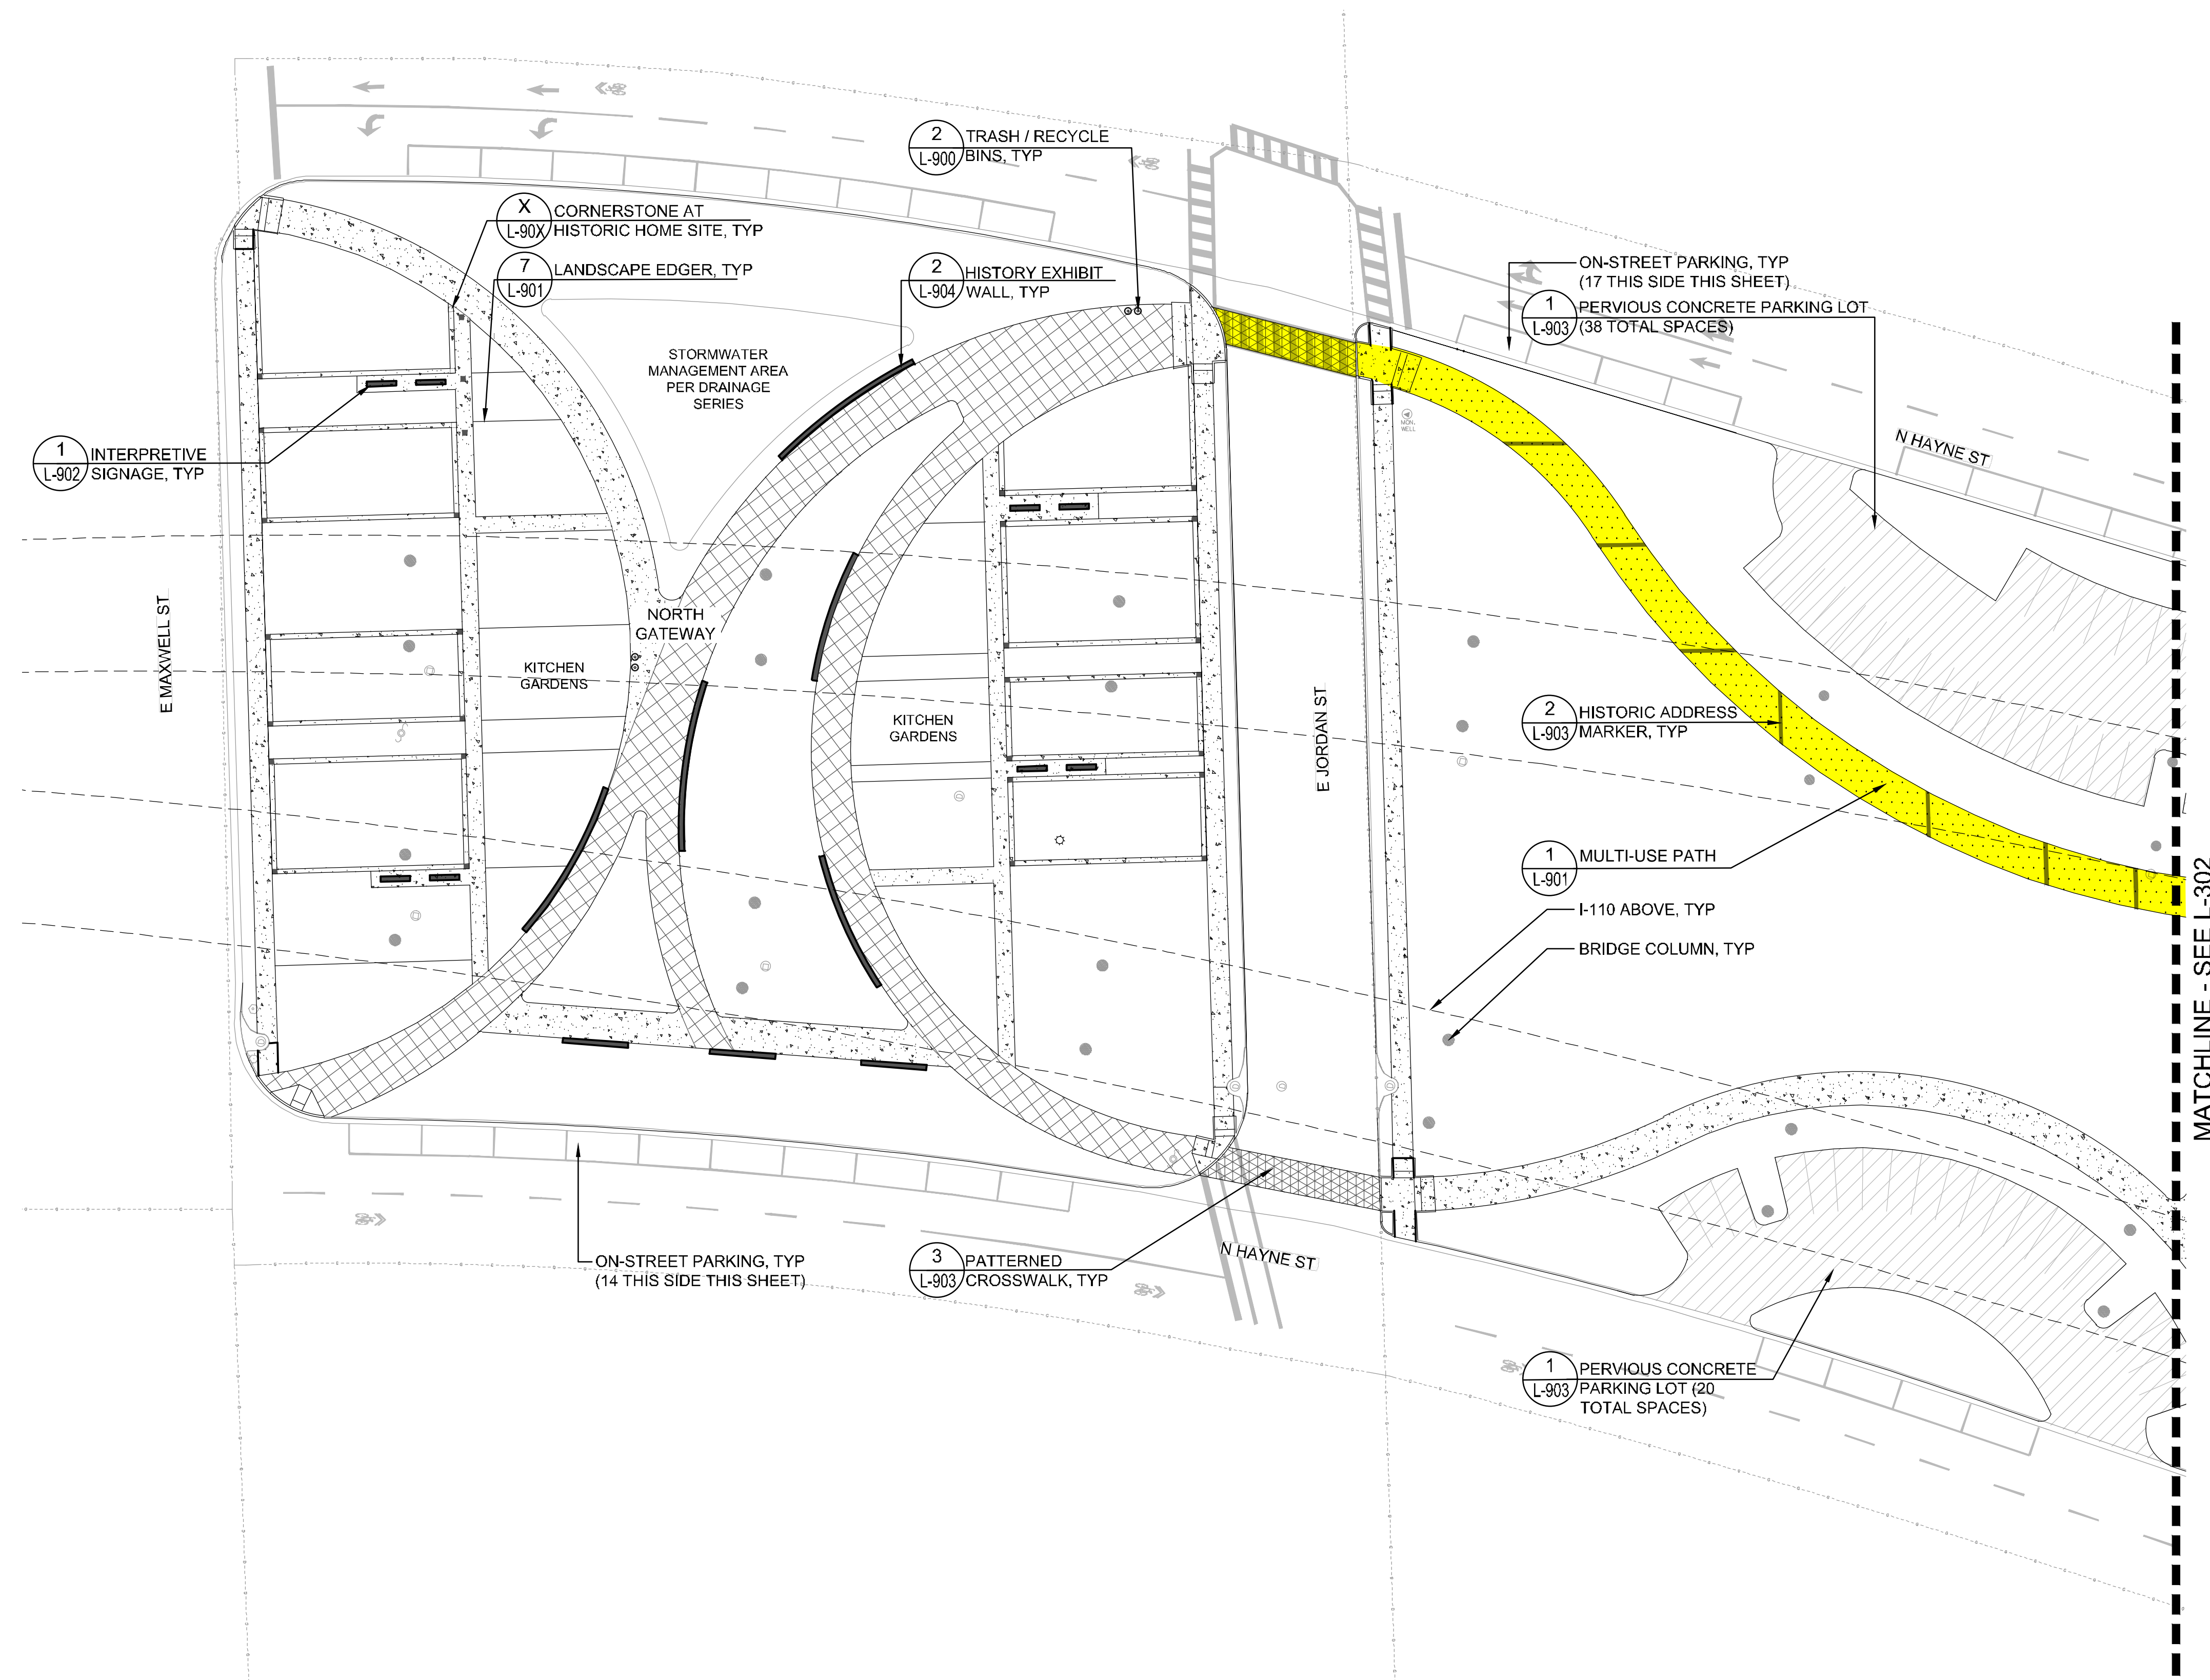
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**LAYOUT AND  
STAKING PLAN**

Scale  
1" = 30'-0"


Sheet Number  
**L-301**

LAYOUT & MATERIALS KEY

- CONCRETE TYPE 1
- CONCRETE TYPE 2
- CONCRETE TYPE 3
- CONCRETE TYPE 4
- PEDESTRIAN PAVERS
- VEHICULAR PAVERS
- GRAVEL
- PERVIOUS CONCRETE
- CROSSWALK TREATMENT
- RESILIENT SURFACING
- SYNTHETIC TURF
- SPORTS SAND
- FLOATING PATHWAY
- ASPHALT PAVING
- PICNIC TABLE
- SITE BENCH
- TRASH / RECYCLE BINS
- BICYCLE RACKS



KEY PLAN

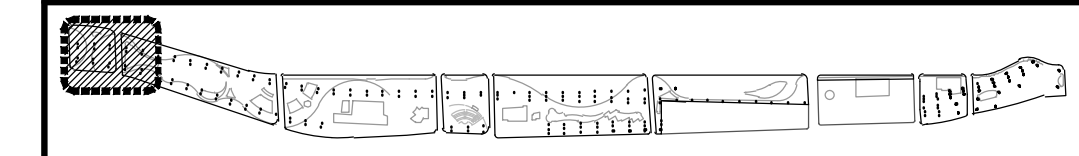










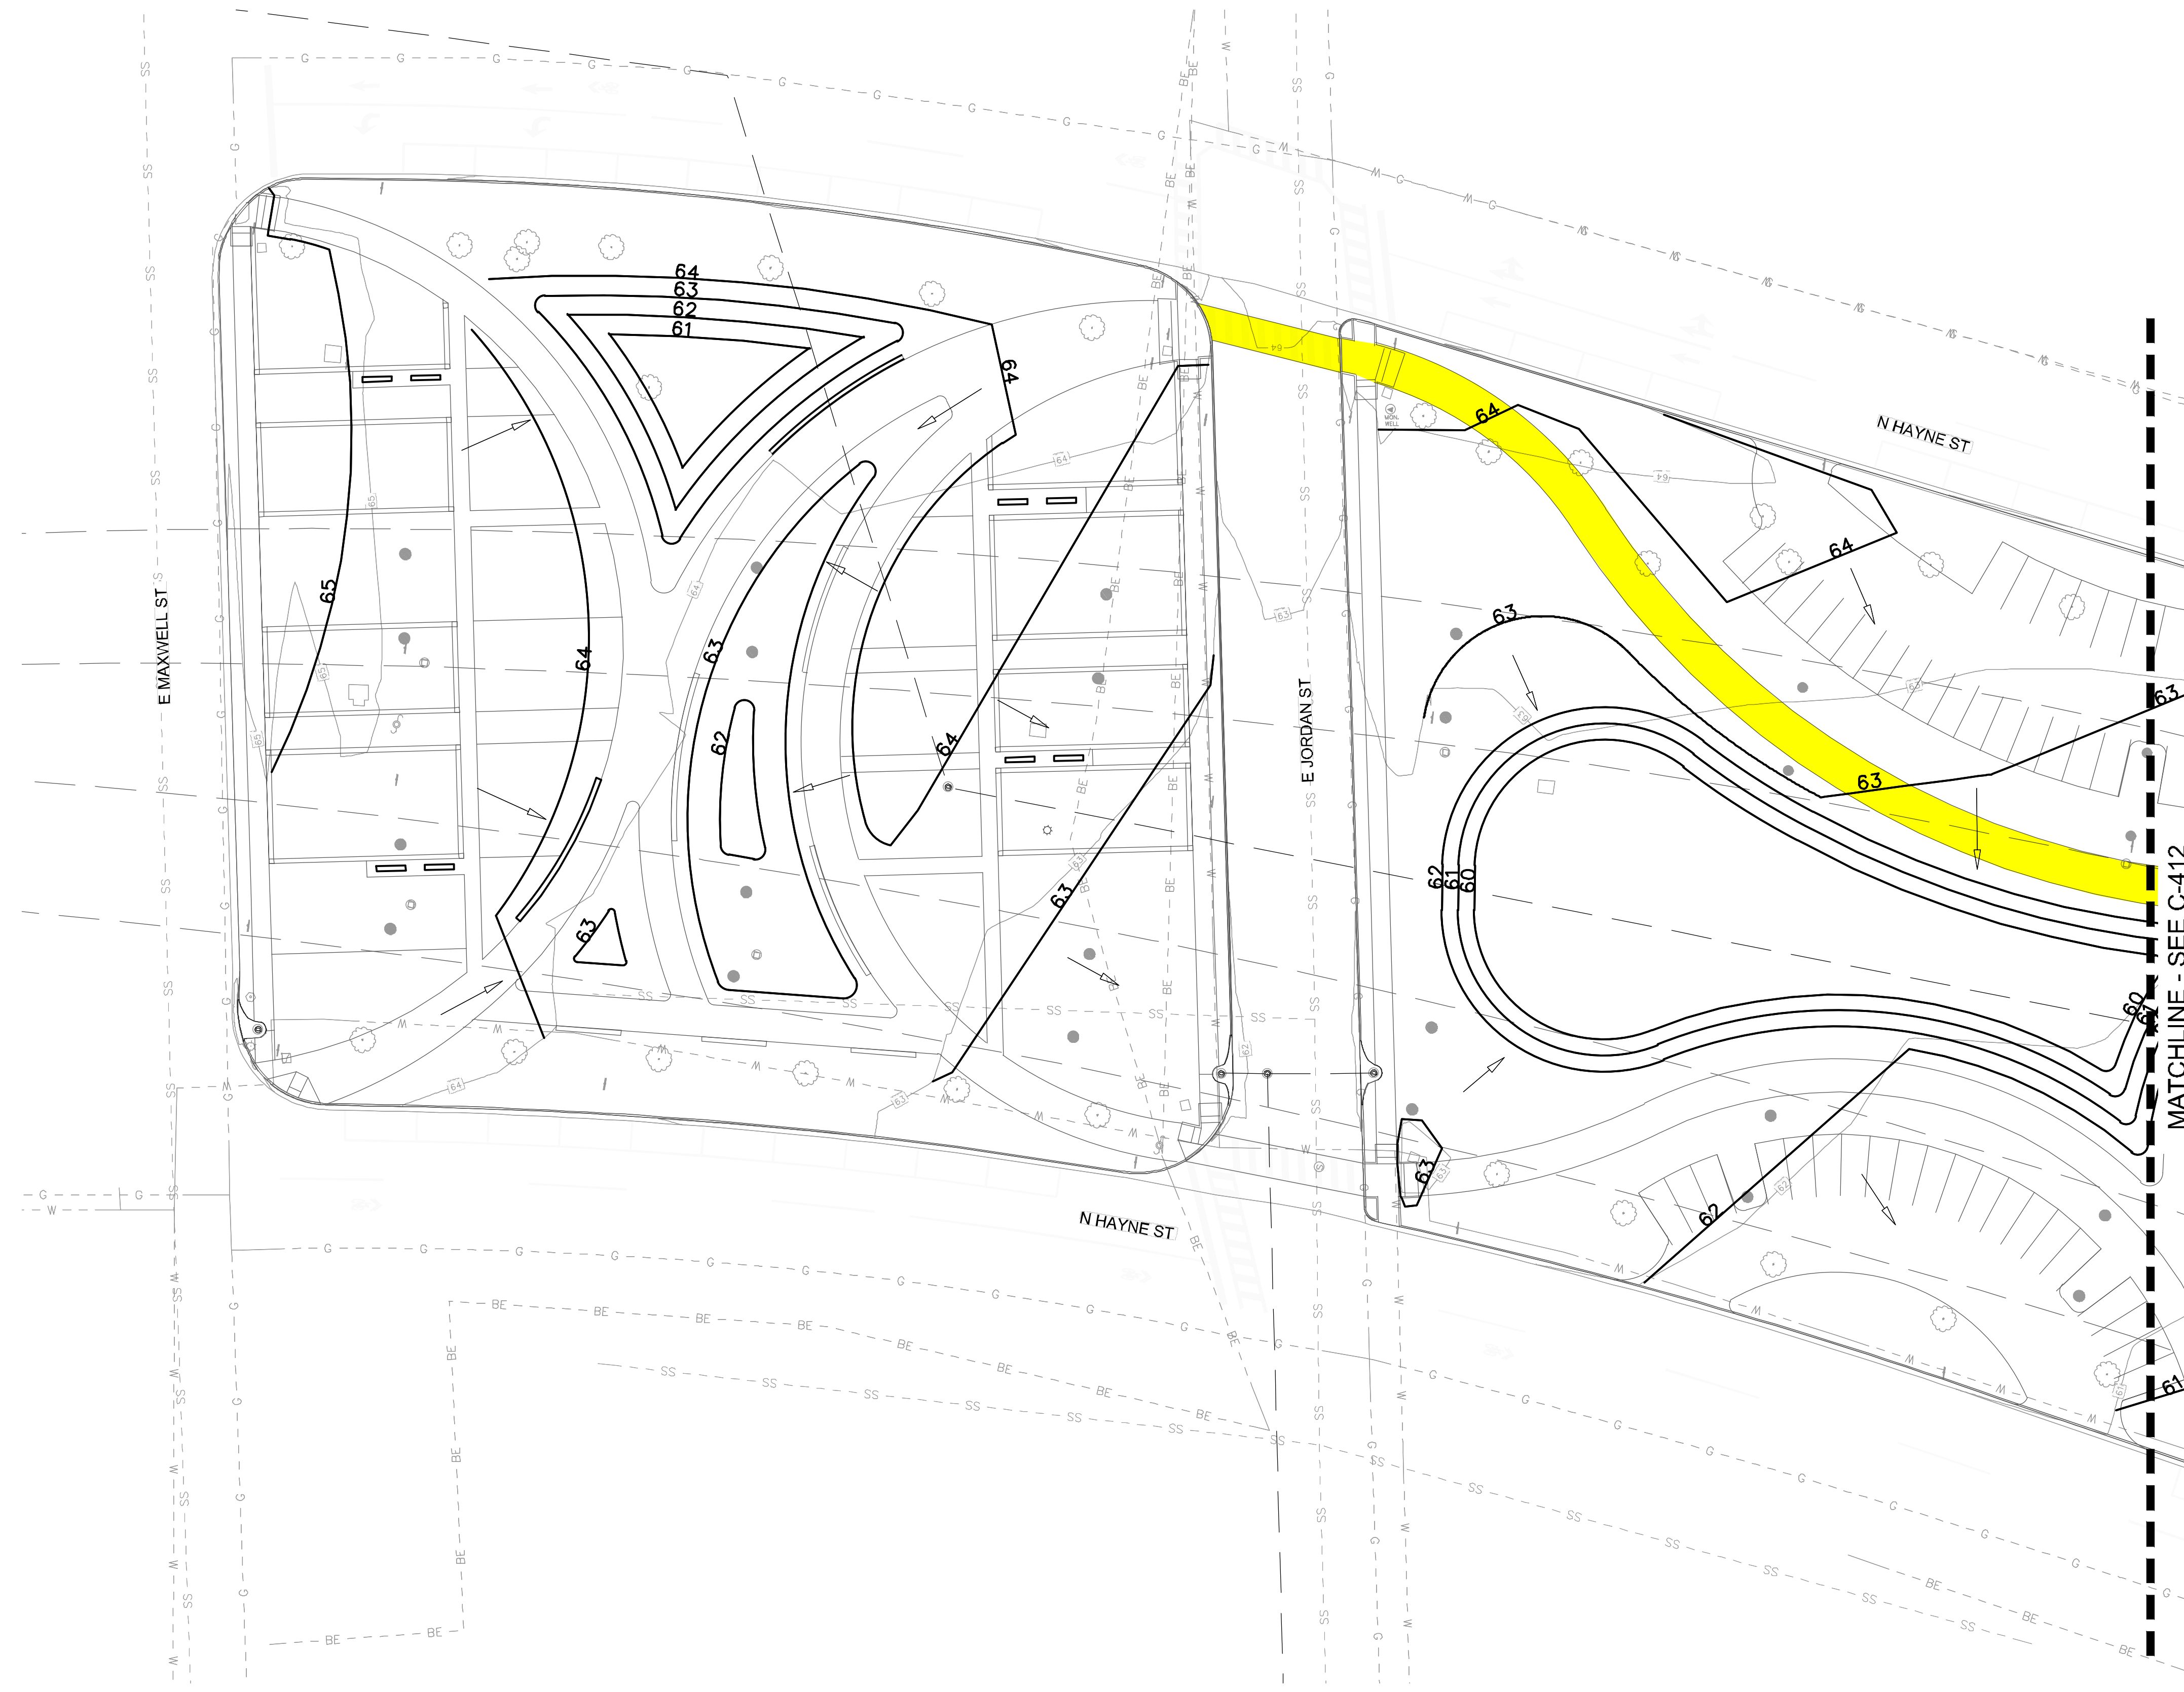

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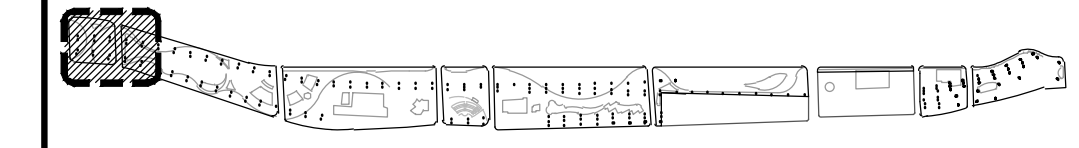
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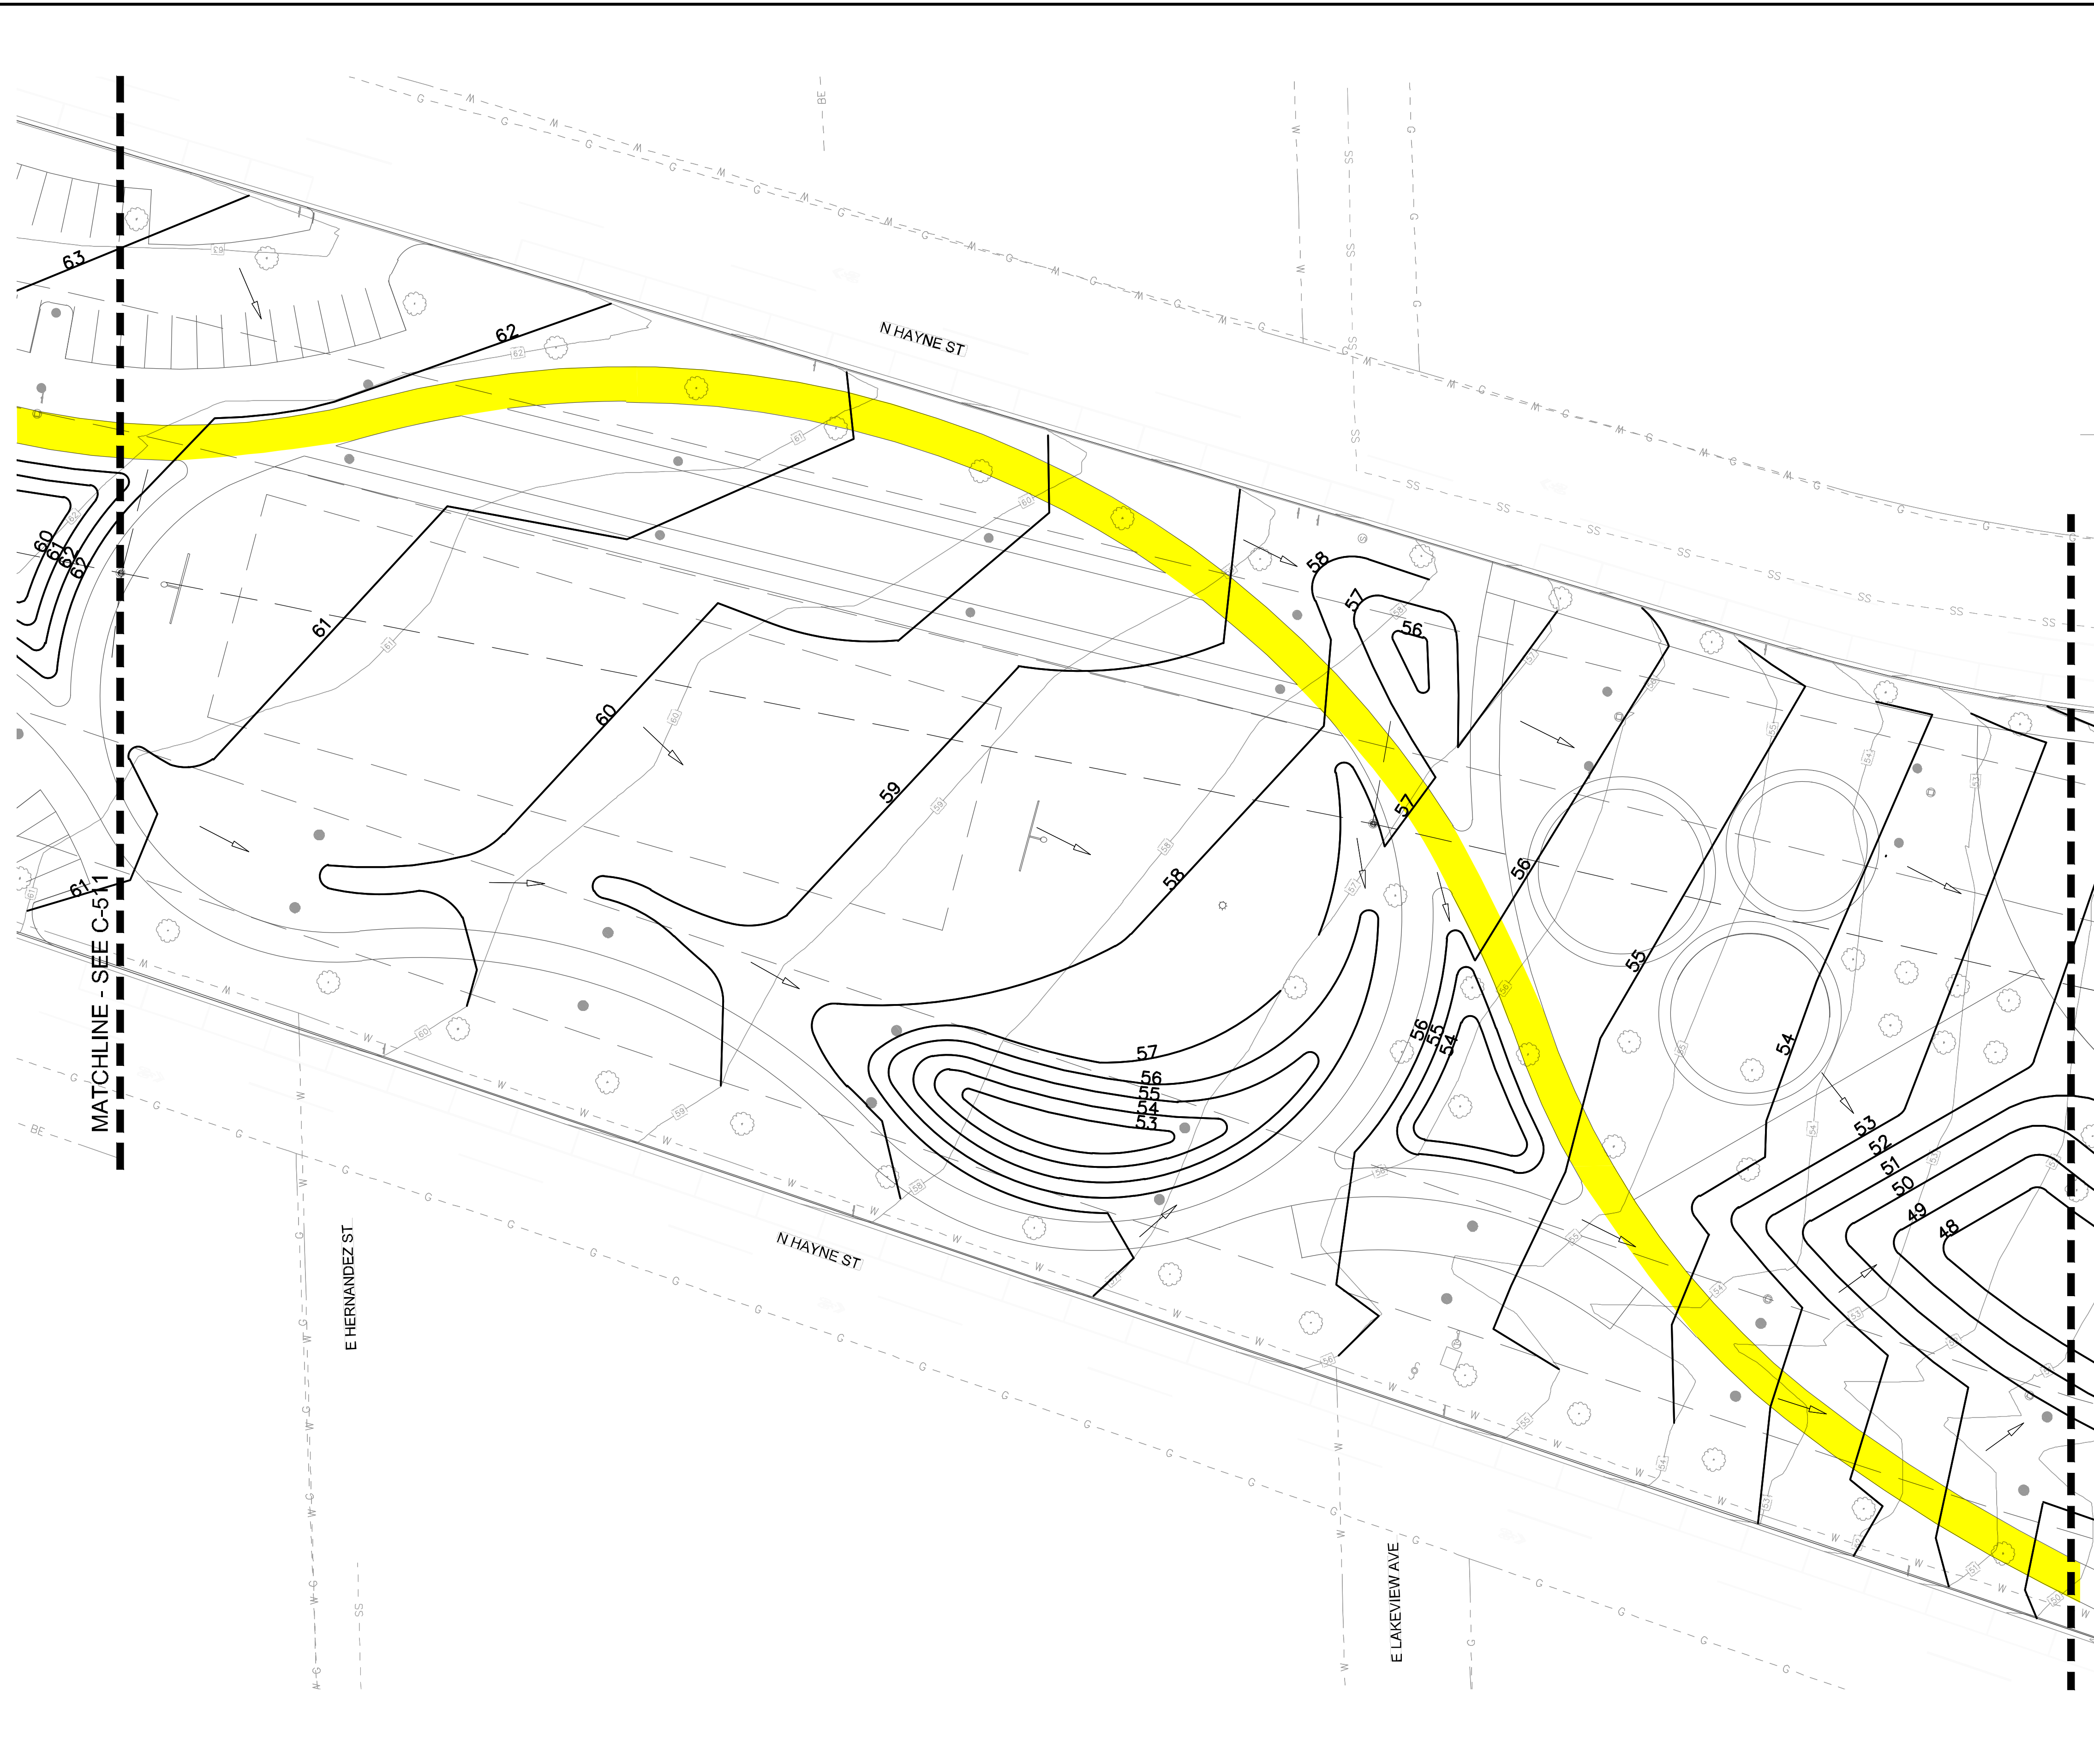
Sheet Name  
**GRADING PLAN**

Scale  
1" = 30'-0"

Sheet Number  
**C-411**

KEY PLAN





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Sheet Name  
**GRADING PLAN**

Scale  
1" = 30'-0"

Sheet Number  
**C-412**

KEY PLAN

