APPLICATION TO:

ARCHITECTURAL REVIEW BOARD


CITY OF PENSACOLA


P. O. BOX 12910

PENSACOLA, FL 32521

| DATE OF APPLICATION: 7.29 | .2022 | |
|--------------------------------------------------------------------------------------------------------------------------------------------------------------------------------------------------------------------------------------------------------------------------------------|------------------------------------------------------------------------------------------------------------|----------------------------------------|
| ADDRESS OF PROJECT: 1415 Barcelona Street Pensacola | | |
| Application is hereby made for project as o | described herein: | |
| Replacement of storm damaged metal pergo | la structure on rear side of re | sidence. |
| Replace with white aluminum extrusion p | ergola system custom eng | ineered to meet |
| drainage requirements of property; wind load | s based on residential structu | ure and Miami Dade |
| codes. Maintain design uniformity with origin | al pergola structure in color; | profile to meet |
| approved historical preservation of property | | |
| | | |
| | | |
| APPLICANT IS HEREBY NOTIFIED TO AGENT ATTEND THE MEETING. The City of Pensacola adheres to the America modifications for access to City Services, profurther information. Requests must be made a allow the City time to provide the requested so NAME & ADDRESS OF PETITIONER: (1) | ns with Disabilities Act and vergrams, and activities. Please at least 48 hours in advance of the ervices. | will make reasonable call 435-1600 for |
| McNeill Palm Contracting LLC | 850 865 1943 | |
| NAME | TELEPHONE | , # |
| 1191 Eglin Parkway Suite C ADDRESS | | |
| Shalimar | Florida | 32579 |
| CITY | STATE | ZIP CODE |
| Cynthia L Miller Project Manager | 2.3.22 | |
| SIGNATURE | DATE | |

Additional engineered drawings on file with Planning Services Staff. - GH

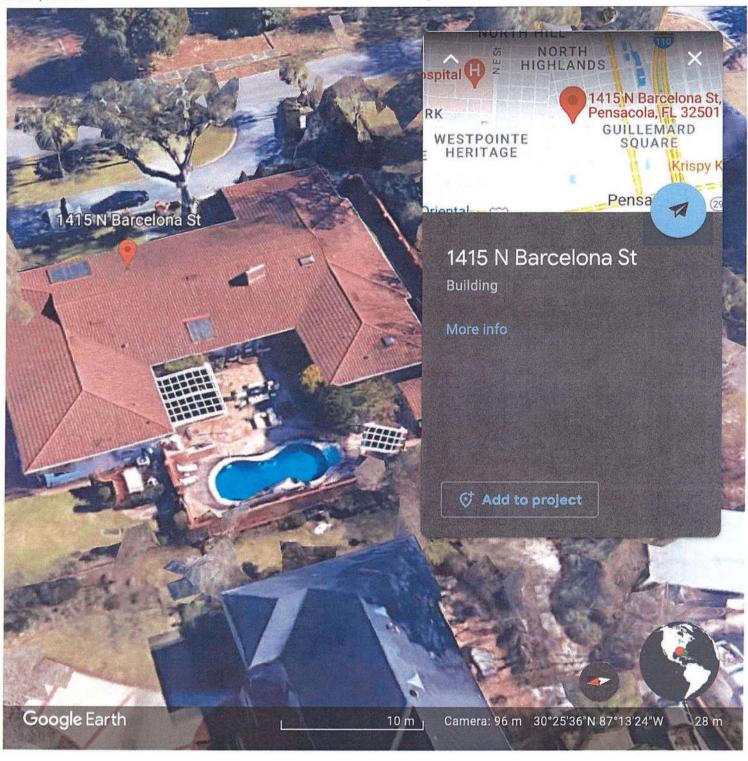

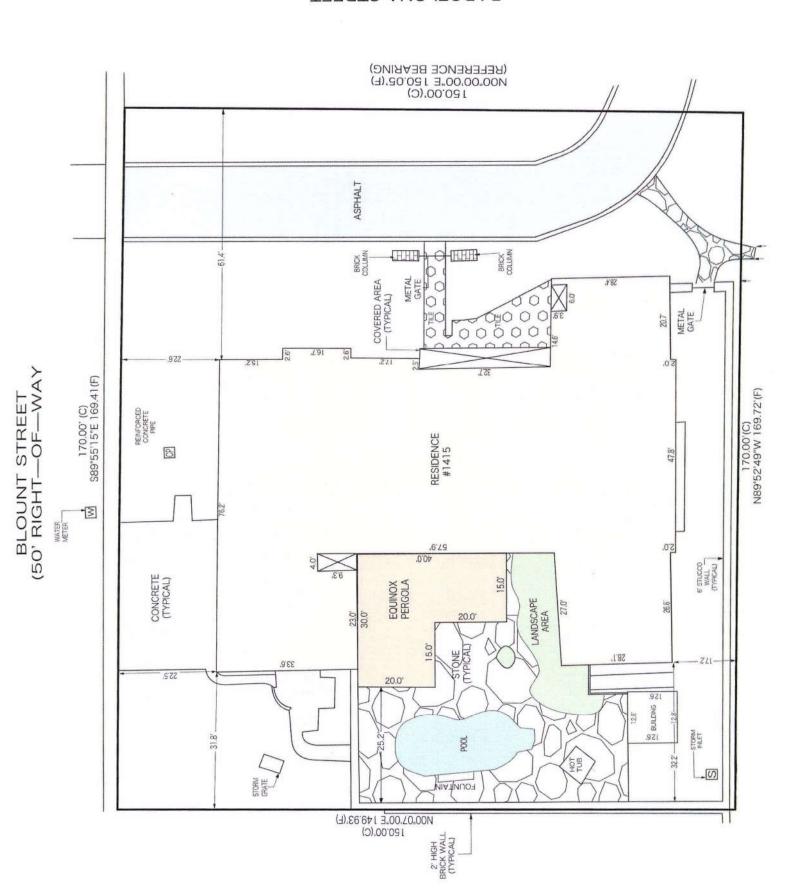

(20. RIGHT—OF—WAY)

Photos Previous structure












Proposed New System
Hurricane Rated Equinox Pergola







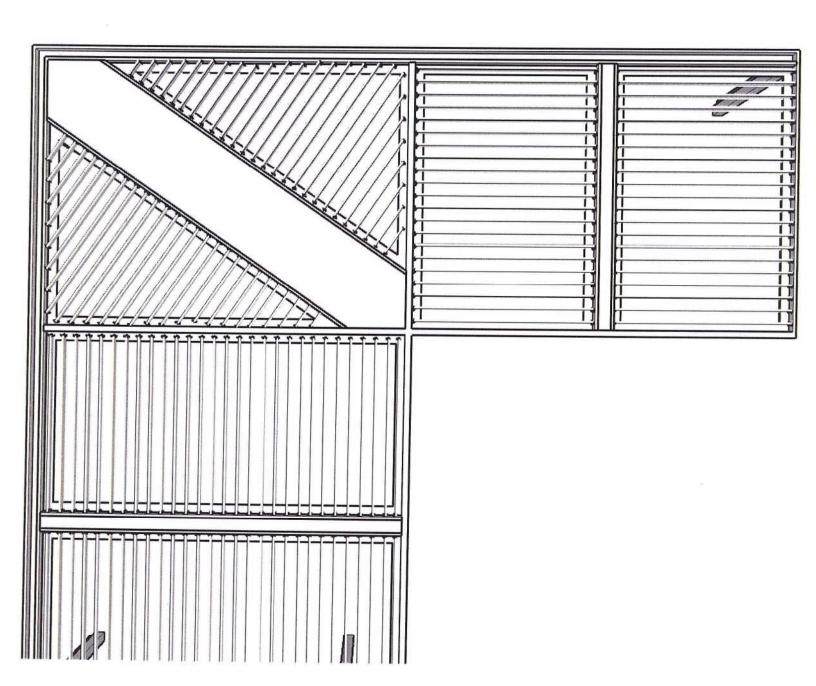

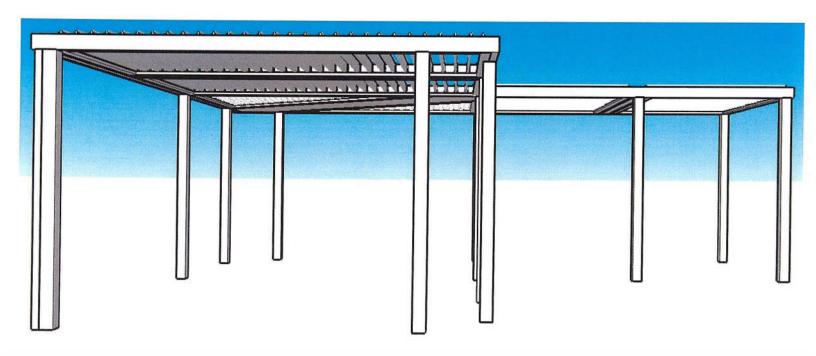


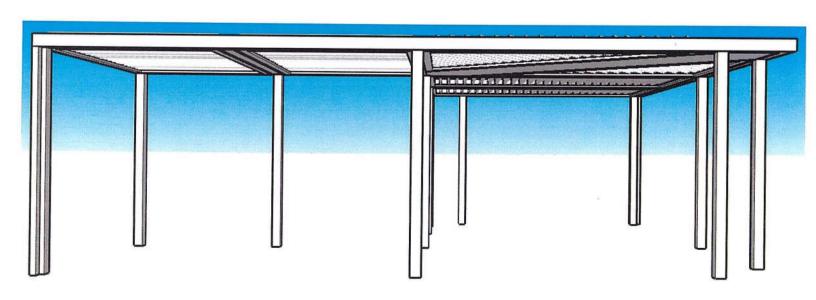

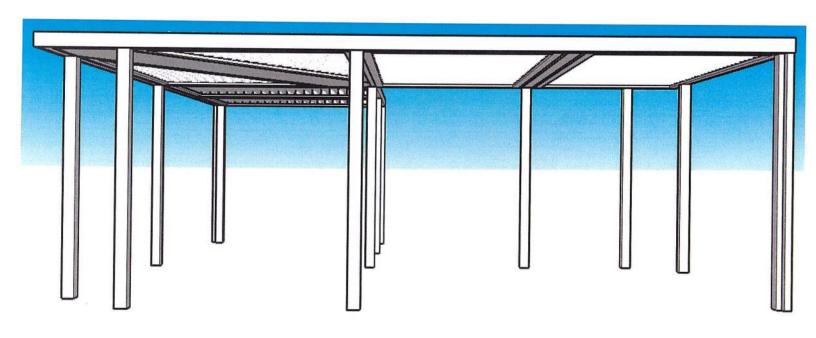


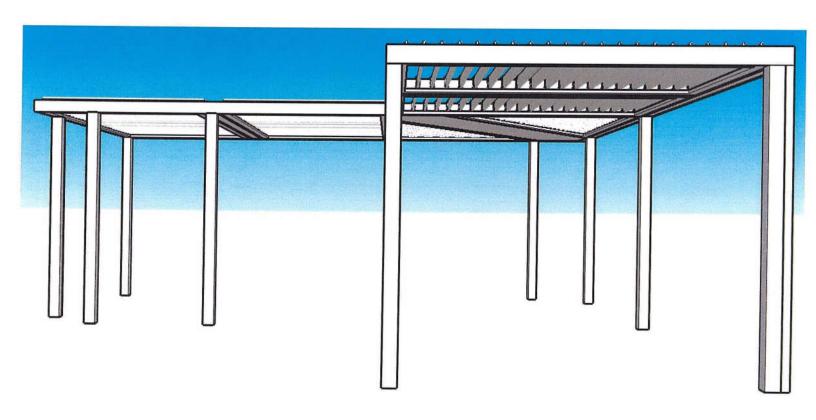

Proposed New System
Stamped Engineering Plans

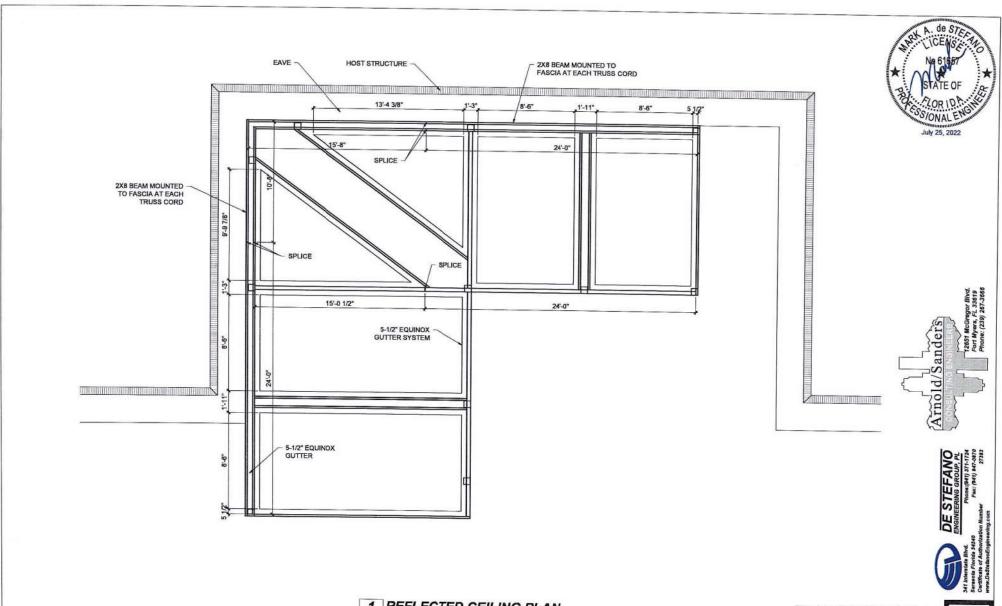


1 REFLECTED CEILING PLAN
S3 SCALE: 3/16" = 1'-0"

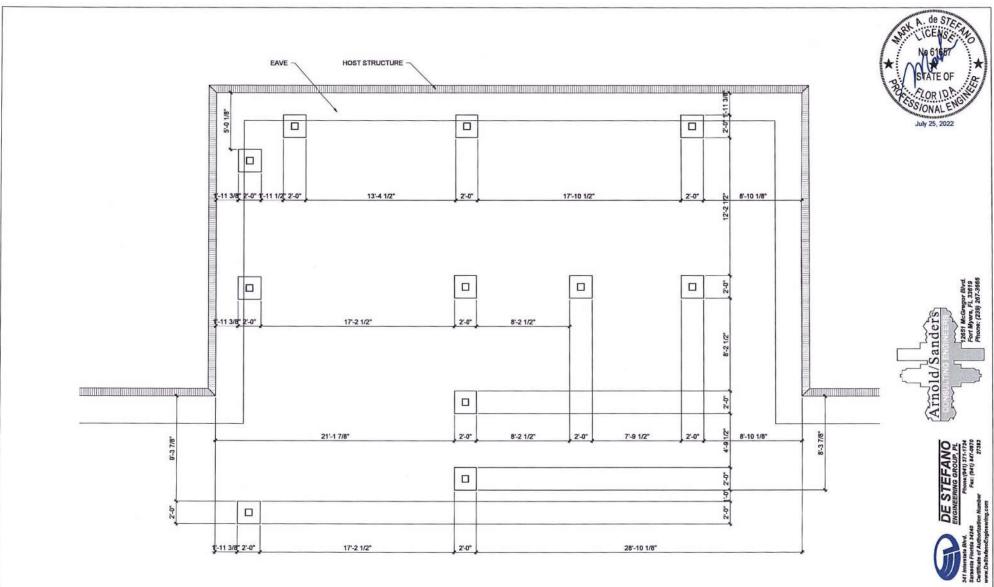

1 FOUNDATION PLAN
S4 SCALE: 3/16" = 1'-0"



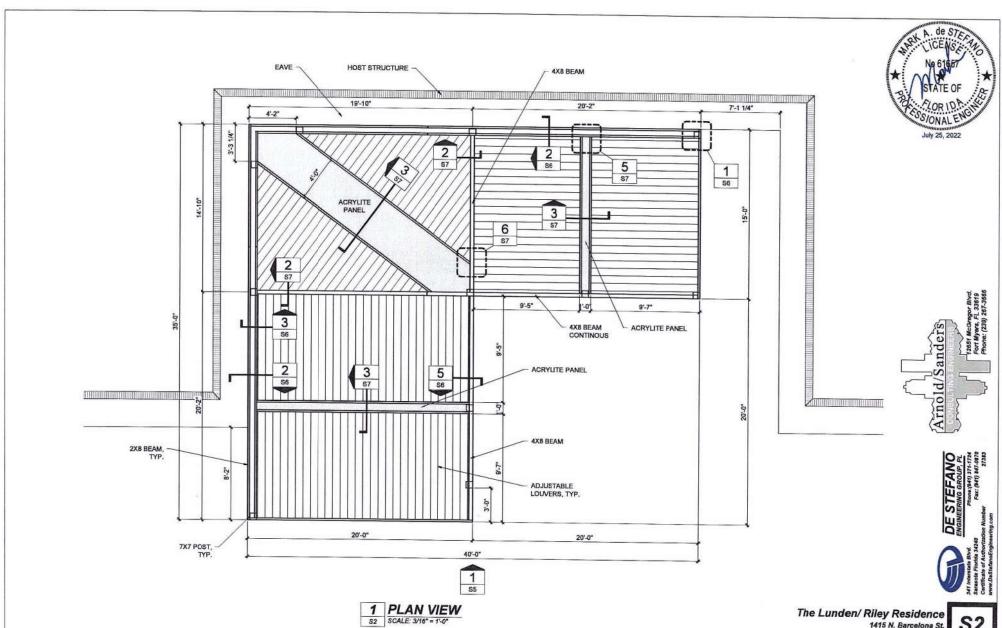

GENERAL NOTES:

DESIGN CRITERIA

THE STRUCTURAL SYSTEM FOR BUILDING DEPICTED HERE ON HAS BEEN DESIGNED ACCORDING TO THE 2020 7TH EDITION OF THE FLORIDA BUILDING CODE, ASCE 7-16, AND THE 2015 ALUMINUM DESIGN MANUAL

THE STRUCTURE HAS BEEN DESIGNED TO RESIST THE FOLLOWING SUPERIMPOSED LOADS.

ROOF DEAD: 2 PSF + SELF-WEIGHT

12 PSF

ROOF LIVE:

WIND LOADS ON THE STRUCTURE HAVE BEEN CALCULATED IN ACCORDANCE WITH ASCE 7-16 FOR THE FOLLOWING: BASIC WIND SPEED: 150 MPH (3 SECOND GUST), RISK CATEGORY: II. EXPOSURE CATEGORY: B. PARTIALLY OPEN ROOF 30 PERCENT SOLID, ENCLOSURE CLASSIFICATION PER ASCE 7-16. TABLE 26.13-1 (FOR 4-SIDED RECTANGULAR LOUVERED AWNINGS)

LOAD COMBINATIONS:

D+0.6W 0.6D+0.6W

D+L D+0.75L+0.75(0.6W)

DESIGN OF LOUVERED RIGID CANOPY IS PER SECTION 3105.5.1 OF THE FBC. RIGID AWNINGS AND CANOPY SHUTTERS. LOUVERED BLADES SHALL BE REPOSITIONED TO THE VERTICAL OPEN POSITION DURING PERIODS OF HIGH WIND VELOCITY. UNIT IS EQUIPPED WITH A WIND SENSOR WHICH WILL OPEN

PER FBC SECTION 3105.5.3, CONTRACTOR SHALL POST WITH A LEGIBLE AND READILY VISIBLE DECAL OR PRINTED INSTRUCTIONS TO THE OWNER OR TENANT TO REMOVE OR REPOSITION THE STRUCTURE OR PART THEREOF DURING SUCH PERIODS OF TIME AS DESIGNATED BY THE US WEATHER BUREAU AS BEING A HURRICANE WARNING OR ALERT. THE WARNING LABEL SHOULD READ AS FOLLOWS:

"THIS RIGID AWNING MUST HAVE LOUVERED BLADES REPOSITIONED TO THE VERTICAL POSITION DURING A HURRICANE WARNING OR ALERT AS DESIGNATED BY THE U.S. WEATHER BUREAU (FBC SECTION 3105.5.3)."

A CONTINUOUS LOAD PATH BETWEEN FOUNDATIONS, COLUMNS, AND BEAMS ARE INTENDED BY THESE DRAWINGS AND SHALL BE FIELD VERIFIED.

THE LOUVERED ROOFING SYSTEM SHALL BE INSTALLED IN ACCORDANCE WITH EQUINOX LOUVERED ROOFING SYSTEM

THE CONTRACTOR IS RESPONSIBLE FOR WATERPROOFING.

IT IS THE RESPONSIBILITY OF THE CONTRACTOR TO DETERMINE SUITABLE SEQUENCING, MEANS AND METHODS OF CONSTRUCTION, INCLUDING, BUT NOT LIMITED TO THE ADDITION OF NECESSARY SHORING, TIE DOWNS, TEMPORARY BRACING, ETC.

THE INFORMATION USED AND CONTAINED HEREIN IS BASED ON CONTRACTOR SUPPLIED DATA AND MEASUREMENTS, DESTEFANO ENGINEERING GROUP, PL (DEG) HAS NOT VISITED THIS JOB SITE, DIMENSIONS AND EXISTING CONDITIONS SHALL BE FIELD VERIFIED. DEG ASSUMES NO RESPONSIBILITY OR LIABILITY IN ANY WAY FOR ERRONEOUS OR INACCURATE DATA OR MEASUREMENTS, DEG SHALL BE NOTIFIED AND GIVEN AN OPPORTUNITY TO RE-EVALUATE OUR WORK UPON DISCOVERY OF ANY INACCURATE INFORMATION PRIOR TO MODIFICATION OF EXISTING FIELD CONDITIONS FABRICATION, AND/OR INSTALLATION OF MATERIALS

MATERIAL SPECIFICATIONS

ALUMINUM SHALL BE A MINIMUM OF 6063-T6 UNLESS NOTED OTHERWISE

ALUMINUM PLATE TO BE 6061-T6 ALLOY

FINISH COLOR TO BE SELECTED BY OWNER FROM MANUFACTURES STANDARD COLORS FOR STANDARD EXTRUSIONS

CONCRETE FASTENERS TO BE 410 STAINLESS STEEL TITANS AS MANUFACTURED BY SIMPSON STRONG TIES OR APPROVED EQUAL.

ALL SMS SCREWS ARE 410 STAINLESS #12 x 1" SELF-TAPPING METAL SCREWS (SMS) TYPICAL UNLESS OTHERWISE NOTED.

EXTRUDED STRUCTURAL TUBE OR PIPE: ALLOY SHALL BE BE 6061-T6, 6005-T6, 6063-T6, OR AS NOTED ON DRAWINGS AND CONFORMING TO ASTM B429.

ALUMINUM IN CONTACT WITH CONCRETE SHALL BE COATED.

FOUNDATIONS

SEE STRUCTURAL DRAWINGS AND STRUCTURAL GENERAL NOTES FOR ADDITIONAL INFORMATION.

BY VISUAL OBSERVATION, SOIL AT THE SITE IS SAND (OR SAND AND ROCK) WITH AN ASSUMED SOIL BEARING CAPACITY OF 2000 PSF

PERFORM ALL CONCRETE WORK IN ACCORDANCE WITH ACI 318, THE BUILDING CODE REQUIREMENTS FOR REINFORCED CONCRETE AND ACI 301, SPECIFICATIONS FOR STRUCTURAL CONCRETE FOR BUILDINGS.

CONCRETE SHALL BE AN APPROVED MIX PROPORTIONED TO ACHIEVE STRENGTH AT 28 DAYS AS LISTED BELOW WITH A PLASTIC AND WORKABLE MIX 4000 PSI FOR FOUNDATIONS

CONCRETE SHALL COMPLY WITH THE REQUIREMENTS OF ASTM C-94 FOR MEASURING, MIXING, TRANSPORTING, ETC, MAXIMUM TIME ALLOWED FROM THE TIME THE MIXING WATER IS ADDED UNTIL IT IS DEPOSITED IN ITS FINAL POSITION SHALL NOT EXCEED ONE AND ONE HALF (1-1/2) HOURS

REINFORCING STEEL:

REINFORCING STEEL: ASTM A615, GRADE 60 DEFORMED NEW BILLET STEEL CONFORMING TO ACI 301, 315, 318, AND CRSI MANUAL OF STANDARD PRACTICE. REINFORCING STEEL SHALL BE, FREE FROM OIL, SCALE AND RUST, AND PLACED IN ACCORDANCE WITH THE TYPICAL PLACING DETAILS OF ACI STANDARDS AND SPECIFICATIONS.

CONCRETE CAST AGAINST AND PERMANENTLY EXPOSED TO EARTH: 3 IN

WELDING NOTES:

QUALIFICATIONS FOR WELDING WORK: QUALIFY WELDING PROCESSES AND WELDING OPERATORS FOLLOWING AWS "STANDARD QUALIFICATION PROCEDURE'. WELDERS TO BE EMPLOYED IN WORK SHALL HAVE CERTIFICATIONS OF PASSING WITH SATISFACTORY MARKS FOLLOWING STRUCTURAL WELDING CODE OF THE ENGINEER. AWS AND AISC STANDARD QUALIFICATION TESTS WITHIN PREVIOUS 12 MONTHS, IF RE-CERTIFICATION OF WELDERS IS NEEDED, RETESTING WILL BE THE CONTRACTOR'S RESPONSIBILITY

WELDED CONNECTIONS: FOLLOW AWS D1.2 FOR STRUCTURAL ALUMINUM WELDING CODE FOR PROCEDURES, APPEARANCE AND QUALITY OF WELDS, AND METHODS USED IN CORRECTING WELDING WORK.

WELDING ELECTRODES: FOLLOW AWS CODE AND REQUIREMENTS. FOR ALUMINUM ALLOY, PROVIDE ELECTRODES, WELDING RODS 5356 OR APPROVED FOLIAL AND FILLER METALS FOLIAL IN STRENGTH AND COMPATIBLE IN APPEARANCE WITH PARENT METAL JOINED

UNLESS OTHERWISE NOTED THE MINIMUM WELD, SIZE SHALL BE ASSUMED TO BE THE THICKNESS OF THE THINNEST MEMBER TO BE JOINED OR AS PER THE WELDING CODE WHICH EVER IS GREATER.

2X8X1/8°

BEAM/ FAN BEAM

20-63-295

6063-T52

4X8X1/4"

BEAM

20-61-194

6061-T6

GENERAL CONDITIONS

IF THERE ARE ANY DISCREPANCIES HEREIN CONTACT THE ENGINEER PRIOR TO PROCEEDING WITH THE WORK.


THIS DESIGN DOES NOT CONSTITUTE THE ENGINEERING OF ANY OTHER STRUCTURES THAT ARE NOT SPECIFICALLY MENTIONED HEREIN, IF THERE ARE ANY DISCREPANCIES THEREIN, CONTACT THE ENGINEER PRIOR TO PROCEEDING WITH THE WORK.

ALL WORK PREPARED BY DE STEFANO ENGINEERING GROUP, PL (DEG), IS THE PROPERTY OF DEG AND MAY ONLY BE USED FOR ITS INTENDED USE. THE DRAWINGS SPECIFICATIONS AND OTHER DOCUMENTS. INCLUDING THOSE IN ELECTRONIC FORM, PREPARED BY DEG AND DEG'S CONSULTANTS ARE INSTRUMENTS OF SERVICE THROUGH WHICH THE WORK TO BE EXECUTED BY CONTRACTOR, AS DESCRIBED REMAIN THE PROPERTY OF DEG, SAID WORK MAY NOT BE USED AT ANY OTHER LOCATION OR FOR ANY OTHER USE WITHOUT PRIOR WRITTEN AUTHORIZATION.

DEG WILL HAVE NO RESPONSIBILITY FOR THE CONTRACTOR'S, CLIENT'S OR OTHER ENTITIES: MEANS, METHODS, TECHNIQUES, AND PROCEDURES USED IN CONSTRUCTION, AND WILL NOT BE HELD LIABLE FOR THE CONTRACTOR'S INADEQUATE OR UNSATISFACTORY PERFORMANCE OF THE WORK



Digitally signed by Mark A DeStefano Reason: This document has been digitally sealed, Printed copies of this document are not considered sealed and the SHA authorization code must be verified on any electronic copies. Date: 2022 07 25 15:57:35 -04'00"

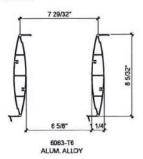





11-63-315

1415 N. Barcelona St.

Pensacola, FL 32501

The Lunden/ Riley Residence July 22, 2022 File: 221266



1 STRUCTURAL COMPONENTS

6 3/4"

B-3/4"X12"X1/4"

WELDED TAB

1/4"

3/8" PLATE

WELDED

BASE PLATE

1-3/4X1-3/4X.093

CHANNEL

13-63-307

2X2X1/8"

ANGLE


6063-T52


S1 SCALE: 2" = 1'-0"

7"X7"X1/8"


FOUINOX POST


6063-T6

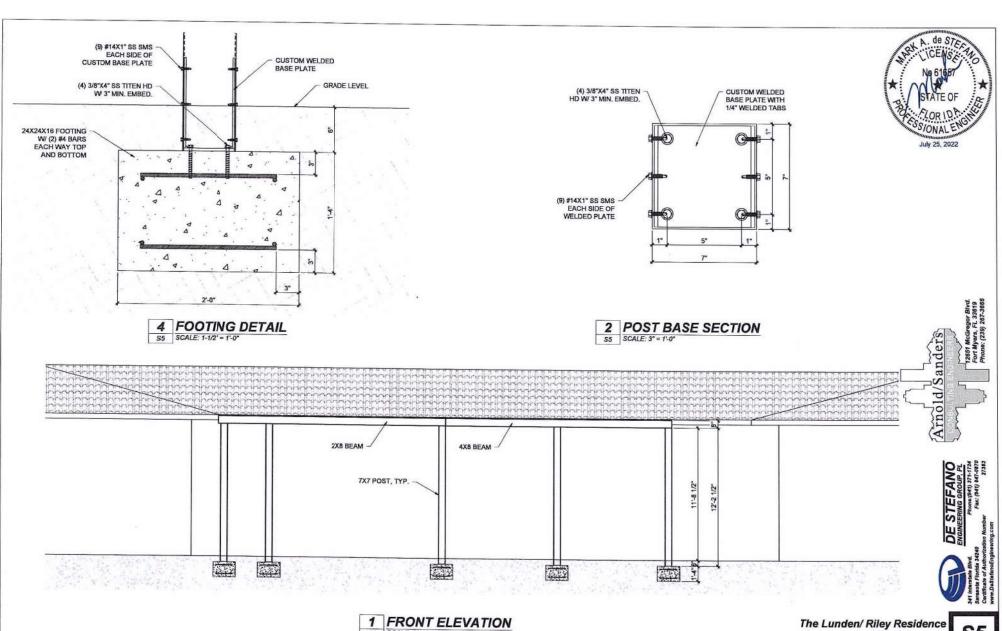


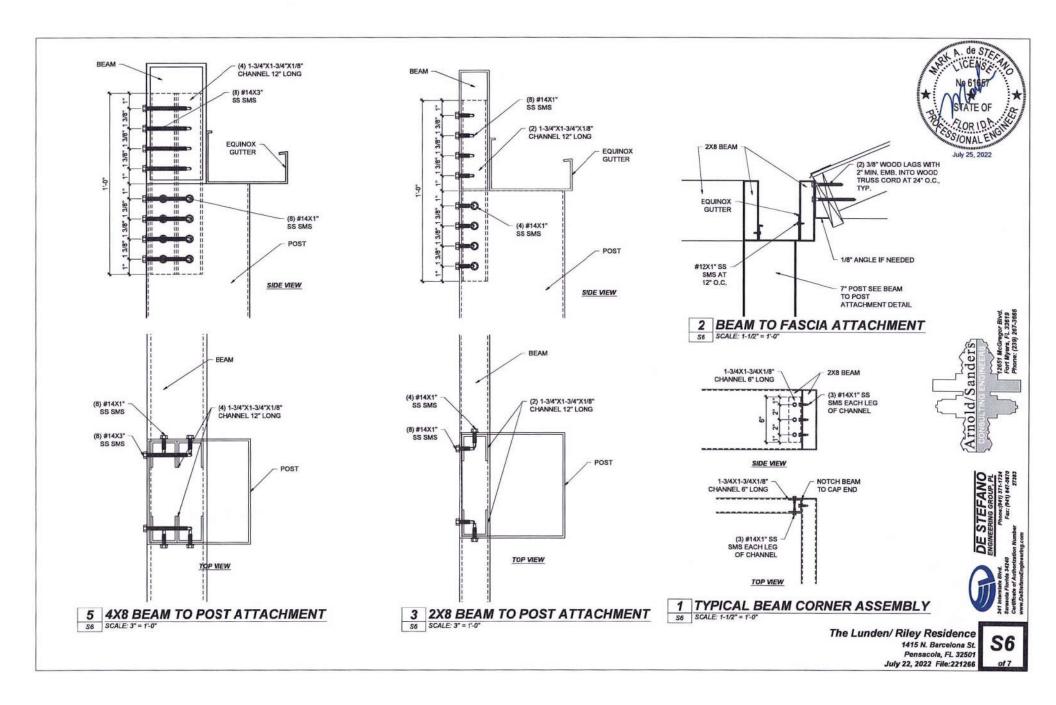





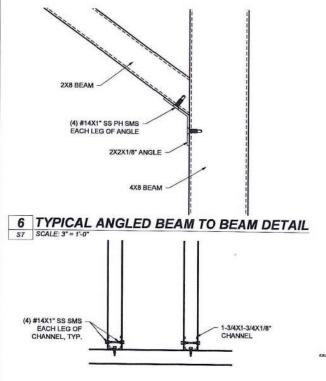


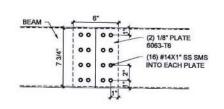

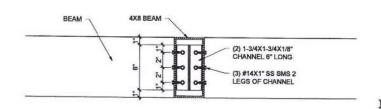

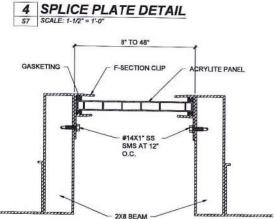

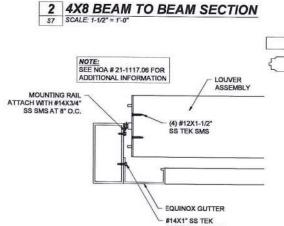

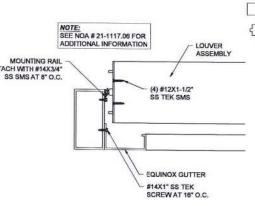



5 BEAM TO BEAM DETAIL
ST SCALE: 1-1/2" = 1'-0"

3 ACRYLITE PANEL ATTACHMENT SECTION
ST SCALE: 3"= 1":0"

1 LOUVER MOUNT DETAIL
S7 SCALE: 1-1/2" = 1'-0"

Proposed New System

MIAMI DADE REPORTS

Shop Drawings of all components



MIAMI-DADE COUNTY PRODUCT CONTROL SECTION

11805 SW 26 Street, Room 208 Miami, Florida 33175-2474 T (786) 315-2590 F (786) 315-2599

www.miamidade.gov/building

DEPARTMENT OF REGULATORY AND ECONOMIC RESOURCES (RER) BOARD AND CODE ADMINISTRATION DIVISION

NOTICE OF ACCEPTANCE (NOA)

OmniMax Holdings, Inc. 4455 River Green Parkway Duluth, GA 30096

Scope: This NOA is being issued under the applicable rules and regulations governing the use of construction materials. The documentation submitted has been reviewed and accepted by Miami-Dade County RER-Product Control Section to be used in Miami Dade County and other areas where allowed by the Authority Having Jurisdiction (AHJ).

This NOA shall not be valid after the expiration date stated below. The Miami-Dade County Product Control Section (In Miami Dade County) and/or the AHJ (in areas other than Miami Dade County) reserve the right to have this product or material tested for quality assurance purposes. If this product or material fails to perform in the accepted manner, the manufacturer will incur the expense of such testing and the AHJ may immediately revoke, modify, or suspend the use of such product or material within their jurisdiction. RER reserves the right to revoke this acceptance if it is determined by Miami-Dade County Product Control Section that this product or material fails to meet the requirements of the applicable building code.

This product is approved as described herein and has been designed to comply with the Florida Building Code, including the High Velocity Hurricane Zone.

DESCRIPTION: Equinox Aluminum Louvered Canopy - N.I.

APPROVAL DOCUMENT: Drawing No. EQ-MDC1, titled "Equinox Louvered Roof", sheet 1 of 1, dated 01/07/2015, with last revision dated 03/24/21, prepared by Carl Putnam, P.E., signed and sealed by Carl Putnam, P.E., bearing the Miami-Dade County Product Control Revision stamp with the NOA number and expiration date by the Miami-Dade County Product Control Section.

MISSILE IMPACT RATING: None

LABELING: A permanent label with the manufacturer's name or logo, manufacturing plant's city, state, model/series, and the statement reading: "Miami-Dade County Product Control Approved", unless otherwise noted herein.

RENEWAL of this NOA shall be considered after a renewal application has been filed and there has been no change in the applicable building code negatively affecting the performance of this product.

TERMINATION of this NOA will occur after the expiration date or if there has been a revision or change in the materials, use, and/or manufacture of the product or process. Misuse of this NOA as an endorsement of any product, for sales, advertising or any other purposes shall automatically terminate this NOA. Failure to comply with any section of this NOA shall be cause for termination and removal of NOA.

ADVERTISEMENT: The NOA number preceded by the words Miami-Dade County, Florida, and followed by the expiration date may be displayed in advertising literature. If any portion of the NOA is displayed, then it shall be done in its entirety.

INSPECTION: A copy of this entire NOA shall be provided to the user by the manufacturer or its distributors and shall be available for inspection at the job site at the request of the Building Official. This NOA revises NOA No. 20-0722.03 and consists of this page 1 and evidence pages E-1 and E-2, as well as approval document mentioned above.

The submitted documentation was reviewed by Manuel Perez, P.E.

MIAMI-DADE COUNTY

NOA No. 21-1117.06 Expiration Date: September 17, 2025 Approval Date: December 30, 2021

Page 1

OmniMax Holdings, Inc.

NOTICE OF ACCEPTANCE: EVIDENCE SUBMITTED

1. EVIDENCE SUBMITTED UNDER PREVIOUS NOA's

A. DRAWINGS

- 1. Manufacturer's die drawings and sections. (Submitted under NOA No. 15-0406.01)
- Drawing No. EQ-MDC1, titled "Equinox Louvered Roof", sheet 1 of 1, dated 07/21/15, with last revision dated 01/07/15, prepared by Carl Putnam, P.E., signed and sealed by Carl Putnam, P.E.
 (Submitted under NOA No. 20-0722.03)

B. TESTS

Test reports on: 1) Uniform Static Air Pressure Test, Loading per FBC, TAS 202-94 with marked-up drawings and installation diagram of Equinox Aluminum Louver System, prepared by Intertek/Architectural Testing, Inc, Report No. D7097.01-109-18, dated 09/24/14, with Revision 3 dated 03/19/15, signed and sealed by Michael D. Stremmel, P.E.

(Submitted under NOA No. 15-0406.01)

C. CALCULATIONS

 Structural load calculations prepared by Carl Putnam, P.E., dated 03/20/15, signed and sealed by Carl Putnam, P.E. (Submitted under NOA No. 15-0406.01)

D. OUALITY ASSURANCE

1. Miami-Dade Department of Regulatory and Economic Resources (RER)

E. MATERIAL CERTIFICATIONS

1. None.

F. STATEMENTS

 Statement letter of code conformance, complying with the FBC 6th Edition (2017), dated 07/14/20, issued by Carl Putnam, P.E., signed and sealed by Carl Putnam, P.E. (Submitted under NOA No. 20-0722.03)

G. OTHERS

 Notice of Acceptance No. 17-0724.09, issued to OmniMax Holdings, Inc. for their Equinox Aluminum Louvered Sun Shade, approved on 01/11/17 and expiring on 09/17/20.

> Manuel Perez, P.E. Product Control Examiner NOA No. 21-1117.06

Expiration Date: September 17, 2025 Approval Date: December 30, 2021


OmniMax Holdings, Inc.

NOTICE OF ACCEPTANCE: EVIDENCE SUBMITTED

- 2. NEW EVIDENCE SUBMITTED
- A. DRAWINGS
 - 1. Drawing No. **EQ-MDC1**, titled "Equinox Louvered Roof", sheet 1 of 1, dated 01/07/15, with last revision dated 03/24/21, prepared by Carl Putnam, P.E., signed and sealed by Carl Putnam, P.E.
- B. TESTS
 - 1. None.
- C. CALCULATIONS
 - 1. None.
- D. QUALITY ASSURANCE
 - 1. Miami-Dade Department of Regulatory and Economic Resources (RER)
- E. MATERIAL CERTIFICATIONS
 - 1. None.
- F. STATEMENTS
 - 1. Statement letter of code conformance, complying with the FBC 7th Edition (2020), dated 03/24/21, issued by Carl Putnam, P.E., signed and sealed by Carl Putnam, P.E.
- G. OTHERS
 - Notice of Acceptance No. 20-0722.03, issued to OmniMax Holdings, Inc. for their Equinox Aluminum Louvered Canopy, approved on 10/01/20 and expiring on 09/17/25.

Manuel Perez, P.E.
Product Control Examiner
NOA No. 21-1 17.06

Expiration Date: September 17, 2025 Approval Date: December 30, 2021

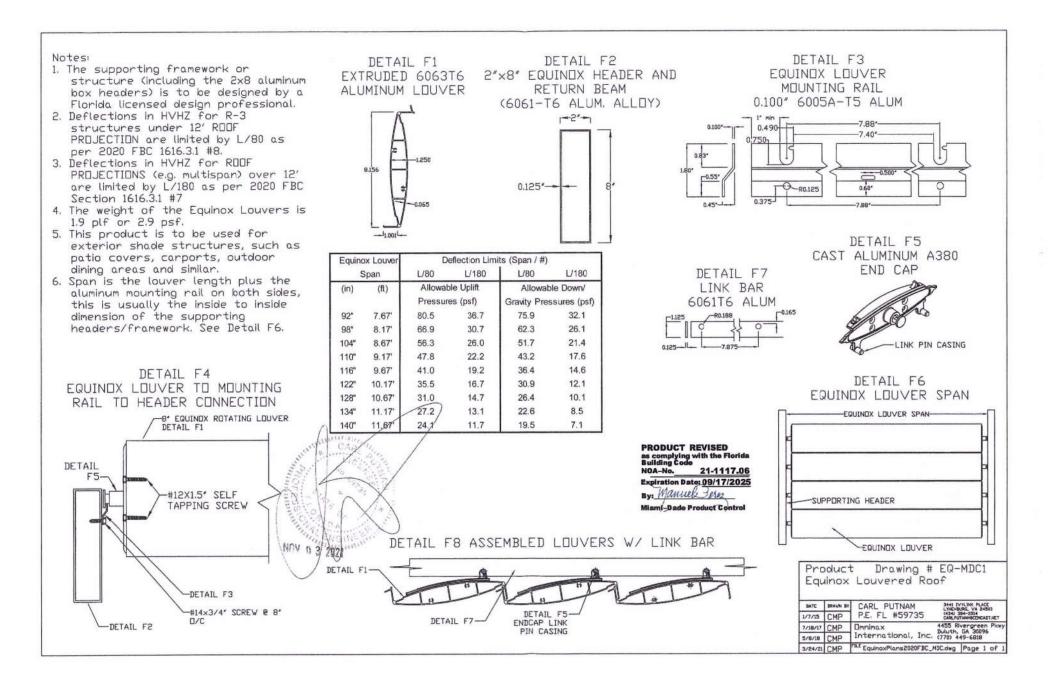

What is Equinox®?

Equinox® is a louvered roof system that moves at your command for full sun, filtered shade, or fully closed for sun and rain protection, allowing you to bring your living space outdoors. No matter what the occasion, **live life uninterrupted.**

Why Equinox®?

The Equinox® Louvered Roof is manufactured with quality elements and precision engineered for exclusive comfort and control. Equinox® enhances any outdoor living area through uncompromising versatility and style. Our patio system is strong, conforming to most wind and snow load requirements. Equinox® Louvered Roof is designed to deliver a premium experience through premium quality allowing you to transform any outdoor space.

"Our Equinox system is the best investment I've put into my home."

- Arizona Homeowner

Create your VIP Experience

lntegrated - all elements working as one Innovative - redefining what's possible Inspired - personalize the space beyond your walls ersonal - customize to match your environment

VERY

INTEGRATED

PATIO



Create custom schedules to automate your Equinox® scenes and step into your ideal outdoor living space.

With limitless add-on capabilities, enjoy the freedom to incorporate more elements to your system in the future.

Out of town and bad weather strikes at home?
Control your system from anywhere via Wi-Fi or incorporate optional sensors to give you peace of mind.

Relax and
enjoy your outdoor
space knowing your
app control system is
password protected
and securely
integrated with your
existing Wi-Fi.

Create a variety
of scenes on the
app to set different
moods with lighting
or levels of comfort
with shade and
ventilation with
the simple touch
of a button.

Don't waste time searching for a collection of remotes to adjust adividual elements your system. Use the app to control everything from one source with ease.

Control your
Equinox® system
with Amazon's
Alexa — simply enable
the Somfy® myLink™
skill, and say (for example)
"Alexa, tell myLink™
to play
BBQ scene."



Smart Home System Integration

The Somfy system is compatible with popular smart home systems available on the market today. Incorporate your outdoor oasis into your technology driven home. For complete details: www.somfysystems.com

INNOVATIVE

Redefining what's possible

Precision Engineered Motor and Louvers

An innovative smart motor system moves the louvers into the perfect position for ventilation, sun blocking or rainfall protection. Designed with extruded aluminum, the system is strong, lightweight and durable. The low maintenance louvers can be positioned for the perfect amount of protection or ventilation.

○Built-In Gutters

The Equinox® Louvered Roof system utilizes a high-capacity integrated hidden gutter system that manages rainwater runoff. At installation, the louvered roof is precisely angled to ensure that rainwater flows into the gutters along the perimeter of the system, keeping your space dry and comfortable.

Rain & Wind Sensors

These state-of-the-art sensors are designed to protect your Equinox® Louvered Roof system even when you're not home. They detect weather occurences and automatically adjust your louvers, screens, and more to prevent damage, maximize energy savings and ensure your comfort everyday. The system will close your roof during an unexpected downpour or open it during windy conditions.






COMFORT & PROTECTION

The wide range of motion of our louvers allows control of the amount of light and ventilation for your outdoor space no matter the time of day. Your Equinox® system's optional rain, wind and sun sensors automatically control your louvers based on current weather conditions.



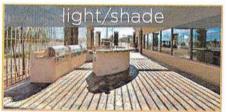









OALL METAL CONSTRUCTION

Benefits of Aluminum

The Equinox® Louvered Roof is made from extruded aluminum and offers greater durability and longevity than traditional wood, composite or steel patio covers. Equinox® Louvered Roof aluminum components are made to last and will outperform in heat and rain. Your Equinox® pergola will deliver long-term performance without the use of paint, stain or harmful cleaning chemicals. Enjoy low-maintenance, corrosion-resistant and insect-proof construction that stands the test of time.

UP TO 3X
longer life
than traditional
wood or
composite.

Create your VIP Experience at EquinoxRoof.com

PEACE of MIND

20-Year Warranty

Equinox® Louvered Roof systems are made to last. Equinox® Louvered Roof is made from all metal components providing greater durability than traditional patio covers. Unlike plastic or fabric, our metal components will perform in both heat and rain environments. We are committed to bringing you products of the highest quality and value. (The 20 year warranty only applies to the aluminum parts and paint. Electrical items and the control system have a 3 year warranty.)



Envision your

Equinox® Louvered Roof
system complementing your
home and lifestyle. Applications
include patios, decks, spas,
swimming pools, outdoor kitchens,
BBQ areas, gazebos, courtyards,
entryways or anywhere that sun,
light and weather control
is desired.

To create your VIP Experience, visit **EquinoxRoof.com**. View our gallery and visualizer for more inspiration.















Discover even more ways to enjoy your Equinox® Louvered Roof system when you interact with our social media channels on Houzz, Pinterest, Instagram, and Facebook.


Share Your Experience #EquinoxLouveredRoof

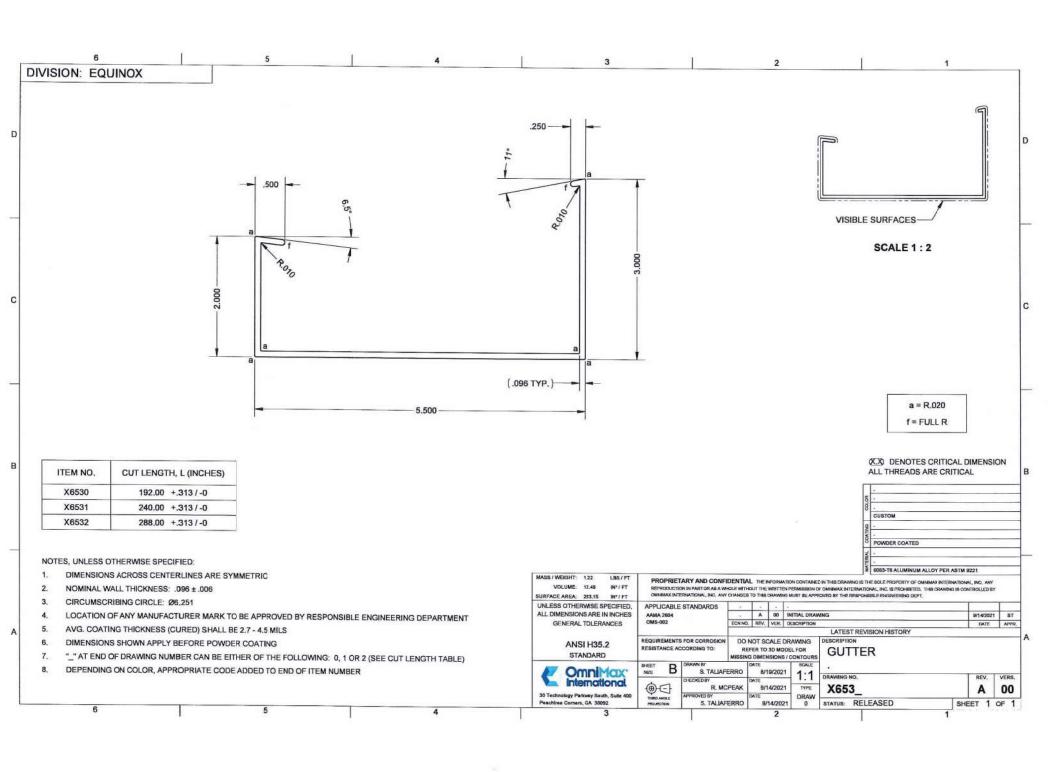


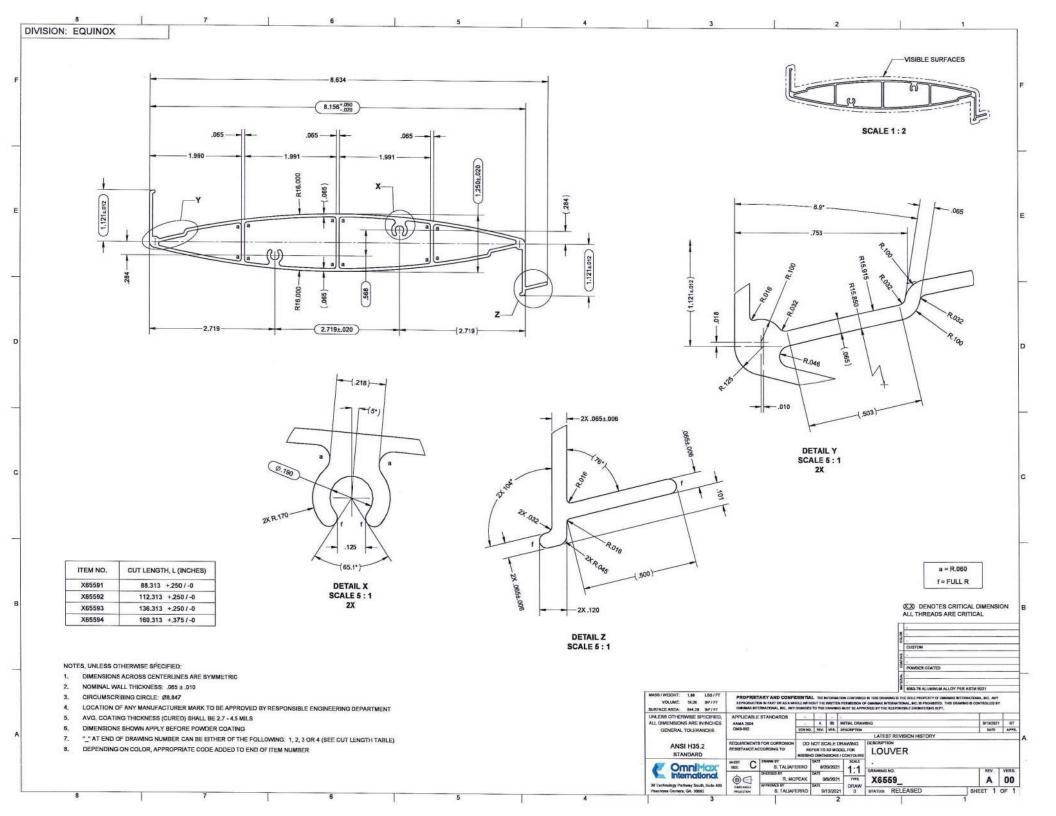


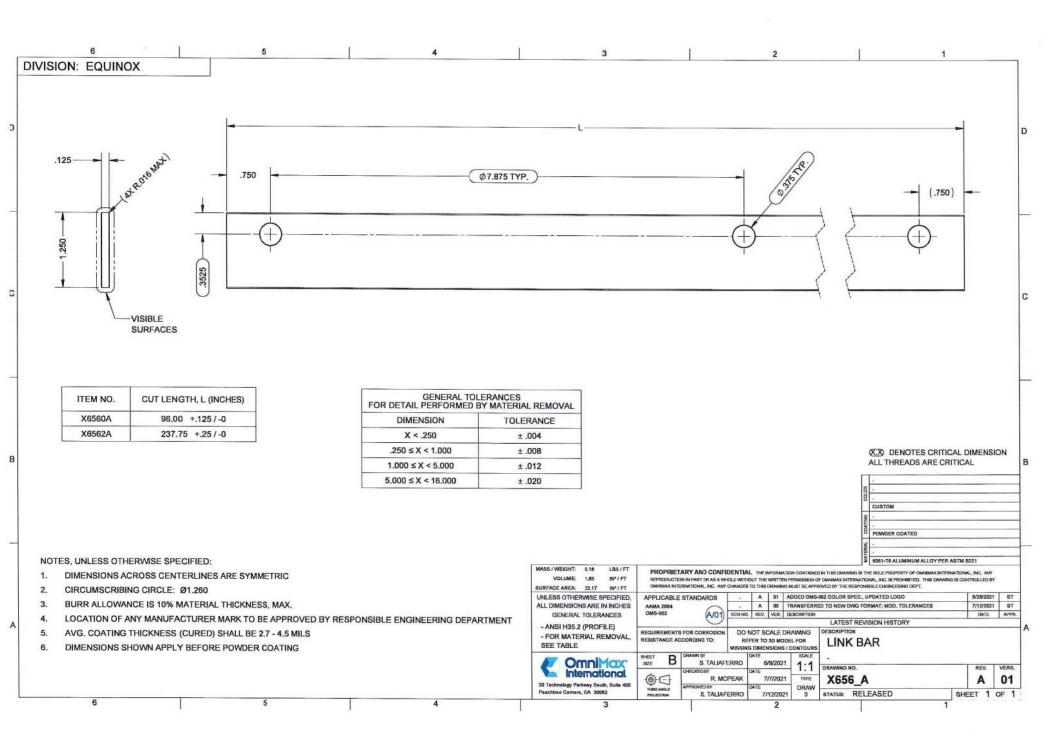


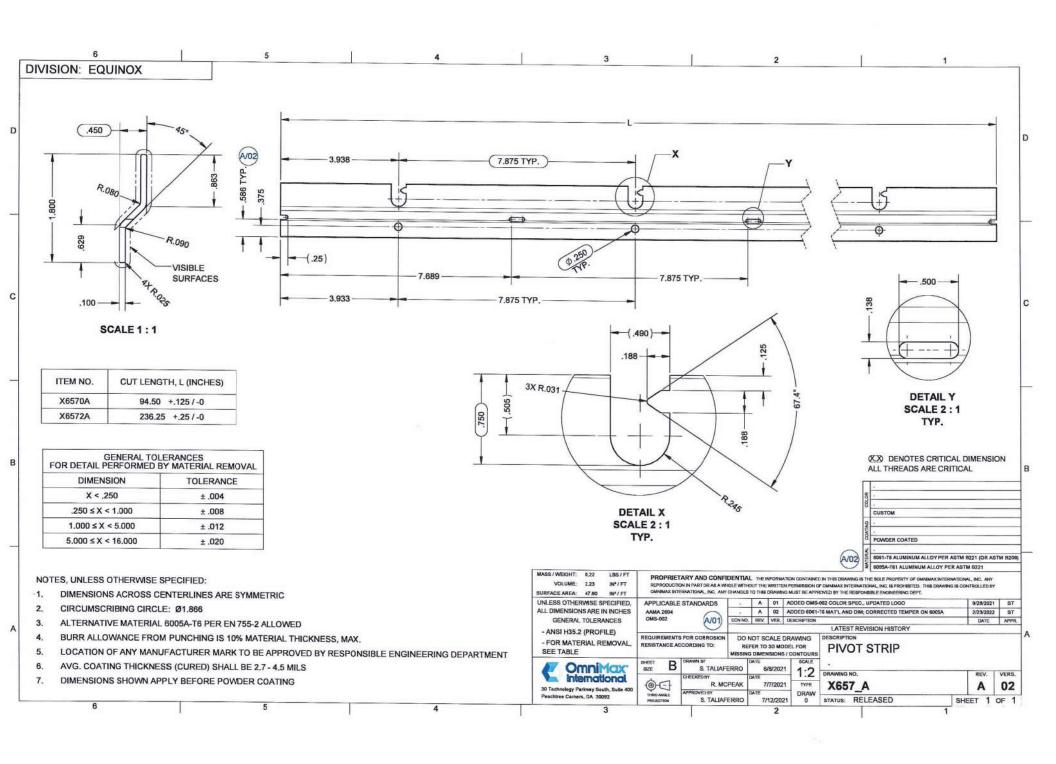


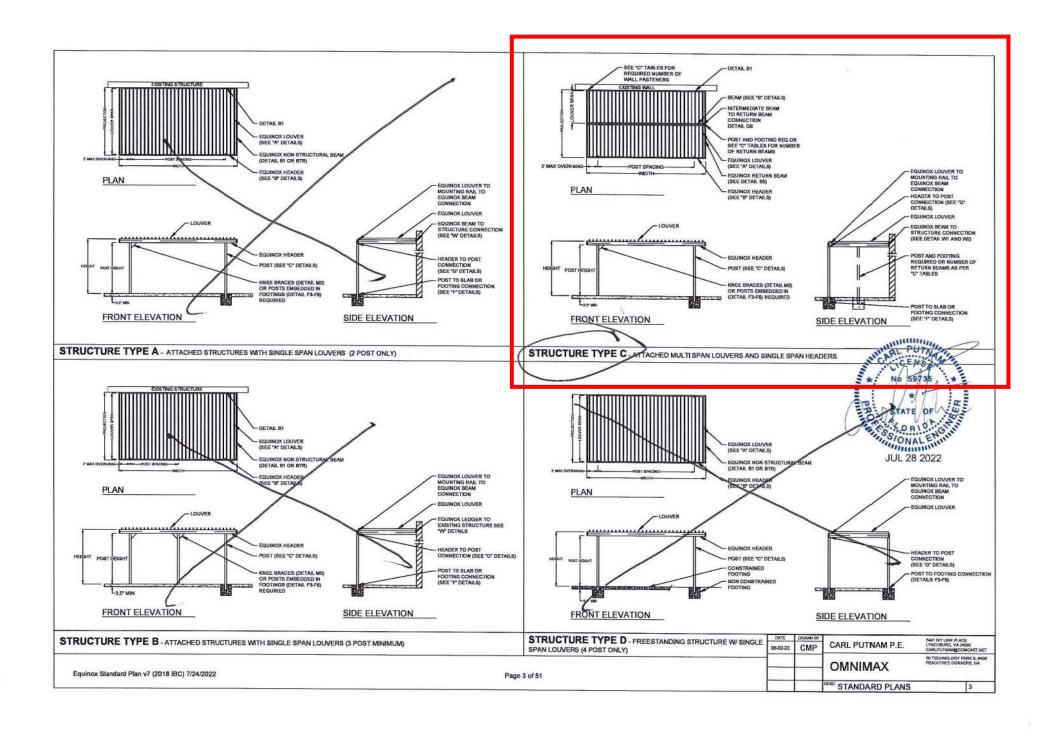

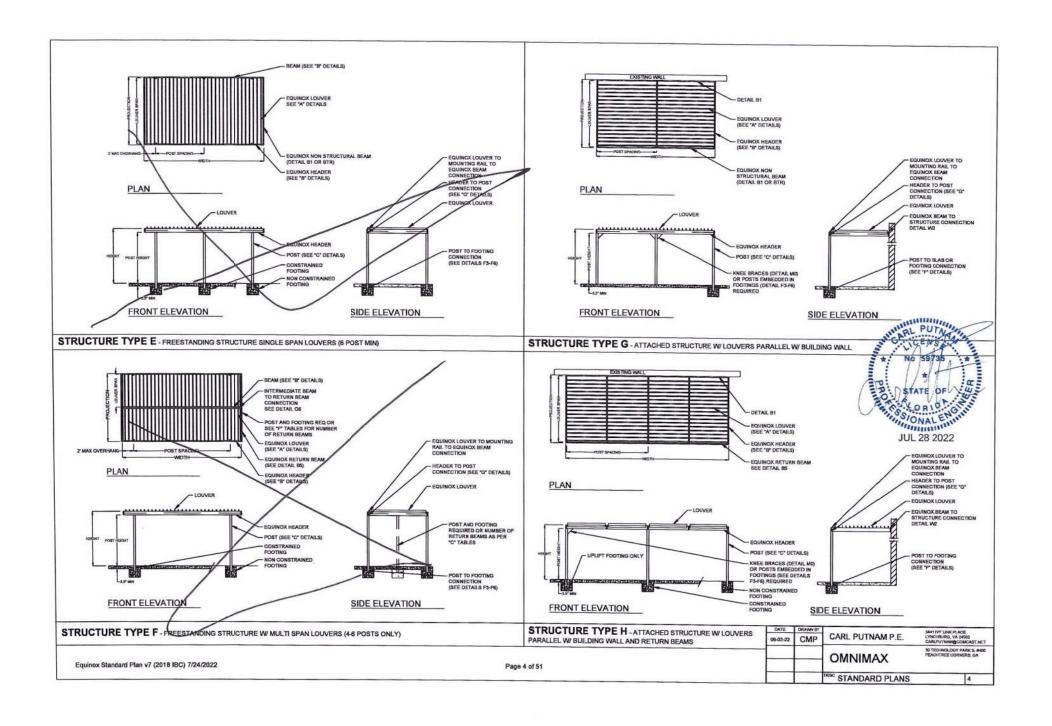

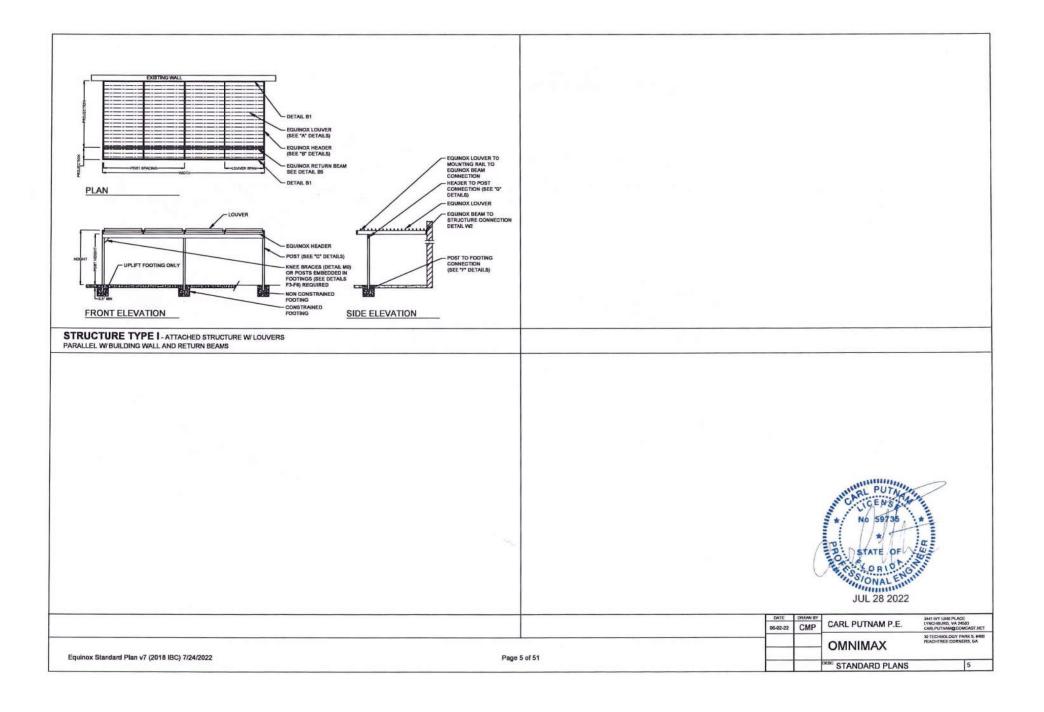


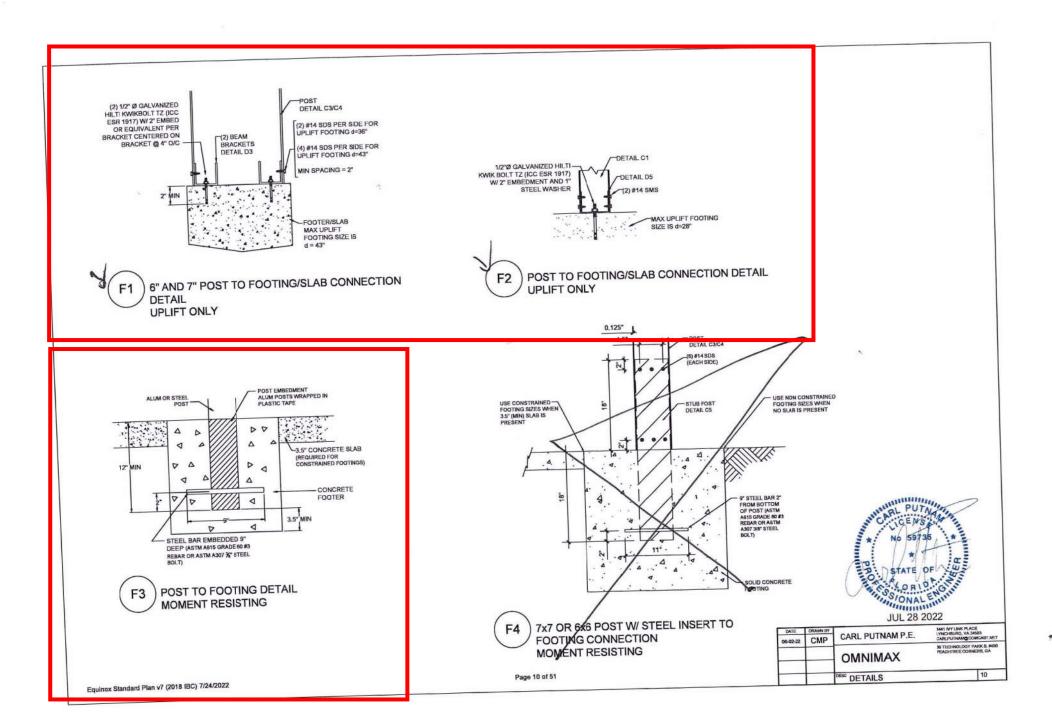

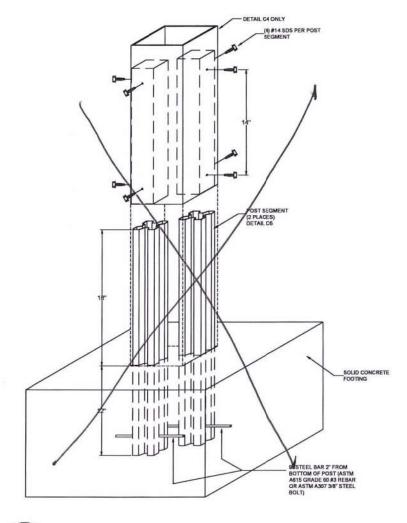

POST TO FOOTING FOR OVERTURNING MOMENT ≤ 2056 LBFxFT

Equinox Standard Plan v7 (2018 IBC) 7/24/2022

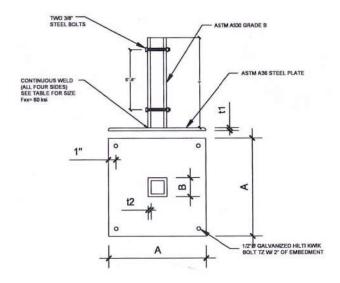

THE WELDED POST BRACKET MUST BE VERIFIED TO COMPLY WITH THE REQUIREMENTS IN THIS DETAIL AND FABRICATED IN ACCORDANCE W 2018 IBC SECTION 1704.2.5.1 BY AN APPROVED FABRICATOR TO THE SATISFACTION OF THE CODE OFFICIAL

| MOMENT CAPACITY (Ibrit) | PLATE SIZE A (in) | PLATE THICKNESS t1 (in) | STUB POST SIZE B (in) | STUB POST THICKNESS 12 (in) | MINIMUM WELD SIZE (in) |
|-------------------------------|-------------------------|-------------------------------|-----------------------------|--------------------------------------|---------------------------------|
| 950 | 8 | 0.375 | 3.5 | 0.1875 | 0.125 |
| 1250 | 12 | 0,375 | 3.5 | 0.1875 | 0.125 |
| 2200 | 12 | 0.5 | 3.5 | 0.1875 | 0.125 |
| 3450 | 12 | 0.625 | 3.5 | 0,1875 | 0,125 |
| | 12 | 0.75 | 3.5 | 0.25 | 0.1875 |
| | TE AND STUB | | | | |

WELDED STEEL BASE PLATE MUST BE MOUNTED TO TOP OF FOOTING PER TABLES PAINTED/ GALVANIZED FOR EXTERIOR EXPOSURE

*AVAILABLE FROM THIRD PARTY

| DATE | DRAWN BY | CARL BUTHAM D.F. | SALT BY LINK PLACE LYNCHBURG, VA 24503 CARLPUTNAM@COMCAST NET | |
|----------|-----------|-----------------------------------------------------|---------------------------------------------------------------------|--|
| 06-02-22 | 02-22 CMP | CARL PUTNAM P.E. | | |
| | OMNIMAX | 30 TECHNOLOGY PARK 5, 8400 PEACHTREE CORNERS, GA | | |
| | | DESC DETAILS | 11 | |

ONAL ENG

JUL 28 2022

| | 06-02-22 | CMP | CARL PUTNAMI P.E. | CARLPUTNAM@COMCAST.NET | |
|--------------|----------|---------|-----------------------------------------------------|------------------------|--|
| | | OMNIMAX | 20 TECHNOLOGY PARK 5, 8400 PEACHTREE CORNERS, GA | | |
| age 11 of 51 | | | | | |
| | | | DETAILS | 11 | |

