

ESCAMBIA COUNTY TINY HOUSES

ARCHITECT: HUFFMAN ASSOCIATES / STUDIO FOR ARCHITECTURE LLC.

UNIT 2A - EAST 923 LA RUA ST., PENSACOLA, FL. ESCAMBIA COUNTY, FLORIDA

Craig Huffman Date: 2020.07.10 19:19:35

100% CONSTRUCTION DOCUMENTS / PERMIT SET

07-10-2020



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UNIT 2A - 1 FLOOR RESIDENCE (GABLE ROOF PORCH)

TOTAL HTD/COOLED

COVERED OUTDOOR DECK

APPLICABLE CODES: FLORIDA BUILDING CODE - RESIDENTIAL 2017, 6TH ED.

OCCUPANCY / GROUP CLASSIFICATION: PER FBC, SECTION 311: RESIDENTIAL

TYPE OF BUILDING CONSTRUCTION:
PER CHAPTER 6, SECTION 601, TABLE 601 BUILDINGS ARE TYPE VB: 0 HOUR RATED

NON-SPRINKLED
PER CHAPTER 6, SECTION 602, TABLE 602 FIRE-RESISTANCE
RATING REQUIREMENTS BASED ON FIRE SEPARATION
DISTANCE >30 FEET = 0 HOUR RATED

MATERIAL RATINGS AND FLAME SPREAD: ALL FINISHES TO BE PER FBC 803.3 - CLASS C IN ALL AREAS

WIND LOAD & STRUCTURAL DESIGN CRITERIA: 141 M.P.H. PER FIG. 1609 REFER TO WIND ANALYSIS FOR ADDITIONAL STRUCTURAL DESIGN CRITERIA

GENERAL NOTES AND QUALITY STANDARDS:

1) ALL WORK IS TO BE IN STRICT COMPLIANCE WITH FEDERAL, STATE AND LOCAL LAWS AND CODES WHICH APPLY TO THIS PROJECT, AND TO GENERALLY ACCEPTED CONSTRUCTION TRADE PRACTICES

2) ALL WORK IS TO COMPLY WITH ANY APPLICABLE COVENANTS, RESTRICTIONS, AND REQUIRED CONSTRUCTION PROCEDURES REQUIRED BY ZONING, PUD & ENVIRONMENTAL PERMIT REQUIREMENTS.

3) ALL DIMENSIONS, SITE CONDITIONS AND INSTALLATION SHALL BE FIELD VERIFIED WHEN PREPARING BIDS AND PRIDE TO PROCEEDING WITH THE WORK, AND DISCREPANGES OR CONFLICTS SETWERN FIELD CONDITIONS AND THE CONTRACT DOCUMENTS SHALL BE BROUGHT TO THE ARCHITECTS ATTENTION FOR CLARIFICATION PRIOR TO PROCEEDING WITH THE WORK.

4) ALL WORK IS TO BE CONSISTENT WITH THE CONTRACT DOCUMENTS. ANY PROPOSED CHANGES OR SUBSTITUTIONS TO THE LAYOUT, ASSEMBLY, OR MATERIALS MUST BE SUBMITTED IN WRITING TO THE ARCHITECT AND APPROVED BY THE ARCHITECT PRIOR TO PROCEEDING.

5) THE ARCHITECTURAL & STRUCTURAL DRAWINGS ARE COORDINATED IN RELATION TO THIS PROJECT & ALL OF THE REQUIREMENTS IN THESE DRAWINGS APPLY TO THE WORK, IF THERE IS A CONFLICT. THE MORE STRINGENT REQUIREMENT IS REQUIRED, BUSINT CONFLICTS & DISCREPANCIES TO THE ATTENTION OF THE ARCHITECT, IN WRITING, FOR CLARIFICATION PRIOR TO PROCEEDING WITH THE WORK.

6) DETAILS LABELED "TYPICAL" APPLY TO ALL SITUATIONS THAT ARE THE SAME OR SIMILAR TO THOSE SPECIFICALLY REPRESENCE WHETHER OR NOT THEY ARE KEYED IN A TEACH LOCATION. QUESTIONS REGARDING THE APPLICABILITY OF TYPICAL DETAILS SHALL BE RESOLVED BY THE AROMITECT.

7) THE CONTRACTOR SHALL PROTECT ADJACENT PROPERTY, HIS OWN WORK AND THE PUBLIC FROM HARM. THE CONTRACTOR IS SOLELY RESPONSIBLE FOR CONSTRUCTION MEANS AND METHODS, AND JOBSITE SAFETY INCLUDING ALL OSHA RECURREMENTS.

SHOP DRAWING & SUBMITTAL REQUIREMENTS:

1) THE GENERAL CONTRACTOR SHALL REVIEW AND APPROVE SUBMITTALS AND SHALL SIGN AND DATE EACH DRAWING PRIOR TO SUBMITTAL TO THE ARCHITECT. THIS APPROVAL IS TO COMPILE TO WITH THAT THE SUBMITTAL IS COMPLETE, COMPILES WITH THE CONSTRUCTION DOCUMENTS AND THE SUBMITTAL REQUIREMENTS AND IS COMPILED WITH FIELD DIMENSIONS. OTHER TRADES, ERECTION SEQUENCING AND CONSTRUCTIBLE.

2) ON FIRST SUBMITTAL CLEARLY FLAG AND CLOUD ALL DIFFERENCES FROM THE CONTRACT DOCUMENTS. ON RE-SUBMITTALS, FLAG AND CLOUD ALL CHANGES AND ADDITIONS TO PREVIOUS SUBMITTAL ONLY CLOUDED ITEMS WILL BE REVIEWED.

FLORIDA PRODUCT APPROVAL NOTICE:

*CONTRACTOR SHALL MAKE AVAILABLE TO THE BUILDING INSPECTOR DOCUMENTATION NECESSARY TO SHERY THAT ALL COMPONENTS REQUIRING PRODUCT APPROVAL INFO COMPLIANCE WITH PRODUCT APPROVAL INSTALLATION RECOMBEMENTS.

DRAWING LIST

DATA SHEET A01 A02 A03 SPECIFICATIONS SITE PLAN

UNIT 2A - FLOOR PLANS
UNIT 2A - FOUNDATION, FRAMING & ROOF PLANS
UNIT 2A - ELLINOS SECTIONS
UNIT 2A - SELLINOS SECTIONS
UNIT 2A - WALL SECTIONS
UNIT 2A - AUTORNS & DETAILS
UNIT 2A - ALTERNATE FOUNDATION & PIER DETAILS

MEP1 UNIT 2A - MECH. ELECT. & PLUMBING PLANS

ALSO REFER TO 8.5X11 SIGNED & SEALED DRAWINGS & WIND LOAD ANALYSIS BY STRUCTURAL ENG. IN SEPERATE ATTACHEMENT

LOCATION MAP

923 E. LA RUA ST., PENSACOLA, FLORIDA



PROJECT LOCATION



EXISTING SURVEY LA RUA STREET (80' R/W)

Craig Huffman Date: 2020.07.10

ESCAMBIA UNIT frawn by: DB checked by CH REVISIONS

TINY HOUSE

COUNTY

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ST., PENSACOLA,

2A - EAST 923 LA RUA

ESCAMBIA COUNTY, FLORIDA



DATA SHEET

These Specifications describe the proposed linishes, construction systems and products that are required for this

1.) General Requirements

1.1 Alternates: NA

The base bid includes wood frame stud construction, Refer to wood stud wall sections in standard detail sheet.

1.2 Submittals: Submit Shop Drawing Submittals for windows & doors, metal roof, cabinets, ceramic tile, LVT floor

1.3 Standards & Definitions: refer to drawings

1.4 Construction Facilities: as required

1.5 Substitutions: Cost reduction alternate assemblies & products may be submitted for Architect & Owner review &

1.6 Warranties: Standard contractor and manufacturer's warranties will apply.

2.) Site Work

2.1 Site Clearing: For general layout and location of proposed structures. Only remove trees that have been approved for removal (marked on the site.)

2.2 Excavation, Filing, & Compaction: Compaction to be 98% proctor. Refer to drawings for finish floor & grade elevation relationships. (2) Geotechnical site borings to a 10' depth are recommended for each house.

2.3 Termite Control: Provide standard termite treatment that meets all environmental laws & standards

2.4 Landscape: Provide a \$500 Landscape allowance per house.

3.) Concrete

3.1 Concrete Materials

- Design mix to provide concrete with the following properties: 3000 psi at 28 compressive strength & W/C ratio of 0.46 maximum (air entrained)

- Slump Limits: slabs – not more than 4" reinforced concrete foundations; not less than 1" & not more than 3" refer to ASTM C 94 for mixing req. in various weather conditions

3.2 Reinforcing Materials

Reinforcing bars: ASTM 615, Grade 60 deformed
 Steel wire: ASTM A 82 plain cold drawn steel

4.) Masonry

ovide normal weight 1900 psi concrete masonry units in shapes, profiles & dimensions as shown on drawings

- Reinforcing bars: billet steel per ASTM 615

- Joint reinforcement: ladder design with perpendicular cross rods spaced at 16" o.c. max.

5.) Metals

- Misc. plates and fasteners to be compatible with chemicals in pressure treated wood

- Provide Simpson lasteners, bolts & washers for connection & tie down systems as required by wind load requirements & as indicated on the Architectural & Structural drawings.

- Dimensional lumber: Standard grade with 19% maximum moisture content (for untreated).

- Wall & Roof Sheathing: APA rated structural #1exterior

- Provide pressure treated wood & plywood within 18" of grade and at all locations in contact with concrete or

- Provide kiln dried P.T. for exterior columns & trim that are not cement fiber

- Provide SIPS panels in sizes & profiles shown as Alternate framing system. (if project has SIPS framing)

- Porch Columns: 6 x 6's or 8 x 8's KDAT pre manufactured hollow structural.

- Exterior trim: primed 3/4" & 5/4" hardboard trim by Hardie Board or equal.

- Exterior siding: cement fiber lap siding, smooth panels & panels with $^3 \, \rm s^* \times 1 \, 1/2^o$ or $3.4^{\circ} \, 2 \, 8 \, \, \%^{\circ}$ battens

- Soffits: 5/16° cementitious panels with 1x cem. fiber trim.

- Interior standing & running trim: paint grade w/ square edge profile.

- All exposed rafter tails and outlookers to be P.T. material.

7.) Thermal & Moisture Protection

- Insulation: R = 19 batt insulation in 1st floor joists, with plastic mesh support.

Install batt insulation in bathroom & bedroom partitions (for sound attenuation)

Install R -11 batt insulation in walls & open cell spray foam insulation "R-22 minimum in root. "If R-30 is required by energy code - provide 6" of rigid insul, in roof joist cavity.

Perimeter wall and roof insulation is provided by SIPS panels - If alternate framing system is used.

Provide Ice & Water & Shield roof membrane on roof sheathing or SIPS panels below metal roof.

-Roof: Provide corrugated galvalume 26 ga. metal roof over plywood deck with neoprene washers & exposed fasteners. Fasteners are 24" o.c. max. each way.

- Provide 24 ga. corrugated mtl. roof over porch with exposed framing & purlins.

- Provide galvanized sheet metal flashing

- Provide elastomeric joint sealers at all appropriate exterior locations.

If outlers are used: ½ round 5" dia, galvalume outlers w/ 2.8.1/2" dia, downspouts (refer to drawings).

- Provide silicone sealant for exterior caulking & joint sealer

- Exterior siding: cement fiber panels & lap siding as shown on drawings

- Exterior paint: acrylic latex mildew resistant exterior grade paint

- Interior paint: latex (satin sheen) on gypsum board or OSB & semi gloss on wood trim

8.) Doors & Windows

Refer to drawings for door & window types and locations.

- Provide exterior fiberglass doors manuf, by Jeld wen or Neuma OR approved equal.

Entry door to have ¾ lite design with intergral blinds and tempered glass. Door to be painted per Architect's color selection. Provide shop drawings from door manufacturer.

-Door Hardware: Coppercreek Egg Knob E Series passage in Tuscany Bronze finish, -Deadbolt Lock: Kwik-set 9-10 Z Wave in Venetian Bronze or approved equal. Provide electric lock & keypad @

front door

- Provide Andersen 100 series windows OR approved equa. Andersen windows include single hung, casement & All windows are to have insulated low e glass. Window colors to be selected from 100 series standard colors. Provide shop drawings from window manufacturer.

Interior doors: MDF w/ square *stick* style doors, painted, 6'-8" height – 2 panel .
 Door Hardware: Egg shape oil rubbed 10B bronze

- Bathroom floor; 6" x 24" ceramic floor tile by Montagna by Marrazi, Kitchen Backsplash: Ceramic tile backsplash in kitchen between counter and cabinets.
 Mosiac art - epic 1" x 3" brick in color selected by Architect.

- Coiling Cladding: 1/2" densifiass, painted
- Floors in Iving, dining, stehen, sleeping area: LVT "wood plank" appearance - Armstrong "better" or equal.
- Floors in Iving, dining, fastern, sleeping search, stehen with a college fastern of the stehen will a Coiling firest. 12" form SIPS panels) with paint finish 6 "«" x 1 ½" batter trim at joints.
- Sathboom will at interior partiations: "I water resistant green board with epoxy paint.

10.) Specialties - Bathroom accessories: Minror Catto Designer 2: 19.5" x 26.5" H oval siting frameless mirror with chrome hardware & beveled edges Towel bar & toilet paper dispenser: polished chrome \$50 allowance

11.) Equipment

2 burner cooktop: GE Electric Cooktop (Stainless Steel) (Common: 21-in; Actual 21.25-in) Model #: JP201CBSS

ReInigerator: Frigidaire 14.6 - cu ft Top Freezer Refrigerator (Stainless Steel) ENERGY STAR Model #: FFHT1514OS

12.) Furnishings / Millwork

- Pre manuf, standard cabinets in profiles & dimensions shown on the plans, ---- Provide ¾* birch veneer plywood kitchen cabinets - Finish to be selected by Architect.
 - Provide plastic laminate countertops in kitchen & storage loft desk - Color to be selected by Architect.
 - Cabinet hardware: - To be selected by Architect.

Provide cabinet shop drawings prior to fabrication.
 Painted wood (poplar, pine or fir paint grade) built in shelves & millwork.

13.) Special Construction N/A

14.) Conveying Systems N/A

15.) Mechanical & Plumbing

Mitsubishi mini-split system

Cost reduction substitutions & products may be submitted for the Architect's & Owner's review & approval. Proposed plumbing lixture substitutions must be consistent with the locations, aesthetics and general performance characteristics of the lixtures that are specified below.

- Plumbing fixtures.
Kitchen sink: Moen 2200 Series 22-in x 25-in Single-Basin Stainless Steel Drop-In 4-Hole Residential Kitchen Sink Model #: G221994

Kit. Faucet: Peerless Chrome 2-Handle High-Arc Kitchen Faucet with Side Spray Model #: P299578LF

Bathroom toilet: American Standard Mainstream Waterwarden White 1.28 GPF, 12" rough in WaterSense elongated 2 piece toilet

Bathroom lavatory: AquaSource White Drop in Round sink – model # AL 2191-00 Valves: AquaSource Kirkmont Chrome 2 handle 4 in Centerset WaterSense faucet, Model # 67297 - 6101

Shower: DELTA White Acrylic One-Piece Shower with Integrated Seat (Common: 36-in x 48-in; Actual: 76-in x 35.875-in x 47.875-in) Model #: 214836AC00

16.) Electrical & Lighting

- 100 amp panel with all work per Florida Residential Building Code - Electrical contractor to verify to load prior to installing panel.

Cost reduction substitutions & products may be submitted for the Architect's & Owner's cost reduction against the products may be submitted to the Architect's a common service & approval. Proposed light fixture substitutions must be consistent with the locations, aesthetics and general performance characteristics of the fixtures that are specified below.

Light lixtures: Refer to drawings for types & locations.
 Surface mount ceiling lixtures: "Harmon" 9" dia, by Restoration Hardware (or approved substitution) in polished chrome finish in bathroom.

Kitchen sconce fixture: "Vintage Barn" 9" by Restoration Hardware (or approved substitution) in weathered zinc finish, Rough in 8" -4" AFF at center line of sink,

Bathroom sconce fixture: "Cloche Sconce" 9" by Restoration Hardware (or approved

Living room Ian - light: 44" dia. Concept Drop Down by Restoration Hardware (or approved substitution) in bronze finish. Unit 2A bottom of Ian: 9" - 0" AFF,

Wall Sconces: "Witt Adjustable Sconce" by Restoration Hardware (or approved substitution) in bronze finish.

Exterior porch light: "Starboard Sconce" by Restoration Hardware (or approved substitution) in weathered zinc finish. Rough in at 7" – 6" AFF.

Recessed can lights: Shallow 5"max, depth 4" diameter with white trim. Use warm spectrum 2700k LED lamps. Recessed lights are used with wood frame only. If SIPS panels are used – fixtures are surface mount only.

Craig Huffman Date: 2020.07.10

Digitally signed by Craig Huffman

SPECIFICATIONS

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associate

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COUNTY

SCAMBIA

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REVISIONS

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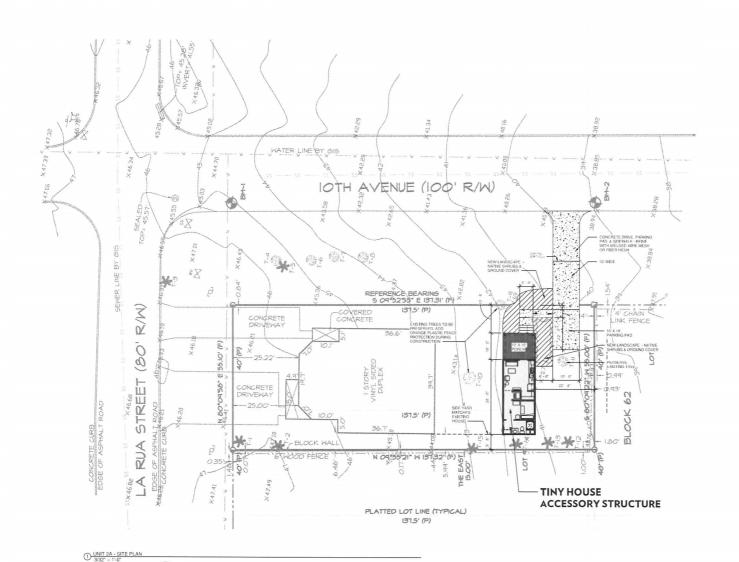
923

UNIT

COUNTY, EAST

ESCAMBIA 2A

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ESCAMBIA COUNTY TINY HOUSES UNIT 2A - EAST 923 LA RUA ST., PENSACOLA, FL.

ESCAMBIA COUNTY, FLORIDA

drawn by: DB checked by CH REVISIONS

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UNIT 2A SITE PLAN

A03

UNIT 2A "MEDIUM": 336 G.S.F. HTD/COOLED



NOTE: ALL DIMENSIONS ARE TO FACE OF STUD OR FACE OF SIPS WALL UNLESS NOTED OTHERWISE

BUILDING PERIMETER CONSTRUCTION:

- BASE BID: 2X4 STUDS @ 16" O.C. W/ R11 BATT INSULATION AND 1/2" OSB SHEATHING AND 1/2" DENSGLASS
- ALTERNATE: 4 1/2" SIPS PANEL SYSTEM

ROOF CONSTRUCTION:

- BASE BID: P.T. 2X8 JOISTS @ 24" O.C. W/ OPEN CELL SPRAY FOAM INSULATION MIN, R-22 W. 3/4" ROOF DECK AND 1/2" DENSGLASS.
- PROVIDE (2) 2X10 RIDGE BEAM.

 ALTERNATE: 6 1/2" SIPS ROOF PANEL SYSTEM

FINISH FLOOR AND DECK ELEVATIONS:

- BASE BID (AS DRAWN): FINISH FLOOR 2"-6" ABOVE GRADE, TOP OF PORCH DECK 2"-4" ABOVE GRADE, PORCH STEPS: (4) 7" RISERS
- DEDUCTIVE ALTERNATE: FINISH FLOOR 2'-0" ABOVE GRADE, TOP OF DECK 1'-10" ABOVE GRADE, PORCH STEPS: (3) 7 1/3" RISERS

UNIT 2A DOORS:

1) 3'-0" X 6'-8" FIBERGLASS DOOR WITH 3/4 LITE & INTEGRAL BLINDS - EXTERIOR - PAINTED


2) (2) 1'-3" X 6'-8" SOLID CORE MDF SLIDING 2- PANEL, STICK STYLE DOORS - INTERIOR - PAINTED

3) 2'-8" X 6'-8" SOLID CORE MDF 2- PANEL, STICK STYLE POCKET DOOR - INTERIOR - PAINTED

4) 2'-0" X 6'-8" SOLID CORE MDF 2-PANEL STICK STYLE DOOR - PAINTED

5) 2'-0" X 6'-8" SOLID CORE MDF 2- PANEL, STICK STYLE POCKET DOOR - INTERIOR - PAINTED

NOTE: SUBMIT PRODUCT MANUF, DATA COLOR/FINISH SAMPLES FOR ALL DOORS, WINDOWS, & DOOR HARDWARE, ALSO REFER TO SPECIFICATIONS FOR ADDITIONAL WINDOW AND DOOR INFORMATION.

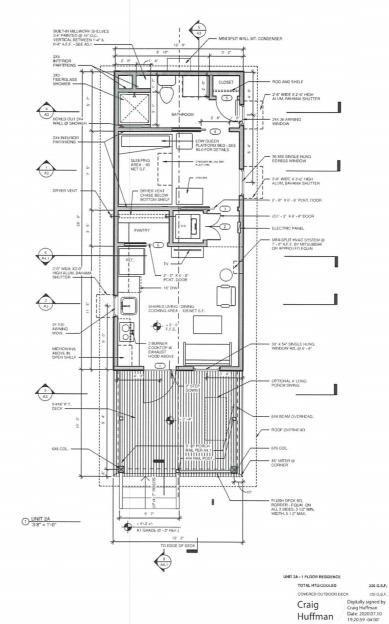

TINY HOUSE UNIT 2A - EAST 923 LA RUA ST., PENSACOLA, **ESCAMBIA COUNTY**

ESCAMBIA COUNTY, FLORIDA

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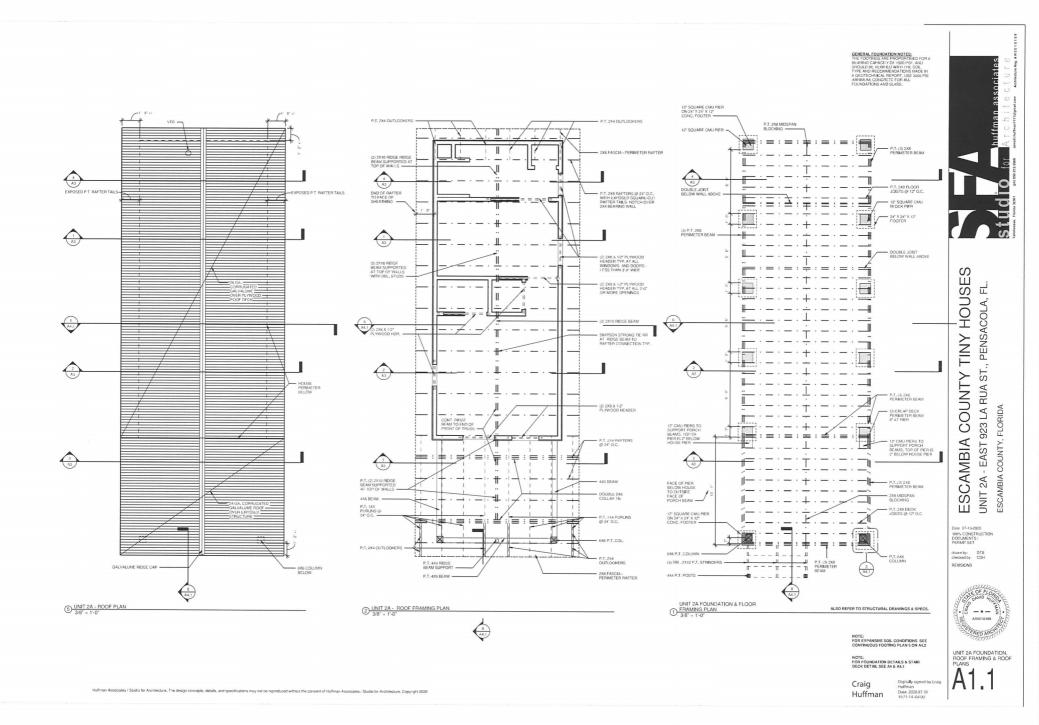
Date 07-10-2020 100% CONSTRUCTION DOCUMENTS / PERMIT SET


REVISIONS



UNIT 2A PLANS

336 G.S.F. 120 G.S.F.



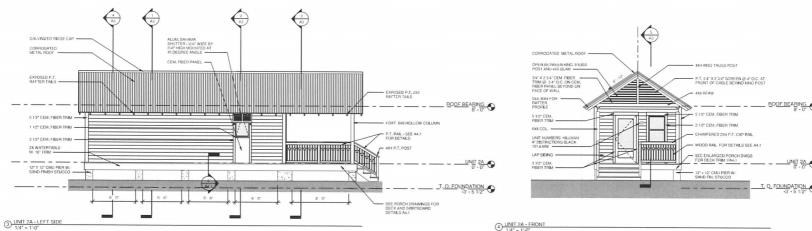

4 UNIT 2A - FRONT

Craig Digitally signed by Craig Huffman Date: 2020.07.10 19:21:25 -04'00'


ESCAMBIA COUNTY TINY HOUSES UNIT 2A - EAST 923 LA RUA ST., PENSACOLA, FL. Date 07-10-2020 100% CONSTRUCTION DOCUMENTS / PERMIT SET

drawn by: DTB checked by CDH REVISIONS

ESCAMBIA COUNTY, FLORIDA

huffman associates Architecture

E OF FLOOR UNIT 2A ELEVATIONS

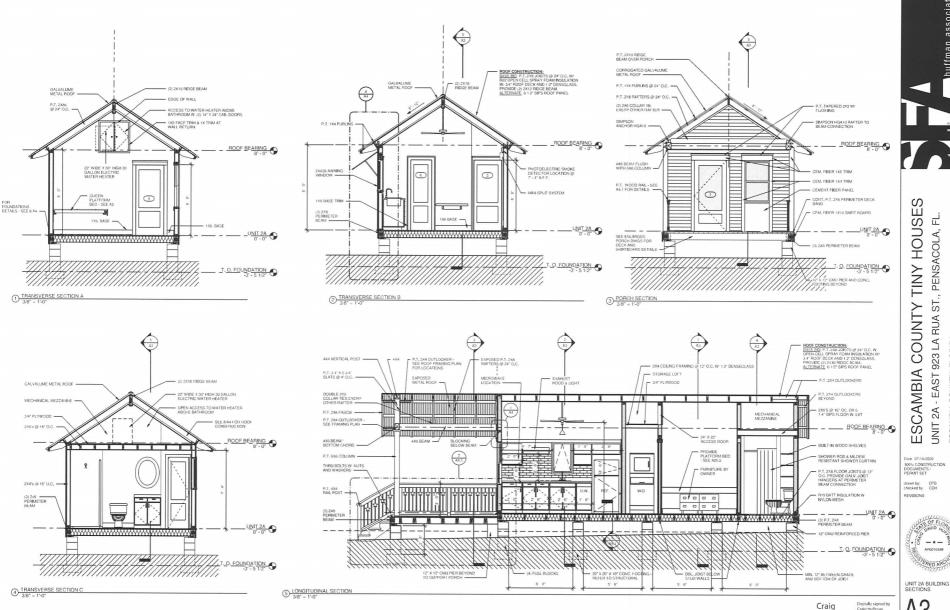

S ESCAMBIA COUNTY TINY HOUSE 딮

UNIT 2A - EAST 923 LA RUA ST., PENSACOLA,

ESCAMBIA COUNTY, FLORIDA

huffman associates

A3

Huffman

-*- E. AR0010189

DBL. STUD PACK

P.T. 2X8 RAFTERS @ 24* O.C.

PORTAL FRAME @ FRONT WALL OF LOFT UNIT - UNIT 2A FRAMING SIM.

3/8" = 1'-0"

GABLE PORCH TRUSS CONNECTION SIMILIAR WITH 8/12 PITCH
3/8" = 1'-0"

SHOWN WITH ROOF RAFTERS



'REFER TO A4.2 FOR 40" - 64" HT. PIER DETAILS

WALL SECTIONS

-*- E. AFI0010189

Date 07-10-2020 100% CONSTRUCTION DOCUMENTS / PERMIT SET drawn by LMH checked by CDH REVISIONS

UNIT 2A - 923 EAST LA RUA ESCAMBIA COUNTY, FLORIDA

ESCAMBIA COUNTY TINY HOUSE ST., PENSACOLA,



P.T. 2X8s @ 24° O.C. -

(2) 2X4 TOP PLATE

SIMPSON SPH4 48" O.C.

1/2* GYPSUM BD. OR DENSEGLASS

- 1X6 TRIM - 3/8" REVEAL (TYP.)

R-19 INSUL. W/ MESH SUPPORT

(2) #5's BOTH WAYS

Vi.

2X4 STUD WALL W/ R-11 BATT INSUL

CORROGATED GALVALUME ROOF WITH EXPOSED FASTENE USE MANUF. RECUIRED FASTENERS WITH NEOPRENE WASHERS - ON ICE AND WATERSHIELD WATERPROOFING -

5.4" X 5.1/2" CEM, FIBER HEAD TRIM .

CONT. FLASHING OVER SILL CAP, ALL WINDOW OPENINGS ARE WRAPPED WITH PEEL & STICK W.P.

3.4" X 2.3.4" CEMENT FIBER TRIM CEMENT FIBER PANEL ON VAPOR BARRIER

ALUM. SUPPORTS -

AWNING WINDOW -

5.4 P.T. SLOPED SILL

P.T. 2X8 SILL PLATE SIMPSON PA51 STRAP @ EA. PIER WRAP OVER PERIMETER BEAM —

3.4" PLYWOOD ROOF DECK -P I 2X BLOCKING BETWEEN -RAFTERS W/ 1X TRIM

GALV, METAL FLASHING -

P.T. 5 4 X 2 3 4" FASCIA -

P I 2X8 EXPOSED PLUMB GUI RAFTER TAILS @ 24" O.C.

1X6 CEMENT FIBER TRIM CEMENT FIBER PANEL ON VAPO BARHIER ON 1/2" OSB SHEATHIN

24X36 FIXED ALUM BAHAMA SHUTTER


P.T. IX FRAME @ WINDOW HEAD

OPEN CELL SPRAY FOAM INSUL, R-22 MINIMUM

SIMPSON HGA10 @ 36" O.C (4 TOTAL EA. GABLE)

SIMPSON MSTA 36 @ 48" O.C

CEM. FIBER 1X6 TRIM

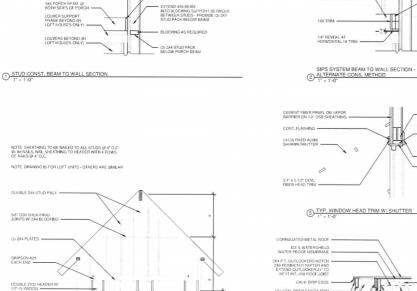

1X4 CEM. FIBER FASCIA TRIM .

P.T. 2X6 FASCIA -

1X6 CEM, FIBER TRIM -

(2) 2X4 TOP PLATE -


R-11 BATT INSUL. -EXPOSED CORROGATED METAL ROOM


3/4" SUBFLOOR

6 ROOF O.H. & OUTLOOKER DETAIL

TYP. WINDOW HEAD TRIM


1X6 CEM, FIBER TRIM

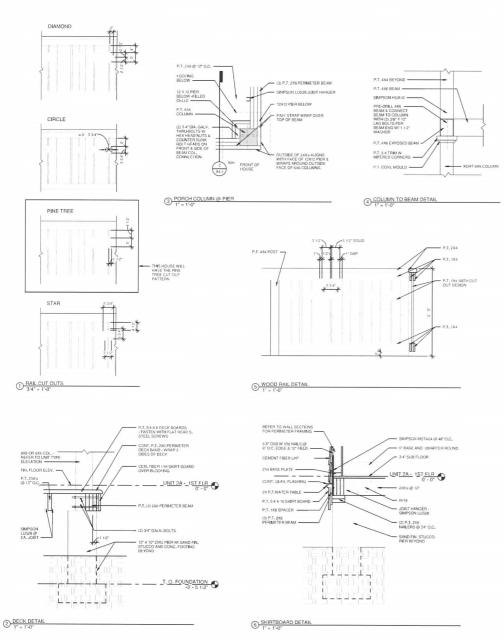

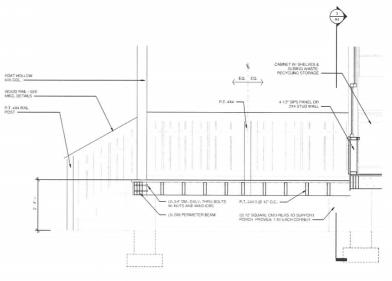



8 PORCH STAIR DETAIL

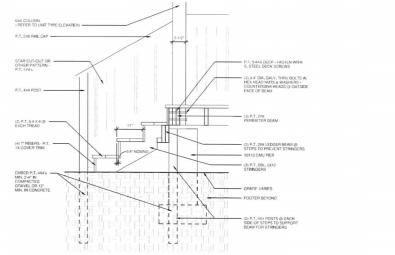


Craig Digitally signed by Craig Huffman Date: 2020.07.10 19:22:00 -04'00'



ESCAMBIA COUNTY TINY HOUSES UNIT 2A - 923 EAST LA RUA ST., PENSACOLA, FL. ESCAMBIA COUNTY, FLORIDA

SECTIONS & DETAILS

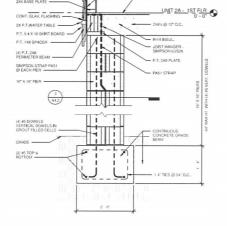


6" BASE AND QUARTER ROUND

REFER TO WALL SECTIONS FOR PERIMETER FRAMING


40" TO 64" HT, PIER DETAIL FOR HIGHER
PIERS @ SLOPED SITES

1" = 1'-0"


3 40° TO 64° HT. PIER PLAN & ELEVATION

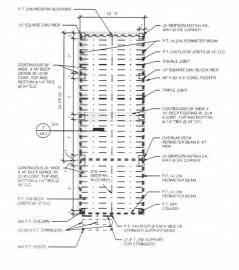



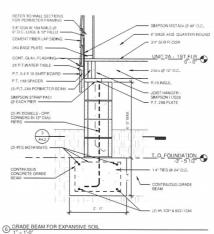


(5) EXPANSIVE SOIL FOUNDATION PLAN

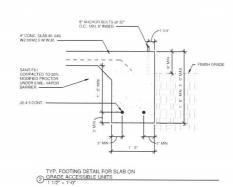

CONC. FOUNDATION

FOR ACCESSIBLE UNIT 2A

3/16" = 1'-0"

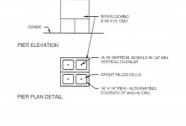

Craig Digitally signed by Craig Huffman Date: 2020.07.10

ESCAMBIA COUNTY TINY HOUSES Date 07-10-2020 100% CONSTRUCTION DOCUMENTS / PERMIT SET drawn by LMH checked by CDH

REVISIONS

-*- E.

AR0010189

A4.2

Ę UNIT 2A - 923 EAST LA RUA ST., PENSACOLA, ESCAMBIA COUNTY, FLORIDA

huffman associates


1" = 1'-0"


2 PLATFORM BED SECTION B


r 2X6 SUPPORTS

4 PLATFORM BED ELEVATION



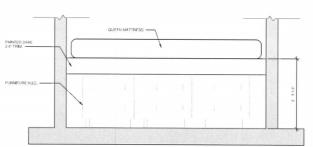

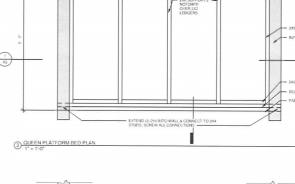

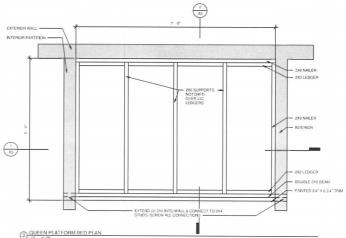



ESCAMBIA COUNTY TINY HOUSES UNIT 2A - 923 EAST LA RUA ST., PENSACOLA, FL. ESCAMBIA COUNTY, FLORIDA

Date 07-10-2020
Date 07-10-2020
DOS CONSTRUCTION
DOCUMENTS / PEHMIT SET
drawn by: DB
checked by CH
REVISIONS

BED PLATFORM DETAILS **A5**

1 UNIT 2A MECH, ELECT, & PLUMBING

NOTES:

4) MECH. CONTRACTOR TO PROVIDE ENERGY FORM ANALYSIS

5) INSULATE WATER PIPES WHERE EXPOSED.

6) PLUMBING CONTRACTOR TO PROVIDE PLUMBING RISER.

7) ELECTRICAL CONTRACTOR TO LOCATE ALL LIGHT FIXTURES AS SHOWN, IF FIXTURE LOCATION MUST BE RELOCATED, NOTIFY THE ARCHITECT TO ORTAIN APPROVAL PRIOR TO RELOCATION.

8) ELECTRICAL CONTRACTOR TO PROVIDE PANEL LOAD SCHEDULES & HISERS,

9) CONTRACTOR TO PROVIDE PLUMBING & LIGHTING FIXTURE SUBMITTALS FOR ARCHITECT'S APPROVAL PRIOR TO PURCHASE & INSTALLATIONS, - REFER TO SPECIFICATIONS ON A02

ELECTRICAL / PLUMBING SYMBOLS

0	THERMOSTAT
D-+-;	EXTERIOR FIBER OPTIC CONVERTER BOX
	ELECTRIC PANEL
OH A FOR	SMARTHOME & FIBER OPTIC INTERNET EQUIP (LOCATE ABOVE KITCHEN CABINET): 5 PORT, POF GIGARIT SWITCH: SMARTHINGS SMART HUB, WIRELESS ROUTER
9	DUPLEX OUTLET 18* A.F.F. (U.N.O) 3 WIRE GROUNDING
Q 121	DUPLEX OUTLET WITH GROUND FAULT CIRCUIT INTERRUPTER MOUNT @ 44" A.F.F.
9°	DUPLEX OUTLET, OUTDOOR
P ***	DUPLEX W/ USB OUTLET, 18" WITH USB PORT.
Фия	DUPLEX OUTLET, 220 VOLT, MOUNT 3" A.F.F., 20 AMP BREAKER
甲	CAT 5 FOR VOIP TELEPHONE
P	CAT 5 FOR TELEVISION - MOUNT 7-8" A,F,F.
9	SMOKE DETECTOR
W,M.	WATER HEATER
\$	A.C. TOGGLE SWITCH, SINGLE POLE 177-200 V.A.C., SURFACE MOUNTED @ 48" A.F.F.
\$ 1	A.C. TOGGLE SWITCH, THREE-WAY, 177-200 V.A.C. SURFACE MOUNTED @ 48° A.F.F.
\$.	SMART A.C. TOGGLE SWITCH, 177-200 V A.C., SURFACE MOUNTED @ 48° A.F.F.
	LED LIGHT FIXTURE CEILING SURFACE MOUNT
ф	LED LIGHT FIXTURE WALL SURFACE MOUNT
₩ш	EXTERIOR LED LIGHT FIXTURE, WALL SURFACE MOUNT
Ø	EXHAUST FANILIGHT, CEILING MOUNTED
\boxtimes	FLUORESCENT LIGHT, SURFACE MOUNTED
X	CEILING FAN, PENDANT MOUNT, 48" DIAMETER WITH LIGHT FIXTURE
1	FREEZE PROOF WATER HYDRANT HOSE BIB
M	METER
/	ELECTRIC WIRING
1	CAT 5 WIRING

ALL LED LAMPS ARE 2700 KELVIN, ALL SWITCHES & RECEPTACLES ARE WHITE, EXTERIOR RECEPTACLES HAVE COVER PLATES & ARE GRAY OR BLACK

MEP LEGEND

Craig Digitally signed by Craig Huffman Date: 2020.07.10 19:22:35 -04'00'



S ESCAMBIA COUNTY TINY HOUSE: UNIT 2A - EAST 923 LA RUA ST., PENSACOLA, FL.

ESCAMBIA COUNTY, FLORIDA Date 07-10-2020 100% CONSTRUCTION DOCUMENTS / PERMIT SET

REVISIONS



UNIT 2A MECH. ELEC. & PLUMBING