

City of Pensacola

Architectural Review Board

Agenda - Final

Thursday, June 15, 2023, 2:00 PM

Hagler-Mason Conference Room, 2nd Floor

CALL TO ORDER / QUORUM

APPROVAL OF MINUTES

1. <u>23-00458</u> ARCHITECTURAL REVIEW BOARD MEETING MINUTES

Sponsors: D.C. Reeves

Attachments: 5-18-23 ARB minutes

OPEN FORUM

NEW BUSINESS

2. 23-00459 1401 N. BARCELONA STREET

NORTH HILL PRESERVATION DISTRICT / ZONE PR-1AAA / CITY

COUNCIL DISTRICT 6

CHANGE OF SIDING ON A NON-CONTRIBUTING STRUCTURE

Sponsors: D.C. Reeves

Attachments: <u>Images</u>

Application and Materials 6-5-23

3. 23-00460 1414 N. BAYLEN STREET

NORTH HILL PRESERVATION DISTRICT / ZONE PR-1AAA / CITY

COUNCIL DISTRICT 6

NEW ACCESSORY STRUCTURE FOR A NON-CONTRIBUTING

STRUCTURE

Sponsors: D.C. Reeves

Attachments: Images

Application and Materials 6-7-2023

4. 23-00461 613 E. ROMANA STREET

PENSACOLA HISTORIC DISTRICT / ZONE HR-2 / CITY COUNCIL

DISTRICT 6

NEW CONSTRUCTION OF A PRIMARY AND ACCESSORY

STRUCTURE

Sponsors: D.C. Reeves

Attachments: <u>Images</u>

Application and Materials 6-5-23

5. <u>23-00462</u> 410 S. FLORIDA BLANCA STREET

PENSACOLA HISTORIC DISTRICT / ZONE HC-1 / CITY COUNCIL

DISTRICT 6

NEW ACCESSIBLE RAMP FOR A CONTRIBUTING STRUCTURE

Sponsors: D.C. Reeves

Attachments: Florida Master Site File Form

Images

Application and Materials 6-7-23

6. 23-00463 29 S. DEVILLIERS STREET

GOVERNMENTAL CENTER DISTRICT / ZONE C-2 / CITY COUNCIL

DISTRICT 7

ADDITION TO AN EXISTING STRUCTURE

Sponsors: D.C. Reeves

Attachments: <u>Images</u>

Application and Materials 6-5-23

7. <u>23-00472</u> 101 E. ROMANA STREET

PALAFOX HISTORIC BUSINESS DISTRICT / ZONE C-2 & C-2A / CITY

COUNCIL DISTRICT 6

CHANGE OF PAINT AT A NON-CONTRIBUTING STRUCTURE

Sponsors: D.C. Reeves

Attachments: Images

Abbreviated Review Referred to Full Board

Renderings 6-8-2023

8. 23-00464 811 E. BELMONT STREET

OLD EAST HILL PRESERVATION DISTRICT / ZONE OEHC-2 / CITY

COUNCIL DISTRICT 6

EXTERIOR RENOVATION ON A CONTRIBUTING STRUCTURE

Sponsors: D.C. Reeves

Attachments: Florida Master Site File Form

Images

Application and Materials 6-7-23

ADJOURNMENT

The City of Pensacola adheres to the Americans with Disabilities Act and will make reasonable accommodations for access to city services, programs, and activities. Please call 850-435-1606 (or TDD 435-1666) for further information. Requests must be made at least 48 hours in advance of the event in order to allow the city time to provide the requested services.

If any person decides to appeal any decision made with respect to any matter considered at such meeting, he will need a record of the proceedings, and that for such purpose he may need to ensure that a verbatim record of the proceedings is made, which record includes the testimony and evidence upon which the appeal is to be based.

The City of Pensacola adheres to the Americans with Disabilities Act and will make reasonable accommodations for access to City services, programs and activities. Please call 435-1606 (or TDD 435-1666) for further information. Request must be made at least 48 hours in advance of the event in order to allow the City time to provide the requested services.



City of Pensacola

Memorandum

File #: 23-00458 Architectural Review Board 6/15/2023

TO: Architectural Review Board Members

FROM: Adrianne Walker, Cultural Resources Coordinator

DATE: 6/8/2023

SUBJECT:

Architectural Review Board meeting minutes

BACKGROUND:

Architectural Review Board meeting minutes from May 18, 2023.



MINUTES OF THE ARCHITECTURAL REVIEW BOARD

May 18, 2023

MEMBERS PRESENT: Chairperson Salter, Board Member Mead, Board Member Courtney,

Board Member Yee, Board Member Fogarty, Board Member Ramos,

Advisor Pristera

MEMBERS ABSENT: Board Member McCorvey

STAFF PRESENT: Assistant Planning & Zoning Division Manager Harding, Digital Media

Specialist Russo, Cultural Resources Coordinator Walker, Assistant City

Attorney Lindsay

STAFF VIRTUAL: Development Services Director Morris, Planning and Zoning Division

Manager Cannon

OTHERS PRESENT:

CALL TO ORDER / QUORUM PRESENT

Chairperson Salter called the meeting to order at 2:00 p.m. with a quorum present.

APPROVAL OF MINUTES

Board Member Mead asked for clarification to Item 2 (30 S. Spring Street) from the April 2023 meeting. Board Member Mead noted the motion references full divided lites with the internal spacer bars, which should be full simulated divided lites. Chairperson Salter noted that the motion was based on the terminology of the product that was presented. Board Member Mead acknowledged and said the motion specifically referenced the Chair's comments about the specific product terminology, but he wanted to make sure the record was clear. Assistant Planning & Zoning Division Manager Harding stated a note will be made in the minutes and the discussion was that what Andersen calls divided lites is not really divided lites (Andersen full divided lites are actually the equivalent of simulated divided lites with most window manufacturers).

Board Member Fogarty made a motion to approve with the clarification to the motion of Item 2 (30 S. Spring Street) regarding the intent of requiring *simulated* divided lites and not *true* divided lites. The motion was seconded by Board Member Mead, and it carried 6-0.

222 West Main Street, Pensacola, Florida 32502 www.cityofpensacola.com

OPEN FORUM

NEW BUSINESS

Item 2 603 E. Government Street PHD / Zone SSD, City Council District 6
Garage Extension on a Non-Contributing Structure
Action Taken: Approved with modification.

Flynn Built is seeking approval to extend the existing garage on the front elevation. The proposal includes matching the smooth Hardie Plank lap siding painted to match the existing canary yellow color, a carriage style garage door painted maroon to match the existing shutters, matching the existing asphalt shingles; reusing the two existing exterior doors; and adding one LED flood light.

Bobby Dawson represented the project. Board Member Mead noted he had difficulty visualizing the roof line over the garage extension. Mr. Dawson noted that the design looks weird, but it supposed to be very smooth. The transition is supposed to be sleek and clean to keep with the current model of the homes in the area. Board Member Mead noted it was not clear why the transition didn't go down to a hip eave on the left elevation. Board Member Mead asked for clarification if it was a hip projection out of the lower shed roof. Mr. Dawson answered yes. Board Member Yee asked if the existing shed roof is stick framed or trusses. Mr. Dawson answered stick framed. Board Member Yee agreed with Board Member Mead that it would be nicer looking if the existing shed roof became a hip as a part of the new design as opposed to just continuing the shed and having a hip project off it. Board Member Mead noted that in a conventional subdivision this wouldn't be as visible, but this is the interior court for all of those homes, so it is a second face of the home. Board Member Fogarty asked for clarification from Board Member Mead if the roof covering over the new doorway should be a shed roof. Board Member Mead noted yes, that is appropriate.

Chairperson Salter noted that he does not have a major issue with the roof line, but he is concerned with the proposed flood lights. Mr. Dawson noted that the back of the house already has a flood light and there is no reason why it can't be reused. Chairperson Salter stated that just because the existing flood light is there, does not mean that it is appropriate. This is not a fixture utilized in an approved way in the district. Though this is an SSD and not all regulations apply, it is supposed to blend in and match the existing of the historic district. In Chairperson Salter's opinion, this is not an appropriate fixture and the existing light fixtures under the porch are more appropriate and traditional. Board Member Mead noted that wash lighting does not add to security and a better approach is up or down lighting which will illuminate the structures. Board Member Courtney echoed Board Member Mead's sentiments about security lights and the disruption they can cause for neighbors. Mr. Dawson asked for clarification if the board was stating that the light is unnecessary or if they need to choose a more appropriate light. Board Member Courtney answered a more appropriate light with a downward design would be better.

Board Member Mead made the motion to approve with modification of the lighting selection to be submitted for abbreviated review in light of the comments. Board Member Ramos seconded the motion and it carried 6-0.

Item 3 1400 N. Spring Street NHPD / Zone PR-1AAA, City Council District 6
New Accessory Garage Unit and Covered Porch at a Non-Contributing Structure
Action Taken: Approved as submitted with modification.

Nick Redhead is seeking approval for a new accessory two-car garage unit with a covered roof connecting to a new patio covering off the existing primary structure and replacing the existing concrete driveway with pavers. The new one-story accessory garage will have two garage doors, two entrance doors, and six vinyl windows with simulated divided lites. The siding will be wood lap siding, painted white to match the existing, and the roofing material will be asphalt shingles to match the existing primary structure.

Jason Stuart represented the project. Chairperson Salter asked for clarification on the particular window product. Mr. Stuart answered the Jeld-Wen V4500 series. Chairperson Salter asked staff if the V4500 had been approved in the district previously and the answer was yes. Board Member Mead asked staff for a reminder on the board's scope of review for non-contributing structures in North Hill Preservation District, with a focus on the driveway. Assistant Planning and Zoning Division Manager Harding answered that non-contributing structures are generally required to complement the surrounding district and meant to complement contributing structures in the area. Board Member Mead noted that the existing single load drive services a double load garage and the single load drive branches into double ribbon drives that have been infilled with concrete. The form of the original ribbon drives have been favored in this district and is an existing element of this parcel. Board Member Mead noted that the element of the double ribbon drive could be preserved closer to the street and the infill of pavers around the ribbons would accomplish the objective of more hardscaping for vehicles and it would be consistent with paving around the deck area. It would preserve this element of the existing hardscape and preserve the single to double drives. Chairperson Salter stated that North Hill provided comments with no objections to the request.

Board Member Mead made the motion to approve the project as submitted with modification to reconfigure the double ribbon drives and with the paving between the ribbons and a configuration similar to that of original ribbon drives and to accept the window package as submitted.

Board Member Ramos asked for clarification if the intent was to keep the existing width of the curb cut the same and use the existing ribbons that are there, infill with brick, and expanding and curving for the double loaded driveway. Board Member Mead clarified he was referring to keeping the single load or at least minimizing any additional curb cut would be important, and no, the portions he's referring to cannot be reused because they're going to be covered up by the body the building. The street-ward portion should be simply configured in the same manner as the double ribbon drive and put the pavers between the ribbons, so you still have a single load entry with a double load service at the garage face. Board Member Ramos noted it would expand into a double load but asked for clarification that when it expands into a double load, is it brick paver or concrete. Board Member Mead noted that the ribbon would be concrete, and the infill would be brick paver.

Board Member Ramos seconded the motion.

Assistant Planning and Zoning Division Manager Harding noted that the work will have to start after the curb cut once it is on private property. The City Engineer has strict guidelines for curb cuts, so it will be concrete at first and then the aesthetic portion will start.

Board Member Mead asked to amend the motion for submission of the revised driveway plan for abbreviated review. Board Member Ramos accepted the amendment to the motion, and it carried 6-0.

Item 4 400 E. Intendencia Street PHD / Zone HR-1, City Council District 6 Exterior Alterations at a Contributing Structure Action Taken: Approved as submitted with options.

Bob Cleveland is seeking approval to infill an existing rear door and match with 1x6 wood siding, painted to match the existing color. The applicant is also proposing wood railing on the front porch with decorative spindles painted white.

Bob Cleveland and Jason Stuart represented the project. Mr. Cleveland clarified that the reason for infilling the door is to accommodate interior, bathroom modifications. Board Member Courtney asked for clarification about the proposed railing. Mr. Cleveland noted that the back of the house has a straight picket, but the board may prefer a more decorate picket and he would also prefer it. Board Member Courtney asked for clarification about the height of the shutter dog on the far left side. Mr. Cleveland did not know the height, but the drawing in the application will return the pickets outside of the shutter dog. Board Member Courtney noted she has a similar situation and added a catch to the top handrail to keep the shutter open and could this be an option in this case. Mr. Cleveland noted that adding a post to return the railing will solve the issue and bushes would hide the post. Mr. Stuart noted the post will be on the edge of the deck instead of on the deck.

Advisor Pristera noted he prefers the more decorative railing on the front and the scrollwork type is more appropriate. Board Member Courtney asked Advisor Pristera for a solution with encountering the shutter dog. Mr. Stuart noted he has measured, and the rail will be outside of the shutter. The shutter dog is at the edge of the existing porch deck, so the post will be on the outside edge of the deck. Board Member Courtney asked if the partial post was still necessary with the decorative panels to stay outside of the shutter dog. Mr. Cleveland and Mr. Stuart confirmed yes. Board Member Courtney asked the board for another solution that would be better than the post. Board Member Yee asked for clarification on how the new railing is connected. Mr. Stuart noted that the railing will fasten onto the face of the fascia on the deck. Board Member Yee asked if it was possible to mount the new post three inches off the face of the siding of the house, in front of the shutter so that there is still enough clearance for the shutter to be operable. Mr. Cleveland noted he would prefer to run the railing from the existing column back to the house and if it meets board approval, he will bring the shutter out and rest it against the railing much like what Board Member Courtney suggested.

Board Member Ramos asked the height of the porch off the ground and the height of the window sill from the porch. Mr. Cleveland noted the porch is 24 inches from the ground and the sill is probably 24 inches off the deck. Mr. Stuart noted the sill is probably 28-30 inches off the deck. Board Member Ramos noted if the code doesn't require a railing, a lower railing could be installed. Mr. Cleveland stated this was originally a safety issue for young grandchildren, but prefers the option to return to the house and rest the shutter dog against the rail. Or the option for the extra post on the outside of the deck would also work and that post would match the posts on the steps.

Board Member Yee noted that on street view there are houses with railings on the front but not the side of the porch, which is a possibility. Chairperson Salter noted that either option would be appropriate, and his preference would be no railing or to keep the rail in line with the existing column and either style is appropriate, and have the shutter slightly open. Mr. Cleveland noted that either of those options are acceptable as the homeowner. Board Member Yee asked if the board must provide clear direction or if the applicant can be given the option to do either. Chairperson Salter stated the motion could be made to accommodate either option.

Board Member Yee made a motion to approve the application with the applicant given the option of either no railing or centering the new railing on the existing posts, with regard to the style it is also at the applicant's discretion since the board seemed agreeable to either option. Board Member Mead seconded the motion and it carried 6-0.

Item 5 400 BLK E. LaRua Street OEHPD / Zone OEHC-1, City Council District 6 New Construction of a Primary and Accessory Structure Action Taken: Approved with abbreviated review required.

Peter Manis is requesting approval to construct a new, one-story single-family dwelling with a detached garage. The proposed structures will have smooth Hardie Plank board and batten siding, single hung vinyl windows with a two over one grid pattern with simulated divided lites, hurricane rated colonial shutters on the front porch only, and smooth standing seam metal roofs on both structures. The applicant is proposing a flat top wood fence on the east, north, and west perimeters and the driveway will be composed of permeable pavers with a black powder coated aluminum gate.

Cassandra Manis represented the project. Board Member Mead asked for clarification on the bathroom side façade windows and sought more consistency. The smaller window on the left elevation is less obtrusive and fits better. The horizontal windows on the right elevation seem too long and need to be broken into two elements or have a mullion element in them which will match the split mullions in the sash windows. The windows should be of similar size across the façade for consistency. Ms. Manis asked if the largest fixed window on the right elevation should be smaller to match the other windows on that façade. Board Member stated it is preferable. Board Member Ramos asked for clarification on the far right window of the right elevation, that if it should match the window over the kitchen sink or should all three of the smaller windows on the right elevation match. Chairperson Salter noted that the horizontal windows are the biggest indicator of new construction and when there is an elevation with so many horizontal windows, it becomes a dominate aspect of the elevation. The board encourages applicants to add something to make the windows feel more vertical, either reduce in width or increase in height toward a square proportion or break them up into two square windows or add trim below the window and change the siding to look like a fake shutter with a transom window above. Chairperson Salter noted that the three windows on the right elevation need to be more consistent with a vertical element to add division and a vertical feel. Adjusting the windows will help the house fit in with the historic nature of the area.

Ms. Manis noted that possible railing was depicted for the front porch, but the preference is no railing unless code requires it. Ms. Manis would like to have it considered in case it is necessary. Board Member Mead asked for the terrain elevation change and Ms. Manis answered it is negative slope from the back of the lot to the front. The property to the left was roughly 1-1.5 inches off from requiring railing per code. Board Member Mead noted the board is usually concerned with the height of the foundation profile, but if that base is fading into slope at the rear, it is much less of a concern and the base reveal can be adjusted at the back.

Board Member Mead made a motion to approve the application as submitted with submission for abbreviated review of altered window profiles for the horizontal windows on both facades to more of a square or gang squares profile, consistent with the comments and the prior applications and those required that the Chair referenced and that accommodation be made for diminishing the foundation reveal at the rear if necessary to accommodate a height below the elevation of the porch at the front that would require railing. Board Member Fogarty

seconded the motion.

Ms. Manis asked for clarification on the treatment for addressing the fact the rear elevation is four inches and the front elevation is roughly 30 inches. Board Member Mead clarified that it is fine if the rear foundation reveal diminishes to four inches, if that is what is needed to get below 30 inches on the front. Or the if the foundation remains as depicted, the rail is fine too. Board Member Ramos asked if the board was approving the railing that is in the package. Board Member Mead noted yes, approved as submitted. Board Member Ramos asked if the board had approved a rail with that profile in the past in that district. Assistant Planning and Zoning Division Manager Harding noted yes the board has approved a similar rail in the past and typically the wrought iron look has been approved in all the districts and it depends on the architecture. Board Member Ramos noted that the motion is clarified rather than amended. Board Member Mead noted that both the right and left elevations should be submitted for abbreviated review in regard to the horizontal windows.

The clarified motion carried 6-0.

Item 6 21 E. Garden Street Renovation of a Non-Contributing Structure Action Taken: Approved.

PHBD / Zone C-2A, City Council District 6

John Mascia is seeking approval to renovate a non-contributing drive thru bank facility into a drive thru and pick up restaurant. The proposal includes painting the exterior; removing the bank ATM machine, an awning, and an access panel to be infilled with brick veneer wall to match the existing; removing one curb; and replacing the existing drive thru window.

Steve Del Gallo represented the project as the building manager. Board Member Mead asked staff for clarification on what historic district this property falls in and the scope of the board's review on things like colors and the like. Assistant Planning and Zoning Division Manager Harding noted it is Palafox Historic Business District and since paint colors are included as part of the overall permitted work or requested work, the board does have review authority on colors; however, colors in the Palafox Historic Business District do not have to follow historical palettes. Board Member Mead asked the applicant if the signage and coloring in the application represent what is being proposed or is it an example. Mr. Del Gallo noted that the application included an image of an existing facility in Boston and the orange color is on brand and the existing structure is fairly close to the proposed gray color. Board Member Mead asked if the signage was also being reviewed for approval. Mr. Del Gallo stated no, there will be no signage on the structure itself. There is an existing monument sign from Wells Fargo on Jefferson Street that will be used. Assistant Planning and Zoning Division Manager Harding noted that all signage will come back for abbreviated review. The existing monument sign is one of a few internally illuminated signs, which is now prohibited; however, since it is existing non-conforming, it has traditionally been allowed to change out the face but the second the structure is altered, it becomes non-conforming and it must be taken down. Based on discussions with the applicant, just the face will be changed out.

Board Member Mead asked if there will be changes to the lighting. Mr. Del Gallo stated no, the canopy is lit and there are parking lot lights, so it is sufficiently lit at night. Board Member Fogarty asked about the multiple drive thru lanes and if they will be utilized. Mr. Del Gallo noted that the structure will not be modified and the one island is being removed because it is narrow and difficult to maneuver up to the window. There is no plan to change any of the other drive thru lanes. Mr. Del Gallo clarified that the plan is to enter from Jefferson Street and loop around into the drive thru, and

the plan is to close off the Brue Street access.

Board Member Yee made a motion to approve. Board Member Mead seconded the motion and it carried 6-0.

Item 67 23 W. Cervantes Street Renovation of a Non-Contributing Structure Action Taken: Approved. NHPD / Zone PC-1, City Council District 6

Jordan Yee is seeking approval to renovate a non-contributing vacant service station for a new business. The proposal includes enlarging one of two existing doors in the west brick elevation, the second door being infilled; installing a new egress door in the east brick elevation; replacement of existing fluorescent canopy lighting with new low profile LED lighting; replacing the existing shingle roof with a new shingle roof; painting the existing metal siding and trim; and painting the existing brick. The existing aluminum storefront will remain.

Jordan Yee represented the project and noted that the applicant has interacted with the North Hill Neighborhood Association, and they seem to be positive with the adaptive reuse and appreciate the minimal changes to the exterior, isolated to painting the structure and swapping out the under-canopy lights. The old fluorescent tube lights are likely inoperable, and the new fixtures are similar in proportion. Chairperson Salter noted the North Hill Preservation Association provided comments with no objections. Board Member Fogarty asked for clarification on where parking would occur. Mr. Yee stated that the applicant had a pre-app meeting with FDOT and it was requested that one of the Cervantes Street curb cuts be closed, but it is not clear which one. The applicant is not proposing any changes to pavement. The conditional use application included a site plan that indicates the dumpster location on the southwest corner of the building where the door is being infilled. There is a 30-foot rear yard, and the new dumpster pad will be in the rear grass area. A striping plan will make use of the existing pavement.

Assistant Planning and Zoning Division Manager Harding noted that restaurants are not allowed by right in the PC-1 zoning district, so the applicant is seeking a conditional use that is going to the Planning Board in June and if approval is recommended, will go on to City Council. While in PC-1 this structure is also in the downtown CRA and because this is proposed to be an eating and drinking establishment, there is a 100% parking reduction. If there will be parking, as part of the permitting process a striping plan will be required.

Board Member Mead asked for clarification about restaurants not being allowed in PC-1 zoning district. Assistant Planning and Zoning Division Manager Harding answered that restaurants are only allowed in PC-1 as a conditional use, so it must go to Planning Board and City Council to be allowed. Board Member Mead noted that Hopkins House was a restaurant that once operated right across the street in PC-1, so the proposal for this restaurant is replacing something that was lost and not adding a use that was never there before. Assistant Planning and Zoning Division Manager Harding noted this fact will be included in the minutes and the goal of coming before ARB prior to the Planning Board was the ability to include the ARB minutes as a part of the Planning Board packet that will go to City Council. The ARB's comments will be in support or opposition to the project when Planning Board considers the conditional use request.

Board Member Mead asked if the intent was to use the roll up doors. Mr. Yee noted they are the existing roll up doors and imagines they will be open on nice days. Board Member Mead asked about

the high roofline of the canopy and will it be problematic with rain. Mr. Yee had not discussed this with the applicant and perhaps in the future this may be addressed but it is not part of the current proposal. Board Member Mead asked about outdoor dining furniture and if it will remain in place during operational hours. Mr. Yee answered the building owner will ultimately decide, but it would be a good idea to secure it with a cable and lock. Board Member Mead clarified that there is an architectural element to stored furniture being left in view, especially if glommed together and cabled up, which is not as aesthetically pleasing. If the furniture is left in the configuration and not stored away, there is a potential for attracting nuisance that would be a concern to the neighborhood. Board Member Mead would like to see attention to this question on both counts, how it is viewed when not operating and how the furniture will be stored or configured.

Chairperson Salter addressed the painting of the brick, noting that this is a non-contributing structure and the brick is not a key architectural feature. In this instance, painting the brick and giving a consistent, modern feel is probably a key aspect in its revitalization. Chairperson Salter does not have an issue with painting the brick for this project. Advisor Pristera reiterated that this project and the past project show that there are people interested in these smaller, funkier buildings. The Trailways building could potentially be used like this and it is a hot property right now, and small businesses and restaurants could make a good use for it. Advisor Pristera wanted to reinforce that they don't have to be demolished and he is glad to see that this one has a new life to it. Board Member Mead asked if the curb islands and curbs against the building have steel reinforcement and what is the plan for those in terms of color. Mr. Yee answered yes, they are reinforced with steel and the plans indicate that the curbs will be painted the gray color that was proposed in the packet.

Board Member Fogarty made a motion to approve. Board Member Courtney seconded, and the motion carried 6-0.

Cultural Resources Coordinator Walker noted that in considering feedback from recent applicants, the hard copy submission requirement has been reduced from ten hard copies to eight.

ADJOURNMENT

With no further business, the meeting adjourned at 3:23 p.m.

Respectfully Submitted,

Adrianne of Walker

Cultural Resources Coordinator Walker

Secretary to the Board



City of Pensacola

Memorandum

File #: 23-00459 Architectural Review Board 6/15/2023

TO: Architectural Review Board Members

FROM: Adrianne Walker, Cultural Resources Coordinator

DATE: 6/8/2023

SUBJECT:

1401 N. Barcelona Street North Hill Preservation District / Zone PR-1AAA / City Council District 6 Change of Siding on a Non-Contributing Structure

BACKGROUND:

Elizabeth Jasperson is seeking approval to replace all plywood siding with Hardie Plank smooth vertical siding to the match the existing board and batten with 16-inch boards on center with 1.5 inch battens, painted in the color Nomadic Desert from the Sherwin Williams HGTV American Heritage collection.

Please find attached all relevant documentation for your review.

RECOMMENDED CODE SECTIONS

Sec. 12-3-10(2)e.5. NHPD; Paint colors

Sec. 12-3-10(2)g. NHPD; Renovation, alterations and additions to noncontributing and modern infill structures within the North Hill preservation district.

1401 N. Barcelona Street







Architectural Review Board Application Full Board Review

			Appli	cation Date: $\frac{5/1}{}$	5/2023
Project Address:	1401 N E	Barcelona St P			
Applicant:	Elizabeth	n Jasperson / Y	our Local Con	struction, LLC-	- Dustin Vaughn
Applicant's Address:	917 Rio \	Vista Dr Pensa	cola Beach FL	32561	
Email:	elizabet	hwwms@yah	oo.com	Phone: 850-2	287-4892
Property Owner:	Elizabeth	n W Jasperson			
District:	PHD	✓ NHPD	(If different from OEHPD	Applicant) PHBD	GCD
* An application shall be deemed complete by the required information. Information. Project specifics/descrited all plywoods.	e scheduled and Secretary Please see position: with Hardie	to the Board. You ages 3 – 4 of this o Vertical Smooth	all required mater I will need to inclus I pplication for fur Plank to the exa	ude eight (8) cop ther instruction o	ies of the and
Battens 16 from the c	enter with 1	1.5 Inch battens.	Repaint exact co	olor .	
					_
I, the undersigned appl that no refund of these understand that I must	fees will be	made. I have revi	ewed the applica	ble zoning requir	rements and
- Ely	Lose-			5/15/2023	
Applic	Signature	2		D	ate













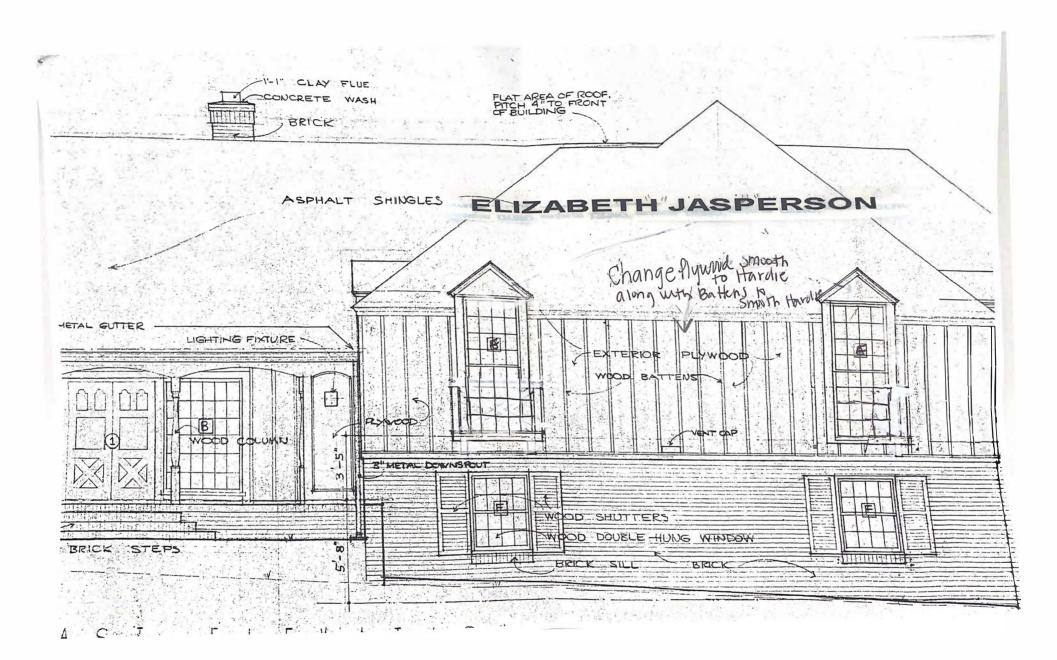





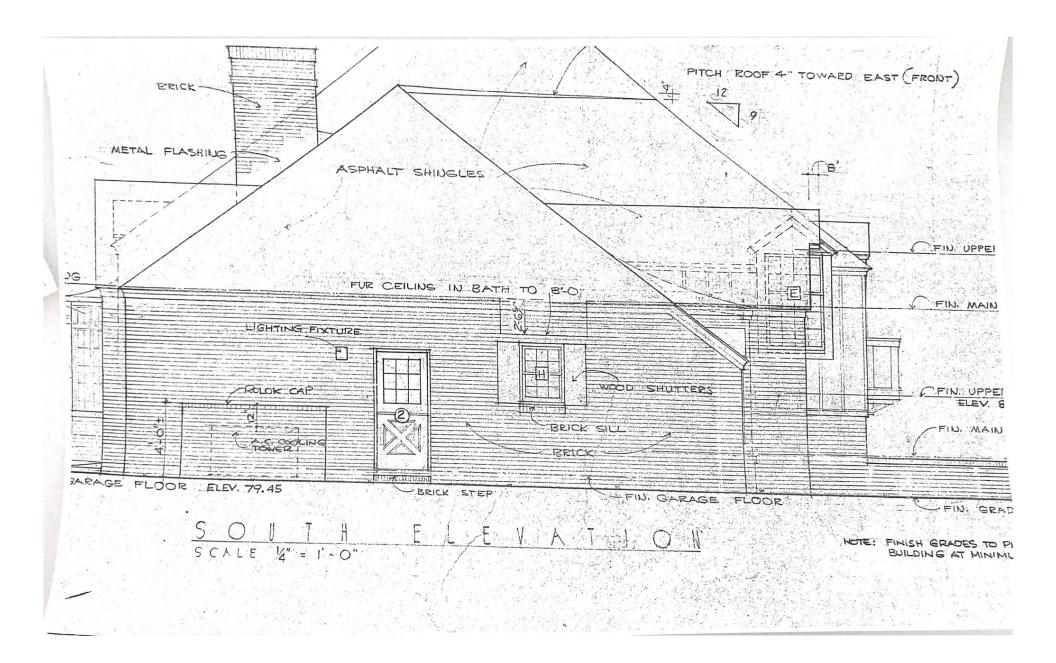



HARDIE® PANEL VERTICAL SIDING

SMOOTH

You can't go wrong with this sleek, modern siding. Find the perfect color in our Statement Collection products or Dream Collection products. Or get it primed for paint.

PRIMED FOR PAINT

James Hardie's primed for paint collection gives you the power to choose paint for your home's exterior. It's primed. It's ready for field painting. It's a durable, high-performance canvas.




AVAILABLE SIZES

THICKNESS: 0.312"

LENGTH: 108" 120"
WIDTHS: 48" 48"

96"
48"

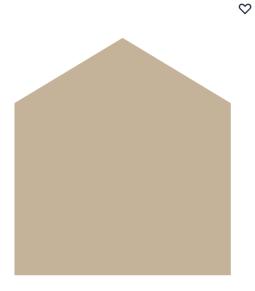

Nomadic Desert

HGSW6107 Previously: HGSW3146

Color Collections

AMERICAN HERITAGE

Color Information +

GET FREE CHIP

Available exclusively at Lowe's

Free store pickup available.



City of Pensacola

Memorandum

File #: 23-00460 Architectural Review Board 6/15/2023

TO: Architectural Review Board Members

FROM: Adrianne Walker, Cultural Resources Coordinator

DATE: 6/8/2023

SUBJECT:

1414 N. Baylen Street North Hill Preservation District / Zone PR-1AAA / City Council District 6 New Accessory Structure for a Non-Contributing Structure

BACKGROUND:

Tuff Shed, Inc. is seeking approval to install an 8 x 8 ft. portable prefabricated shed on the ground surface with a shed floor. The shed will have a single door; vertical, engineered wood siding; and a dimensional shingle roof.

Please find attached all relevant documentation for your review.


RECOMMENDED CODE SECTIONS

Sec. 12-3-10(2)e.5. NHPD; Paint colors

Sec. 12-3-10(2)g. NHPD; Renovation, alterations and additions to noncontributing and modern infill structures within the North Hill preservation district.

Sec. 12-3-10(2)h. NHPD; Regulations for new construction and additions to existing structures in the North Hill preservation district.

1414 N. Baylen Street

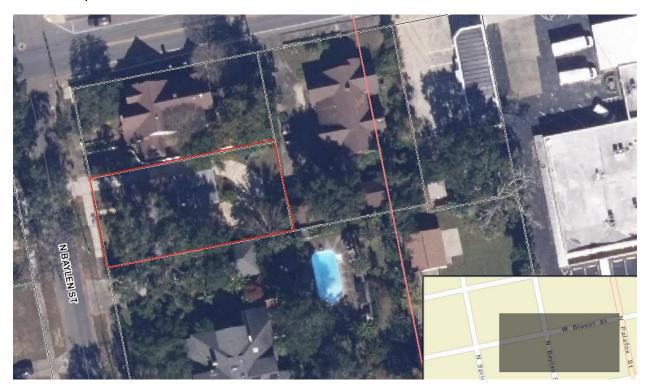





Architectural Review Board Application Full Board Review


		Applic	ation Date:	05.23.2023
Project Address:	1414 North Baylen Stre	et Pensacola, E	L 32501	
Applicant:	Tuff Shed, INC / Savan	nah Hudson		
Applicant's Address:	3450 Armour Ave Mobi	ile, AL 36617		
Email:	_licenses@tuffshed.com	<u></u> .	Phone:	251-244-4537
Property Owner:	Chris Turnage	(if different from	Applicant	
District:	PHD V NHPD	OEHPD	PHBD	GCD
* An application shall be deemed complete by the required information. Information. Project specifics/description	mestead – \$50.00 hearing feel other Residential – \$250.00 he oe scheduled to be heard once he Secretary to the Board. You Please see pages 3 – 4 of this ription: all of a 8x8 portable prefa	aring fee all required materi u will need to includ application for furt	de eight (8) co ther instructio	opies of the on and
, 				- Touristican
that no refund of these	licant, understand that payme e fees will be made. I have rev t be present on the date of the	iewed the applicab	ole zoning requ	uirements and
Swand	an Hudran			.23.2023
Applic	ant Signature			Date

Planning Services 222 W. Main Street * Pensacola, Florida 32502 (850) 435-1670

Mail to: P.O. Box 12910 * Pensacola, Florida 32521





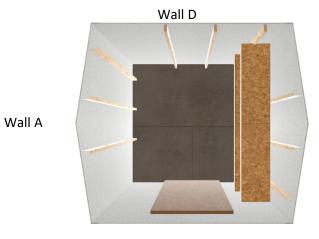

Wall C

Wall B

Base Details

Building Size & Style

Premier Ranch - 8' wide by 8' long

Door

4' x 6'2" Single Shed Door, Left Hinge Placement

Paint Selection

Base: Ghost Writer, Trim: Delicate White

Roof Selection

Charcoal Dimensional Premium Shingle

Drip Edge

White

Is a permit required for this job?

Who is pulling the permit?

Tuff Shed

Options Details

High Wind

High Wind - Retail

Roof

8 Lin Ft Ridge Vent

Floor and Foundation

4 Ea Shed Anchor into Dirt - Auger or MR88

Interior

16 Lin Ft Shelving - 16" deep

Vents

2 Ea 16"x8" Wall Vent - White

Shelving Locations

Shelving on Side C at 39", 60".

Jobsite/Installer Details

Do you plan to insulate this building after Tuff Shed installs it?

Nο

Is there a power outlet within 100 feet of installation location?

Yes

Will there be 18" of unobstructed workspace around the perimeter of all four walls?

Can the installers park their pickup truck & trailer within approximately 200' of your installation site?

Substrate Shed will be installed on?

Dirt/Gravel

Signature:



UNINHABITED UTILITY SHED UP TO 12' WIDE x UP TO 24' LONG SR600, TR700, PR

NOTES:

- BUILDING CODE: FLORIDA BUILDING CODE, 7th EDITION (2020) BUILDINGS ARE NOT FOR HIGH-VELOCITY HURRICANE ZONES (HVHZ)
- **DESIGN LOADING:**

WIND SPEED: $V_{ult} = 165$ $V_{asd} = 128$

EXPOSURE: С

ROOF LIVE LOAD: 20 PSF ROOF DEAD LOAD: 10 PSF

FLOOR LIVE LOAD: MIN. 50 PSF (SEE NOTE 5, DETAIL 1, SHEET 3)

RISK CATEGORY: I

COMPONENT AND CLADDING: ROOF: WIND PRESSURE (psf) (ASD VALUES)

(BASED ON 10 SQ FT)

36/-39 PSF (ZONE 4) WALL: 36/-48 PSF (ZONE 5)

21/-33 PSF (ZONE 1)

21/-57 PSF (ZONE 2)

21/-84 PSF (ZONE 3)

8'-31/16"

8'-5"

HEADER NAILING:

HEADER TO STUD - 4-16d END NAIL DOUBLED HEADER

- 16d @ 16" STAGGERED FACE NAIL

NAILING:

10'

REFER TO SHEET 2 FOR WALL AND ROOF SHEATHING NAILING.

MAX WALL HEIGHT FOR EACH SHED:

6'-81/4"

6'-81/4'

SR600 - 5'-81/4" (681/4")

4/12

4/12

	TR700 - 6'-8¼" (80¼") PR - 6'-8¼" (80¼")							
SHED S	SHED SIZE CHART							
WIDTH	PITCH	SIDEWALL HEIGHT	OVERALL HEIGHT	MID-ROOF HEIGHT				
6'	4/12	5'-81/4"	7'-5 ¹³ / ₁₆ "	6'-111/8"				
8'	4/12	5'-81/4"	7'-9 ¹ / ₁₆ "	7'-1½ ₆ "				
10'	4/12	5'-81/4"	8'-1 ⁹ / ₁₆ "	7'-3½ ₁₆ "				
12'	4/12	5'-81/4"	8'-5½"	7'-5"				
6'	4/12	6'-81/4"	8'-5 ¹³ / ₁₆ "	7'-111/8"				
8'	4/12	6'-81/4"	8'-9 ¹ / ₁₆ "	8'-1½"				

9'-1%

9'-5½'

ROOF SHEATHING (7/16" OSB)				
WIDTH	LENGTH		EDGE NAILING	
6'		8d NAILS @ 12" O.C.		
8'		8d NAILS @ 12" O.C.		
10'		8d NAILS @ 12" O.C.		
12'	12'-24'	8d NAILS @ 12" O.C.	8d NAILS @ 4" O.C.	

1. USE 8d COMMON OR GALVANIZED BOX NAILS.

3/8" SMARTSIDE NAILING REQUIREMENTS FOR SR600, TR700, AND PR				
SIDEWA	LL NAILIN	G (MIN. 2'-0" RETURI	N EACH END)	
WIDTH	LENGTH		EDGE NAILING	
6'	6'-20'		8d NAILS @ 3" O.C.	
8'	8'-24'		8d NAILS @ 3" O.C.	
10'	10'-24'		8d NAILS @ 3" O.C.	
12'	12'-24'	8d NAILS @ 6" O.C.	8d NAILS @ 3" O.C.	

3/8" SMARTSIDE NAILING REQUIREMENTS FOR SR600, TR700, AND PR				
END WA	LL NAILIN	G (MIN. 2'-0" RETURI	N EACH END)	
WIDTH	LENGTH			
6'	6'-20'		8d NAILS @ 3" O.C.	
8'	8'-24'		8d NAILS @ 3" O.C.	
10'	10'-24'		8d NAILS @ 3" O.C.	
12'	12'-24'	8d NAILS @ 6" O.C.	8d NAILS @ 3" O.C.	

FL PRODUCT APPROVALS	MANUFACTURER	MODEL	EL DDODUCT#
PRODUCT TYPE	MANUFACTURER	MODEL	FL PRODUCT #
SIDING (PANEL)	LP BUILDING SOLUTIONS	SIDING	FL9190.3
SIDING (LAP)	JAMES HARDIE BUILDING PRODUCTS, INC	LAP	FL10477.1
SIDING (CEMENT)	JAMES HARDIE BUILDING PRODUCTS, INC	CEMENT STUCCO	FL13223.2
IMPACT SLIDING WINDOW	ECO IMPACT SLIDER	IMPACT SLIDER	NOA 19-0219.08
SLIDING WINDOW	TAFCO CORPORATION	SLIDER	FL20743.1
TUFF SHED DOUBLE DOOR	TUFF SHED, INC.	SHED DOOR	FL22202.1
TUFF SHED DOUBLE DOOR (HVHZ)	TUFF SHED, INC.	SHED DOOR	FL22202.2
TUFF SHED SINGLE DOOR	TUFF SHED, INC.	SHED DOOR	FL22202.3
TUFF SHED SINGLE DOOR (HVHZ)	TUFF SHED, INC.	SHED DOOR	FL22202.4
STEEL DOOR INSWING	JELD-WEN	6 PANEL/3068	FL11136.1
STEEL DOOR OUTSWING	JELD-WEN	6 PANEL/3068	FL11136.2
FULL LITE DOOR	JELD-WEN	EXTERIOR DOOR	FL17454.1
9 LITE DOOR INSWING	JELD-WEN	EXTERIOR DOOR	FL12509.2
9 LITE DOOR OUTSWING	JELD-WEN	EXTERIOR DOOR	FL12509.4
FLOOD VENTS	FLOOD SOLUTIONS	FOUNDATION	FL17588.1
RIDGE VENTS	GAF COBRA RIDGE RUNNER	RIDGE VENT	NOA 17-0822.06
RIDGE VENTS	GAF COBRA RIGID VENT3	RIDGE VENT	FL6267.1
IMPACT RESISTANT OVERHEAD	OVERHEAD DOOR CORP	GARAGE DOOR	FL14170.6
GARAGE DOOR			
ROOF UNDERLAYMENT	GAF	FELTBUSTER	FL18686.1
ASPHALT SHINGLES	GAF	SHINGLES	FL10124.1
METAL ROOFING	MARLYN METALS, INC	MAR-RIB	FL8993

SIDING TABLE NOTES:

- 1. NAILING IS FOR 3/8" SMARTSIDE PANEL OR 3/8" SMARTSIDE WITH FOIL BACKER.
 2. MINIMUM 2'-0" RETURN FROM EACH END OF EACH WALL.
- 3. NO SINGLE OPENING GREATER THAN 8'-0"
- 4. * 6' WIDE X 6'-9' LENGTH BUILDINGS ARE BASED ON 3-SIDED DIAPHRAGM. THE END WALL OPPOSITE OF THE OPENING MUST BE FULLY SHEATHED, IN THE 3-SIDED DIAPHRAGM CASES. THE END WALL WITH
- THE OPENING DOES NOT HAVE A MIN. RETURN WALL ON EACH SIDE OF THE OPENING. 5. USE COMMON OR GALVANIZED BOX NAILS.
- 6. ON THESE BUILDINGS 6' X 10' THE 3' DOOR IN THE END WALL WILL NEED TO BE OFF SET. THERE WILL BE A 2' PANEL ON ONE SIDE AND A 1' PANEL ON THE OTHER SIDE OF THE DOOR.
- 7. BUILDING SIZES BELOW REQUIRE SHEATHING ON BOTH SIDES OF WALL WITH OPENING (7/16)" OSB ON
- INSIDE OF WALL):
 - 6'X10' WITH 3' OF OPENING ON END WALL WITH 2' OF SHEAR (SEE NOTE 6)
 - 8'X16'-24' WITH 3' OF OPENING ON END WALL WITH 5' OF SHEAR 8'X14'-22' WITH 4' OF OPENING ON END WALL WITH 4' OF SHEAR

 - 10'X20'-24' WITH 3' OF OPENING ON END WALL WITH 7' OF SHEAR 10'X18'-24' WITH 4' OF OPENING ON END WALL WITH 6' OF SHEAR
 - 10'X12'-24' WITH 6' OF OPENING ON END WALL WITH 4' OF SHEAR
- 12'X18'-24' WITH 6' OF OPENING ON END WALL WITH 6' OF SHEAR 12'X14'-24' WITH 8' OF OPENING ON END WALL WITH 4' OF SHEAR
 8. NO OPENINGS ARE ALLOWED ON THE END WALLS OF 6' WIDE BUILDINGS LONGER THAN 14'. THE
- ENDWALL OF 6' WIDE X 10'-14' LONG BUILDINGS MAY HAVE A SINGLE 2' OPENING CENTERED ON THE WALL.




	Order #.	Ρ.
	Customer:	Dr
s	Site Address:	Da
s		Cł
	Building Size:width-length-height-sq.ft.area	Da
		Sc


P.O. #	THESE DRAWINGS DESIGN ARE THE
rawn By: PK	OF TUFF SHED, IN
oate: 6/21/21	DRAWINGS ARE F BUILDING TO BE S
checked By:	AND BUILT BY <u>TU</u> ANY OTHER USE
ate:	FORBIDDEN BY BOUND SHED AND THE ED
cale: N.T.S.	RECORD.

S AND THE TUFF SHED, INC. **PROPERTY** ENGINEERING DEPARTMENT NC. THESE OR A SUPPLIED RICHARD J. WILLS, P.E. JFF SHED. RWILLS@TUFFSHED.COM 1777 S. HARRISON STREET BOTH TUFF DENVER, COLORADO 80210 NGINEER OF (303) 753-8833 EXT. 96315

TITLE **PROJECT NOTES** NAILING REQUIREMENTS FBC, 7th EDITION (2020) 162C


DRAWING NO. FL-PR-SR-TR-01 REV. LEVEL 01 SHEET **PAGE** 1 **OF** 4

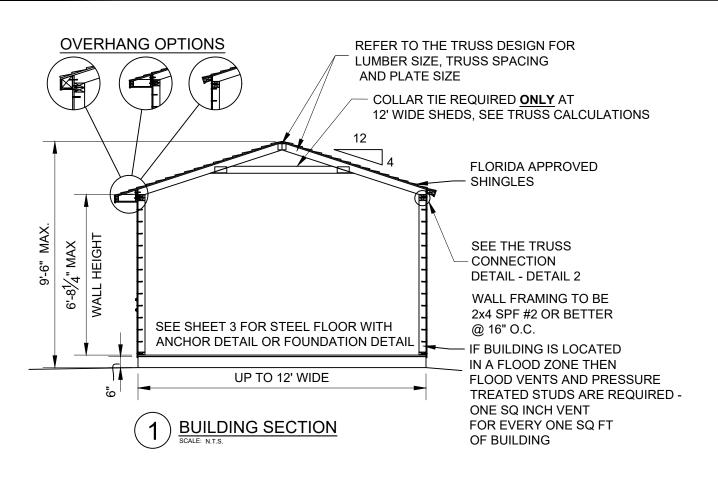

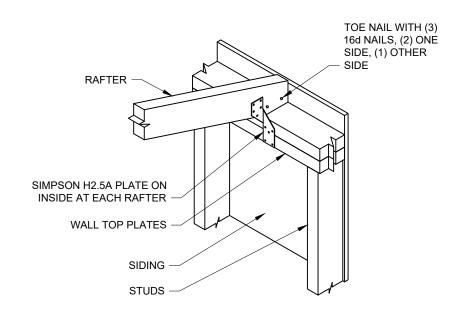


2 TRUSS TO WALL CONNECTION DETAIL

SCALE: N.T.S.

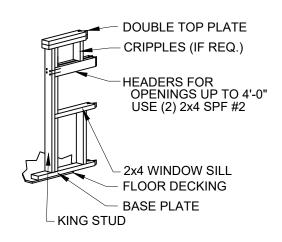

FOR WINDOW OPENINGS UP TO 4'-0"

WINDOW HEADER DETAIL
FOR SIDE WALLS

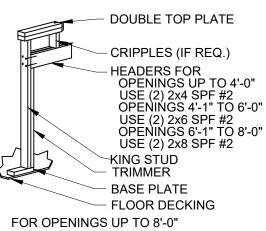

DOOR HEADER DETAIL FOR SIDE WALLS


HEADERS FOR:

OPENINGS LIB TO 6' 0" LISE (2) 2x4 SPE #2

HEADERS FOR: ——/
OPENINGS UP TO 6'-0" USE (2) 2x4 SPF #2
OPENINGS 6'-1" TO 8'-0" USE (2) 2X6 SPF #2
REFER TO THE DOOR DETAIL (SHEET 2) FOR
THE DOOR DESIGN

HEADER DETAIL FOR END WALLS

SEE PROJECT NOTES FOR MATERIALS

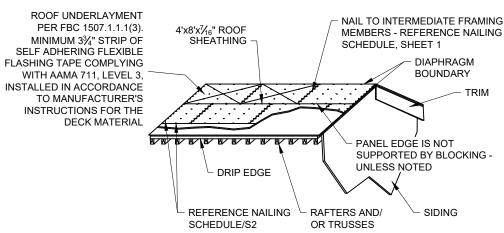

5 ROOF SHEATHING AND UNDERLAYMENT DETAIL

TUFF SHED

Storage Buildings & Garages

TUFF SHED, MFG. FACILITIES

Order #. _____ F
Customer: _____ C
Site Address: _____ C
Building Size:width-length-height-sq.ft.area

P.O. #
Drawn By: PK
Date: 6/21/21
Checked By:
Date:
Scale: N.T.S.

THESE DRAWINGS AND THE DESIGN ARE THE PROPERTY OF TUFF SHED, INC. THESE DRAWINGS ARE FOR A BUILDING TO BE SUPPLIED AND BUILT BY TUFF SHED. ANY OTHER USE IS FORBIDDEN BY BOTH TUFF SHED AND THE ENGINEER OF RECORD


TUFF SHED, INC. ENGINEERING DEPARTMENT

RICHARD J. WILLS, P.E. RWILLS@TUFFSHED.COM 1777 S. HARRISON STREET DENVER, COLORADO 80210 (303) 753-8833 EXT. 96315 BUILDING SECTIONS
HEADER FRAMING DETAILS

FBC, 7th EDITION (2020)

PRAWING NO.
FL-PR-SR-TR-01
REV. LEVEL 01
SHEET 2

PAGE 2 **OF** 4

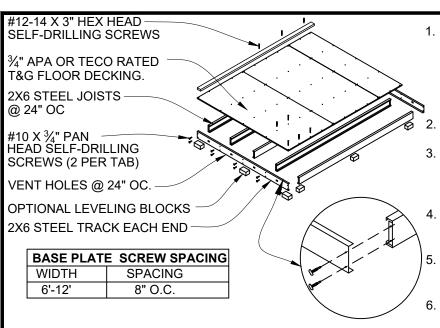


1. STEEL SHED FOUNDATION:

600T125-054 - 16 GAUGE STEEL TRACKS G140 ZINC COATED 600S137-054 - 16 GAUGE STEEL JOISTS G140 ZINC COATED @ 24" O.C.

(SUPPLIER: ALLIED STUDCO (JOIST: 600S137-054 / TRACK: 600T125-054) ICC ER-4943P.

- ¾" APA OR TECO RATED TONGUE AND GROOVE FLOOR DECKING. 24" MAX PANEL SPAN. STAGGER PANEL LAYOUT.
- 3. FASTEN FLOOR DECKING TO JOIST & TRACKS USING #8 x 1⁵/₈" ZINC PLATED SCREWS @ 12" O.C. NO BLOCKING REQUIRED. ALL EDGES SHALL LIE ON FLOOR JOISTS. STAGGER PANEL LAYOUT PER APA CONDITION 1.
- 4. FASTEN SOLE PLATE THROUGH FLOOR DECKING INTO JOISTS OR TRACKS WITH #12-14 X 3" GALVANIZED SELF-DRILLING SCREWS. REFERENCE SPACING CHART.
- ALLOWABLE FLOOR LIVE LOAD: 75 PSF FOR STEEL JOISTS CONTINUOUSLY SUPPORTED. 50 PSF FOR JOISTS ON BLOCKS AS SHOWN.
- USE OPTIONAL CONCRETE BLOCKS AS REQUIRED TO LEVEL BUILDING:

SUGGESTED SIZES: 2" x 8" x 16", 4" x 8" x 16", OR 8" x 8" x 16". BLOCKS UNDER JOISTS SPACED @ 8'-0" O.C. MAXIMUM. BLOCKS UNDER TRACK SPACED @ 4'-0" O.C. MAXIMUM.

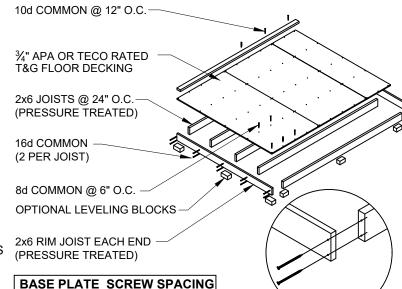

SPACING

8" O.C.

SHEET 3

1. WOOD SHED FOUNDATION: 2x6 #2 PRESSURE TREATED SPRUCE-PINE-FIR RIM JOISTS 2x6 #2 PRESSURE TREATED SPF JOISTS @ 24" O.C.

2. ¾" APA OR TECO RATED TONGUE AND GROOVE FLOOR DECKING. 24" MAX PANEL SPAN. NO BLOCKING REQUIRED. ALL EDGES SHALL LIE ON FLOOR JOISTS. STAGGER PANEL LAYOUT PER APA CONDITION 1. NAIL PLYWOOD TO JOISTS AND RIM JOISTS:

BORDER: 8d COMMON SPACED @ 6" O.C. EDGE: 8d COMMON SPACED @ 6" O.C.

FIELD: 8d COMMON SPACED @ 12" O.C.
4. FASTEN SOLE PLATE THROUGH FLOOR DECKING INTO

- JOISTS OR RIM JOISTS WITH 10d COMMON SPACED @ 12" O.C.
- 5. ALLOWABLE FLOOR LIVE LOAD: 40 PSF
- 6. USE OPTIONAL CONCRETE BLOCKS AS REQUIRED TO LEVEL BUILDING:

SUGGESTED SIZES: $2" \times 8" \times 16"$, $4" \times 8" \times 16"$, OR $8" \times 8" \times 16"$ BLOCKS UNDER JOISTS SPACED @ 8'-0" O.C. MAXIMUM. BLOCKS UNDER RIM JOISTS SPACED @ 4'-0" O.C. MAXIMUM.

1) OPTIONAL STEEL SHED BASE DETAIL SCALE: N.T.S.

ATTACH BRACKET TO

ANCHOR PLATE WITH

3/8"Ø x 4" CARRIAGE BOLT

STUD THRU HOLE IN

AND LOCKNUT

CORNER STUD

TRIM

2X4X2'-BLOCK

SHED BASE

SIDING

AUGER ANCHOR COMPONENTS BY OLIVER TECHNOLOGIES

PART NUMBERS:

OT3644GPMP- %" X 36" (36" IMBED) GALVANIZED AUGER OT17SWB - SIDEWALL BRACKET FOR USE WITH THRU BOLTS REPORT NO. LO-FJ90129-A

-OR-

STUD

END WALL

OPTIONAL AUGER ANCHOR DETAIL

OT24SWBSIDEWALL BRACKET FOR USE WITH THRU BOLTS REPORT NO. LO-FJ90129-B

WORKING LOAD FOR ANCHOR SYSTEM IS 3,150 LBS
WITH THE MAXIMUM LOAD OF 5,080 LBS

SIDING

TRIM


ANCHOR BRACKET

TO BE FLUSH WITH

EDGE OF TRIM

AUGER ANCHORS			
WIDTH	LENGTH	# OF ANCHORS	
6'	6'-20'	4 ANCHORS	
8'	8'-20'	4 ANCHORS	
8'	22'-24'	6 ANCHORS	
10'	10'-16'	4 ANCHORS	
10'	18'-24'	6 ANCHORS	
12'	12'-14'	4 ANCHORS	
12'	16'-22'	6 ANCHORS	
12'	24'	8 ANCHORS	

4-ANCHORS PROVIDE (1) AT EA. CORNER OF THE BUILDING. 6-ANCHORS PROVIDE (1) AT EA. CORNERS OF THE BUILDING AND (1) AT THE CENTER OF EA. SIDE WALL. 8-ANCHORS PROVIDE (1) AT EA. CORNERS OF THE BUILDING AND (1) AT THE CENTER OF EACH WALL.

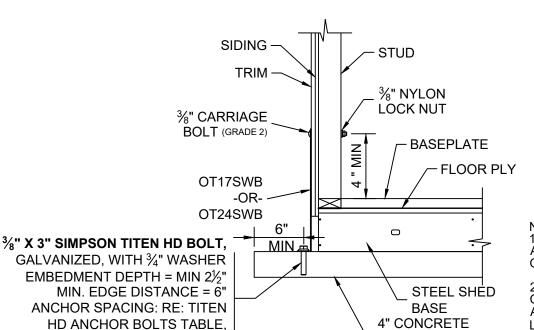

TITEN HD ANCHOR BOLTS					
INTO CO	INTO CONCRETE) RE: DETAIL 3 SHEET 3				
WIDTH	LENGTH	QTY			
6'	6'-10'	4			
6'	12'-20'	6			
8'	8'-16'	6			
8'	18'-24'	8			
10'	10'-16'	6			
10'	18'-20'	8			
10'	22'-24'	10			
12'	12'-18'	8			
12'	20'-22'	10			
12'	24'	12			

NOTES:

OPTIONAL WOOD SHED BASE DETAIL

1. ANCHORS TO BE SIMPSON TITEN HD ANCHORS. ANCHORS MAY BE GALVANIZED OR STAINLESS STEEL.

2. PROVIDE (1) ANCHOR AT EA. CORNER OF THE BUILDING. THE REMAINING ANCHORS EQUALLY SPACED ALONG THE LENGTH OF THE BUILDING. (½ THE REMAINING ANCHORS ON EA. LENGTH SIDE EQUALLY SPACED).

4) OPTIONAL SIDEWALL BRACKET DETAIL

TUFF SHED, MFG. FACILITIES

Order #.	P.0
Customer:	Dra
Site Address:	Da
Site Address:	
Building Size:wdth-length-height-sq.ft.area	Da
	Sc

P.O. #		
Drawn By: PK		
Date: 6/21/21		
Checked By:		
Date:		
Scale: N.T.S.		

THESE DRAWINGS AND THE
DESIGN ARE THE PROPERTY
OF TUFF SHED, INC. THESE
DRAWINGS ARE FOR A
BUILDING TO BE SUPPLIED
AND BUILT BY TUFF SHED.
ANY OTHER USE IS
FORBIDDEN BY BOTH <u>TUFF</u>
SHED AND THE ENGINEER O
RECORD

ENGINEERING DEPARTMENT
RICHARD J. WILLS, P.E.
RWILLS@TUFFSHED.COM
1777 S. HARRISON STREET
DENVER COLORADO 80210

(303) 753-8833 EXT. 96315

TUFF SHED, INC.


WIDTH

6'-12'

TITLE	DRAWING NO.	
DETAILS	FL-PR-SR-TR-01	
	REV. LEVEL 01	
FBC, 7th EDITION (2020)	SHEET 3	
162C	PAGE 3 OF 4	

PAD (MIN)

19	JAN	2022

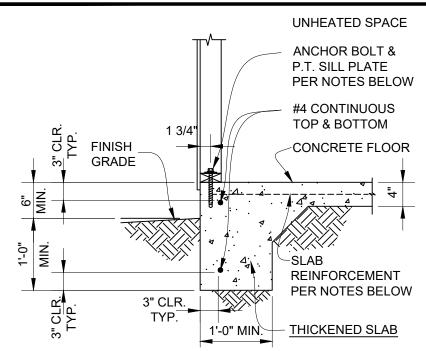

CONTINUOUS FOOTING NOTES

TOP OF SLAB TO BE 6" MIN. ABOVE GRADE. SLAB REINFORCEMENT SHALL BE WWF 6X6 W1.4xW1.4 . LOCATE AT MID-DEPTH OF SLAB.

SLAB REINFORCEMENT SHALL BE FIBERMESH 150 OR BLENDED FIBERMESH150. FIBERMESH SHOULD BE DISPERSED UNIFORMLY THROUGH CONCRETE W/ MIN. 1 POUND PER CUBIC YARD OF CONCRETE.


- ALL FOOTING FORMS SHALL BE INSPECTED FOR SIZE AND REINFORCING BEFORE POURING CONCRETE.
- FOOTINGS SHALL BEAR ON UNDISTURBED NATURAL, COMPETENT SOIL, OR PROPERLY COMPACTED STRUCTURAL FILL. ALLOWABLE SOIL BEARING PRESSURE IS 1000 PSF AT 12" BELOW GRADE.
- CONCRETE: MINIMUM 28 DAY COMPRESSIVE STRENGTH, fc = 2500 PSI.
- REINFORCING STEEL: A615, GRADE 40 OR GRADE 60. ALL REINFORCING STEEL SHOWN TO BE CONTINUOUS MAY BE LAPPED A MINIMUM OF 38 BAR DIAMETERS OR 24" MINIMUM, WHICHEVER IS LARGER.
- SEISMIC DESIGN CATEGORY: A
 - A. ATTACH PRESSURE TREATED SOLE PLATE TO THE FOOTING USING 1/2"Ø X 8" LONG SIMPSON TITEN HD ANCHOR WITH WASHERS.
 - EXPANSION BOLTS SHALL BE EMBEDDED AT LEAST 5" INTO THE CONCRETE AND SHALL BE SPACED NOT MORE THAN 6' OC.
 - THERE SHALL BE A MINIMUM OF 2 BOLTS PER SOLE PLATE PIECE WITH 1 BOLT LOCATED NOT MORE THAN 12" NOR LESS THAN 7 BOLT DIAMETERS FROM EACH END OF EACH PIECE.

FOR BUILDINGS 18' AND LONGER OR ANY BUILDING DESIGNED AS A 3-SIDED DIAPHRAGM, ADD SIMPSON SSTB16 ANCHORS AND HDU2 HOLD DOWNS AT EACH CORNER OF THE END WALLS. FOLLOW MANUFACTURER'S INSTALLATION INSTRUCTIONS.




OPTIONAL CONCRETE FOUNDATION DETAIL

11/16" 3X4 20 PLATES 1 EACH SIDE 3'-0" 3'-1 7/8" 12 6'-0" 5/8"

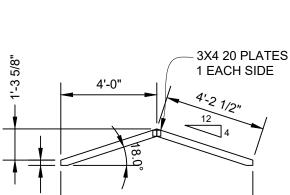

8'-0"

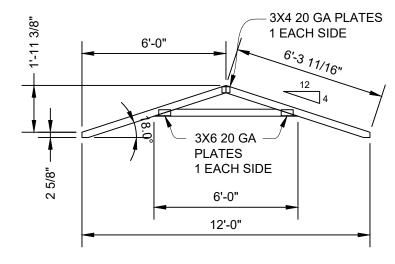

5'-0"

2/8"

N

18.0°

10'-0"

DESIGN LOADS: TOP CHORD LIVE LOAD = 20 PSF TOP CHORD DEAD LOAD = 10 PSF COLLAR TIE DEAD LOAD = 5 PSF

MAXIMUM DEFLECTION (12 FT. SPAN) VERT LL: 0.06 in. VERT TL: 0.08 in.

NOTES:

5/8'

 α

FBC, 7th EDITION (2020) ANSI/TPI 1-2014 TRUSSES TO BE SPACED @ 24" OC MATERIAL TO BE 2X4 SPRUCE PINE FIR GRADE #2 OR BETTER PLATES ARE TO BE PRESSED IN THE WOOD PER TPI.

REP MEMBER INCREASE: YES LUMBER D.O.L.: 1.25

ASCE 7-16, 162 mph, Exposure C, D.O.L.=1.60

PLATES ARE MANUFACTURED BY EAGLE METAL PRODUCTS, ICC-ES #ESR-1082.

6' SPAN **REACTIONS:** 3X4 20 GA PLATES MAX. VERTICAL: 180 LBS. 1 FACH SIDE MAX. UPLIFT: -195 LBS. 5'-3 _{1/16"} NOTE:

TRUSS MAY BE USED ON BUILDING LENGTHS UP TO 12FT UNLESS CEILING JOIST OR OTHER TENSION TIE IS PROVIDED.

8' SPAN **REACTIONS:**

MAX. VERTICAL: 240 LBS. MAX. UPLIFT: -245 LBS.

NOTE:

TRUSS MAY BE USED ON BUILDING LENGTHS UP TO 14FT UNLESS CEILING JOIST OR OTHER TENSION TIE IS PROVIDED.

10' SPAN **REACTIONS:** MAX. VERTICAL: 300 LBS. MAX. UPLIFT: -310 LBS.

NOTE:

TRUSS MAY BE USED ON BUILDING LENGTHS UP TO 20FT UNLESS CEILING JOIST OR OTHER TENSION TIE IS PROVIDED.

12' SPAN **REACTIONS:** MAX. VERTICAL: 390 LBS. MAX. UPLIFT: -400 LBS.

NOTE:

TRUSS MAY BE USED ON BUILDING LENGTHS UP TO 24FT UNLESS CEILING JOIST OR OTHER TENSION TIE IS PROVIDED.

ALL PERSONS FABRICATING. HANDLING. ERECTING OR INSTALLING THIS TRUSS ARE TO DO SO IN ACCORDANCE TO THE RECOMMENDATIONS OF THE LATEST VERSION OF THE BCSI.

Storage Buildings & Garages

TUFF SHED, MFG. FACILITIES 8524 EAST COLONIAL DRIVE ORLANDO, FL 32817 STORE 520

Order #. Customer: Site Address: Building Size:width - length - height - sq. ft. are Scale: N.T.S.

P.O. # Drawn By: PK Date: 6/21/21 Checked By: Date:

THESE DRAWINGS AND THE **DESIGN ARE THE PROPERTY** OF TUFF SHED, INC. THESE DRAWINGS ARE FOR A **BUILDING TO BE SUPPLIED** AND BUILT BY TUFF SHED. ANY OTHER USE IS FORBIDDEN BY BOTH TUFF SHED AND THE ENGINEER OF RECORD

TUFF SHED, INC. ENGINEERING DEPARTMENT

RICHARD J. WILLS, P.E. RWILLS@TUFFSHED.COM 1777 S. HARRISON STREET DENVER, COLORADO 80210 (303) 753-8833 EXT. 96315


TITLE TRUSS DETAILS

FBC, 7th EDITION (2020) 162C

DRAWING NO. FL-PR-SR-TR-01 REV. LEVEL 01 SHEET

PAGE 4 OF 4

Turnage, C. 1414 N. Baylen St., Pensacola, FL 32501

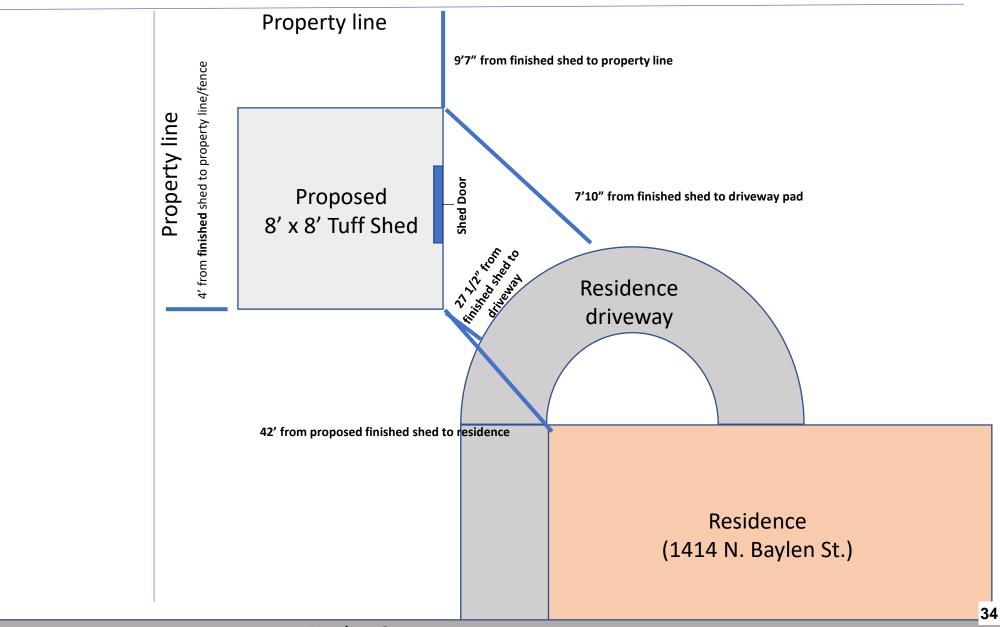



From: Savannah Hudson

Sent: Friday, May 26, 2023 3:14 PM

To: Adrianne Walker
Cc: Gregg Harding

Subject: Re: [EXTERNAL] 1414 North Baylen Street Pensacola, FL 32501 / ARB

Application

The vertical siding is staying.

The roof pitch of primary home is unknown.

Max floor elevation is 4". Customer is responsible for any coverings such as plants, lattice, or stones around the bottom of the shed once we receive a passed final building inspection. Photo is attached as to what the customer is willing to do.



Savannah Hudson

Tuff Shed, Inc. - Permit Technician

Factory 600 - Mobile, AL

Direct: 251-244-4537

From: Adrianne Walker < AWalker@cityofpensacola.com>

Sent: Thursday, May 25, 2023 10:23 AM

To: Savannah Hudson <shudson2@TUFFSHED.com> **Cc:** Gregg Harding <GHarding@cityofpensacola.com>

Subject: RE: [EXTERNAL] 1414 North Baylen Street Pensacola, FL 32501 / ARB Application



City of Pensacola

Memorandum

File #: 23-00461 Architectural Review Board 6/15/2023

TO: Architectural Review Board Members

FROM: Adrianne Walker, Cultural Resources Coordinator

DATE: 6/8/2023

SUBJECT:

613 E. Romana Street Pensacola Historic District / Zone HR-2 / City Council District 6 New Construction of a Primary and Accessory Structure

BACKGROUND:

Christy Cabassa is seeking approval for a new two-story, wood pile supported primary structure and accessory garage with a second-story apartment. The finished floor elevation of the residence will be at 12 feet above sea level. The residence will have a true stucco exterior painted in the color Snowbound and trim in the color Touch of Grey, a vented Hardie board crawlspace, and an architectural asphalt shingle roof. The proposed windows are Windsor Pinnacle black metal wood clad with true divided lites, the front door is custom stained wood with impact glass, and the garage doors are Haas eight-panel insulated steel 2000 series painted in the color Touch of Grey. The project includes hardscaping with pavers, a Hardie board or pressure treated fence and landscape wall, and exterior lighting. This residence is in the brick structures district, Type II Cottage section of Aragon in a Coastal Caribbean style and has been approved by the Aragon ARB.

Please find attached all relevant documentation for your review.

RECOMMENDED CODE SECTIONS

Sec. 12-3-10(1)e. Historic zoning districts: HR-1, HR-2 and HC-2; Regulations and guidelines for any development within the historic zoning districts.

Sec. 12-3-10(1)h. New construction in the historic district.

613 E. Romana Street







Architectural Review Board Application Full Board Review

Appli	cation Date: May 12, 2023			
613 Romana Street				
Christy Cabassa, Architect for Ashley and Brian Keigley				
1189 Mary Lou Lane Gulf Breeze, Florida 32563				
christy931@mchsi.com	Phone: 850-712-5788			
Brian and Ashley Keigley 850-454-629				
PHD NHPD OEHPD	Applicant) PHBD GCD			
Application is hereby made for the project as described herein: Residential Homestead – \$50.00 hearing fee Commercial/Other Residential – \$250.00 hearing fee * An application shall be scheduled to be heard once all required materials have been submitted and it is deemed complete by the Secretary to the Board. You will need to include fourteen (14) copies of the required information. Please see pages 3 – 4 of this application for further instruction and information. Project specifics/description: The project is for a new 2 story, wood pile supported house and Garage with an apartment. The house is in an AE flood zone with a preliminary flood zone of AE 9' with a 3' free board. The FFE was set at 12' for the preliminary flood zone. The exterior shall be true stucco with a vented Hardi crawlspace and architectural asphalt shingles. The house is in the brick structures district and the style is Coastal Carribean variant as approved by the Aragon ARB, the house is 3304 sf and the garage is 700sf. There is a courtyard and small pool.				
ant, understand that payment of these fees do ees will be made. I have reviewed the applicab e present on the date of the Architectural Revie	le zoning requirements and			
	Christy Cabassa, Architect for Ashley 1189 Mary Lou Lane Gulf Breeze, Flor christy931@mchsi.com Brian and Ashley Keigley 850-454-629 (If different from OEHPD) ade for the project as described herein: nestead – \$50.00 hearing fee her Residential – \$250.00 hearing fee scheduled to be heard once all required mater a Secretary to the Board. You will need to include ase see pages 3 – 4 of this application for further. Attion: A 2 story, wood pile supported house and God zone with a preliminary flood zone of AE 9 reliminary flood zone. The exterior shall be extural asphalt shingles. The house is in the preliminary flood zone of AE 9 reliminary flood zone. The exterior shall be extural asphalt shingles. The house is in the preliminary flood zone of AE 9 reliminary flood zone. The exterior shall be extural asphalt shingles. The house is in the preliminary flood zone of AE 9 reliminary flood zone. The exterior shall be extural asphalt shingles. The house is in the preliminary flood zone of AE 9 reliminary flood zone. The exterior shall be extural asphalt shingles. The house is in the preliminary flood zone. The exterior shall be extural asphalt shingles. The house is in the preliminary flood zone. The exterior shall be extural asphalt shingles. The house is in the preliminary flood zone. The exterior shall be extural asphalt shingles. The house is in the preliminary flood zone. The exterior shall be extural asphalt shingles. The house is in the preliminary flood zone. The exterior shall be extural asphalt shingles. The house is in the preliminary flood zone. The exterior shall be extural asphalt shingles. The house is in the preliminary flood zone. The exterior shall be extural asphalt shingles. The house is in the preliminary flood zone. The exterior shall be extural asphalt shingles. The house is in the preliminary flood zone.			

Planning Services 222 W. Main Street * Pensacola, Florida 32502 (850) 435-1670 Mail to: P.O. Box 12910 * Pensacola, Florida 32521



Architectural Review Board Application Full Board Review

	Application Date: May 12, 2023				
Project Address:	613 Roma	ana Street			98
Applicant:	Christy Cabassa, Architect for Ashley and Brian Keigley				
Applicant's Address:	1189 Mary Lou Lane Gulf Breeze, Florida 32563				
Email:	christy93	31@mchsi.co	om	Phone: 850-7	12-5788
Property Owner:	Brian and	Ashley Keigle	y 850-454-629	9 keigley@gn	nail.com
District:	PHD	NHPD	(If different from OEHPD	Applicant) PHBD	GGD
Application is hereby made for the project as described herein: Residential Homestead — \$50.00 hearing fee Commercial/Other Residential — \$250.00 hearing fee * An application shall be scheduled to be heard once all required materials have been submitted and it is deemed complete by the Secretary to the Board. You will need to include fourteen (14) copies of the required information. Please see pages 3 — 4 of this application for further instruction and information. Project specifics/description: The project is for a new 2 story, wood pile supported house and Garage with an apartment. The					
house is in an AE floo					A CALL
was set at 12' for the p	reliminary fl	ood zone. The	xterior shall be	true stucco witl	h a vented Hardi
crawlspace and archit	ectural aspha	alt shingles. Ti	ne house is in th	e brick structur	es district and
the style is Coastal Carribean Variant as approved by the Aragon ARB, the house is 3304 sf					
-and the garage is 700sf. There is a courtyard and small pool					
I, the undersigned application of these from that I must keep applications and that I must keep applications are applicated applications.	ees will be mo	ade. I have review	ved the applicable	es not entitle me	ments and g.

Planning Services

222 W. Main Street * Pensacola, Florida 32502

(850) 435-1670

Mail to: P.O. Box 12910 * Pensacola, Florida 32521

Keigley Residence Aragon

613 East Romana Lot 2 Block M

Type II Cottage HR-2



Christina Lee Cabassa ARCHITECT

> Florida AR0014272 Florida ID0003615

1189 Mary Lou Lane Gulf Breeze, Florida 32563 Phone/Fax 850-916-9941

CERTIFICATION:

PROJECT - LOCATION

Keigley Residence Aragon

613 East Romana Lot 2 Block M

> Type II Cottage HR-2

ALL DRAWINGS AND WRITTEN MATERIAL HEREIN CONSTITUTE ORIGINAL AND UN-PUBLISHED WORK OF THE ARCHITECT AND MAY NOT BE DUPLICATED IN ANY PART WITHOUT THE WRITTEN CONSENT

REVISIONS :

City ARB Submittal

DRAWN BY: CLC

CHECKED BY: CLC

PROJECT NO.

SHEET TITLE


SHEET NO.:

Application

613 E. ROMANASTREET

SIDEWALK EASEMENT

\$ 79\[52'21"W 40.00' (P) \$ 79\[52'21''W 40.00' (A)

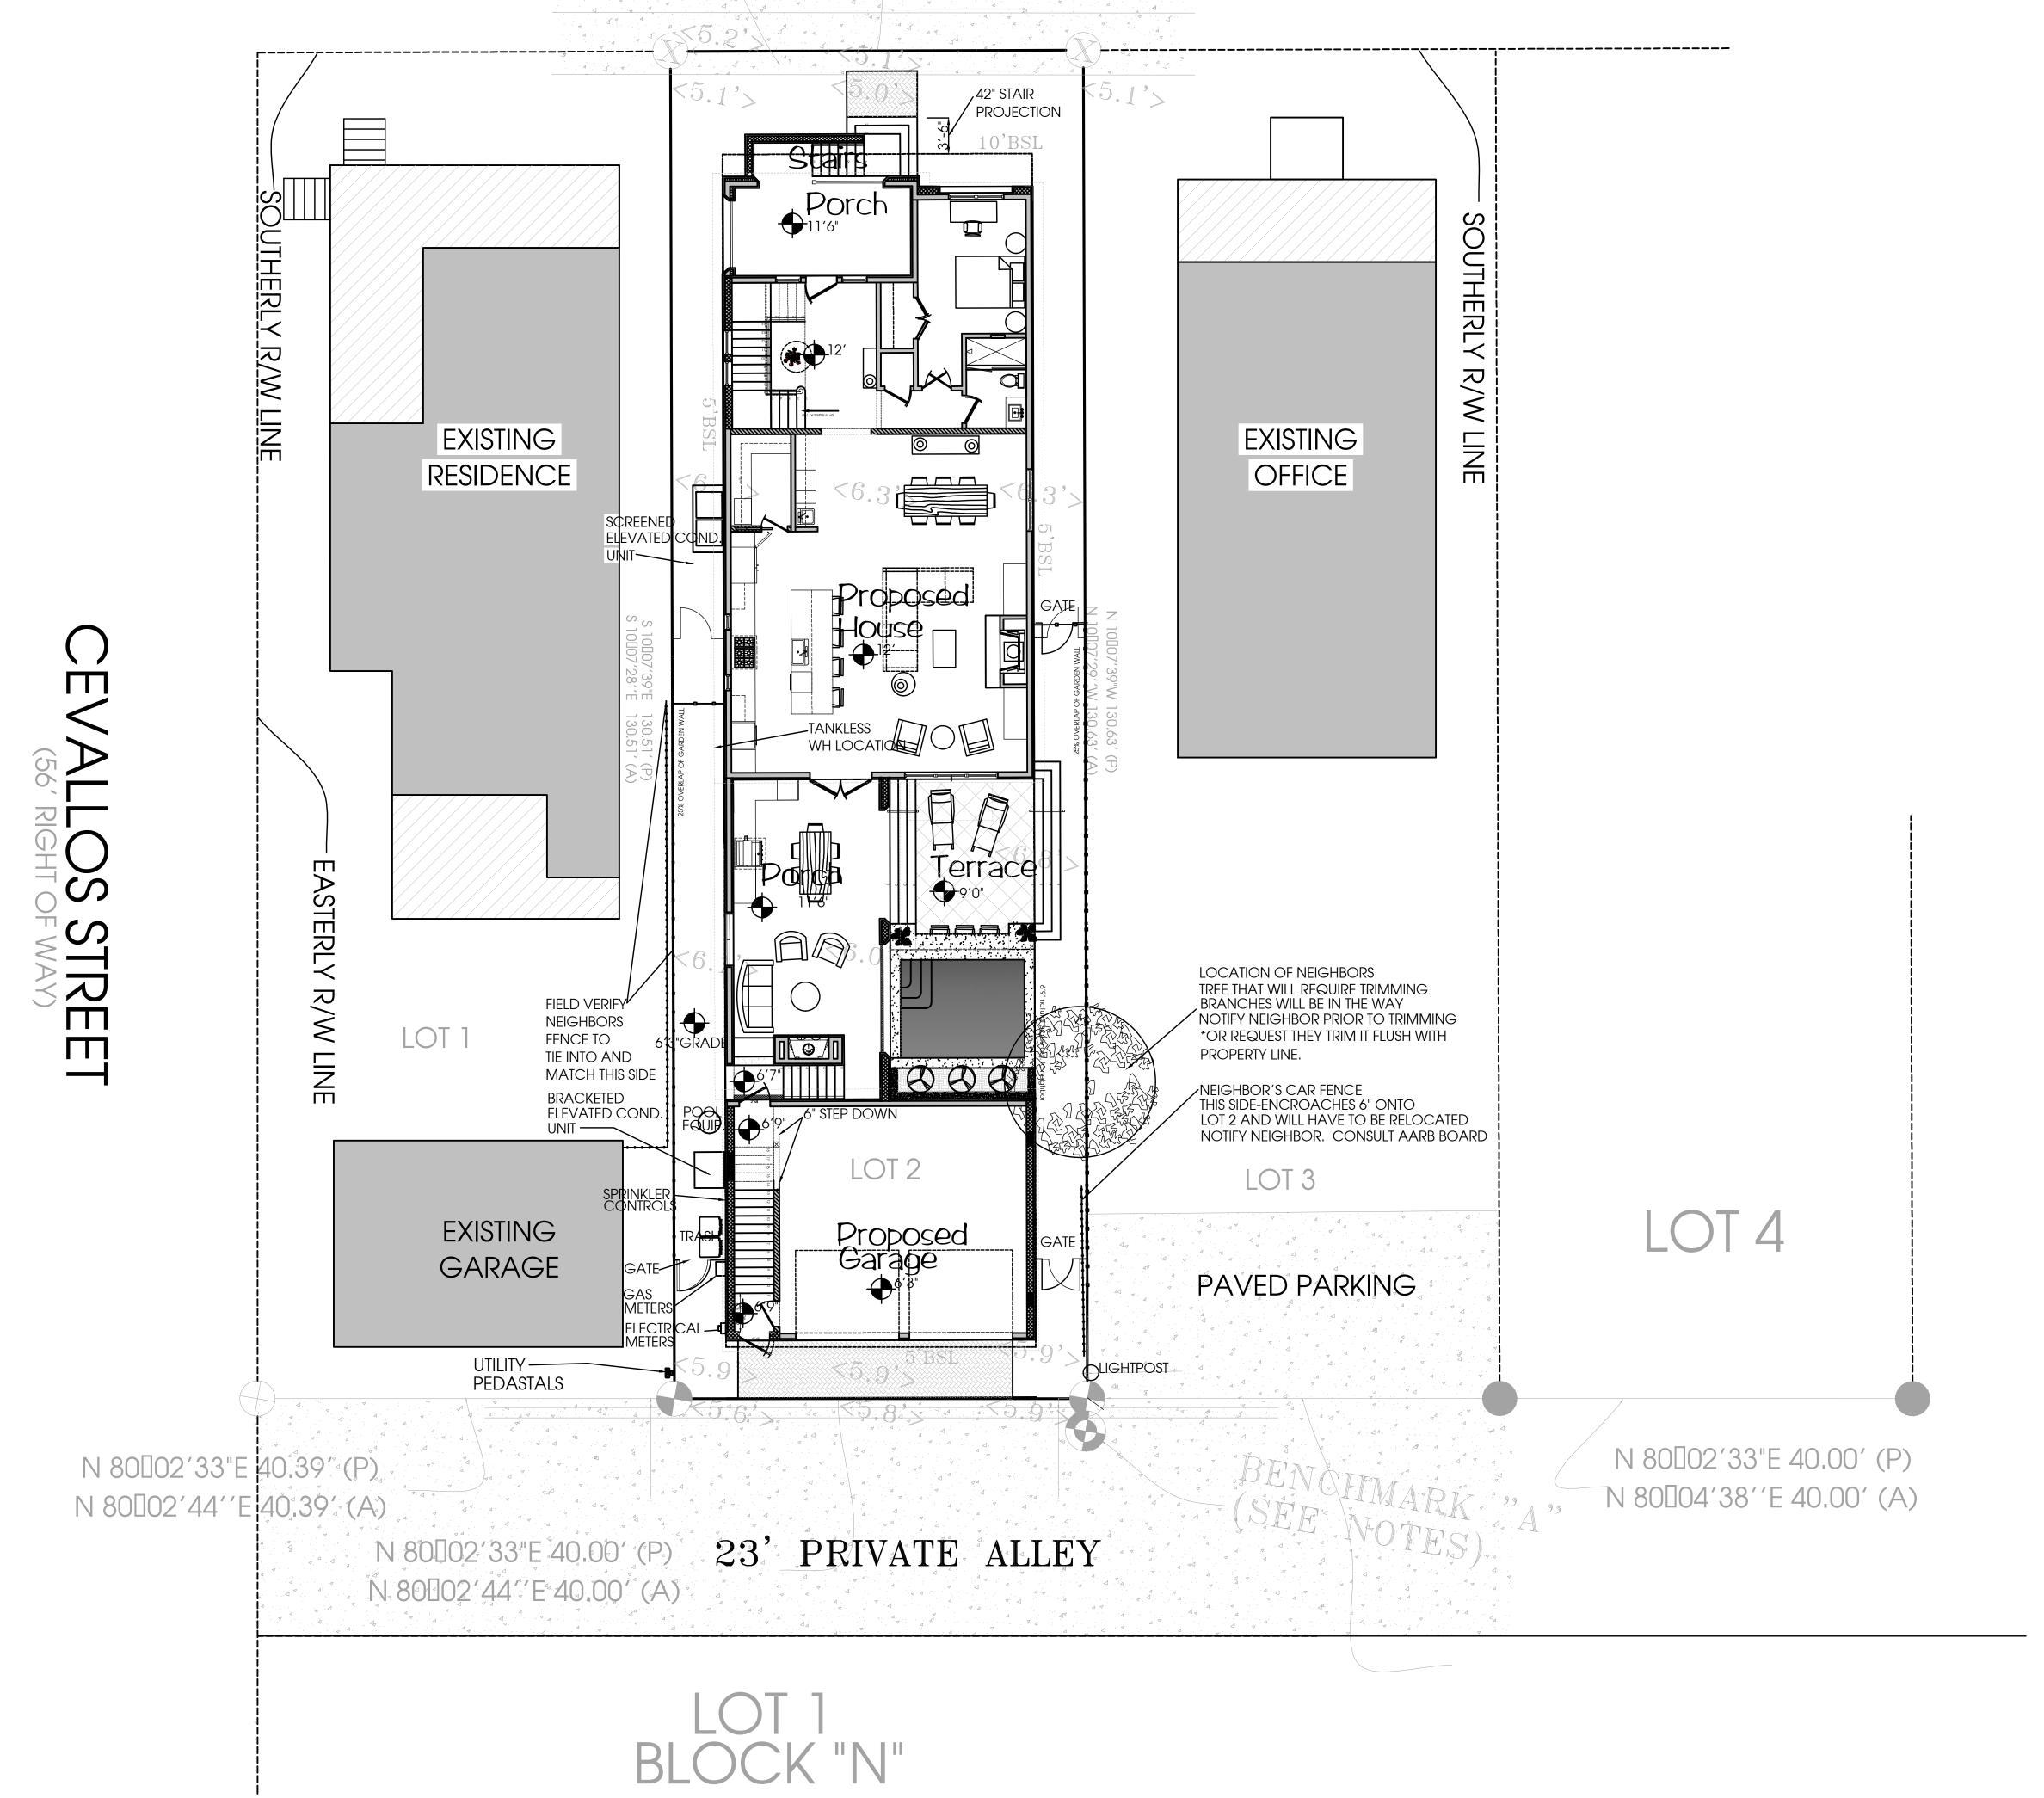





Christina Lee Cabassa ARCHITECT

> Florida AR0014272 Florida ID0003615

1189 Mary Lou Lane Gulf Breeze, Florida 32563 Phone/Fax 850-916-9941

CERTIFICATION

PROJECT - LOCATION :

Keigley Residence Aragon

613 East Romana Lot 2 Block M

> Type II Cottage HR-2

ALL DRAWINGS AND WRITTEN MATERIAL HEREIN CONSTITUTE ORIGINAL AND UN-PUBLISHED WORK OF THE ARCHITECT AND MAY NOT BE DUPLICATED IN ANY PART WITHOUT THE WRITTEN CONSENT OF THE ARCHITECT.

REVISIONS :

ity ARB Submittal May 12, 2023

DRAWN BY: CLC

CHECKED BY : CLC


PROJECT NO.


SHEET TITLE :


Area Siteplan

CUEET NO .

AS1-1

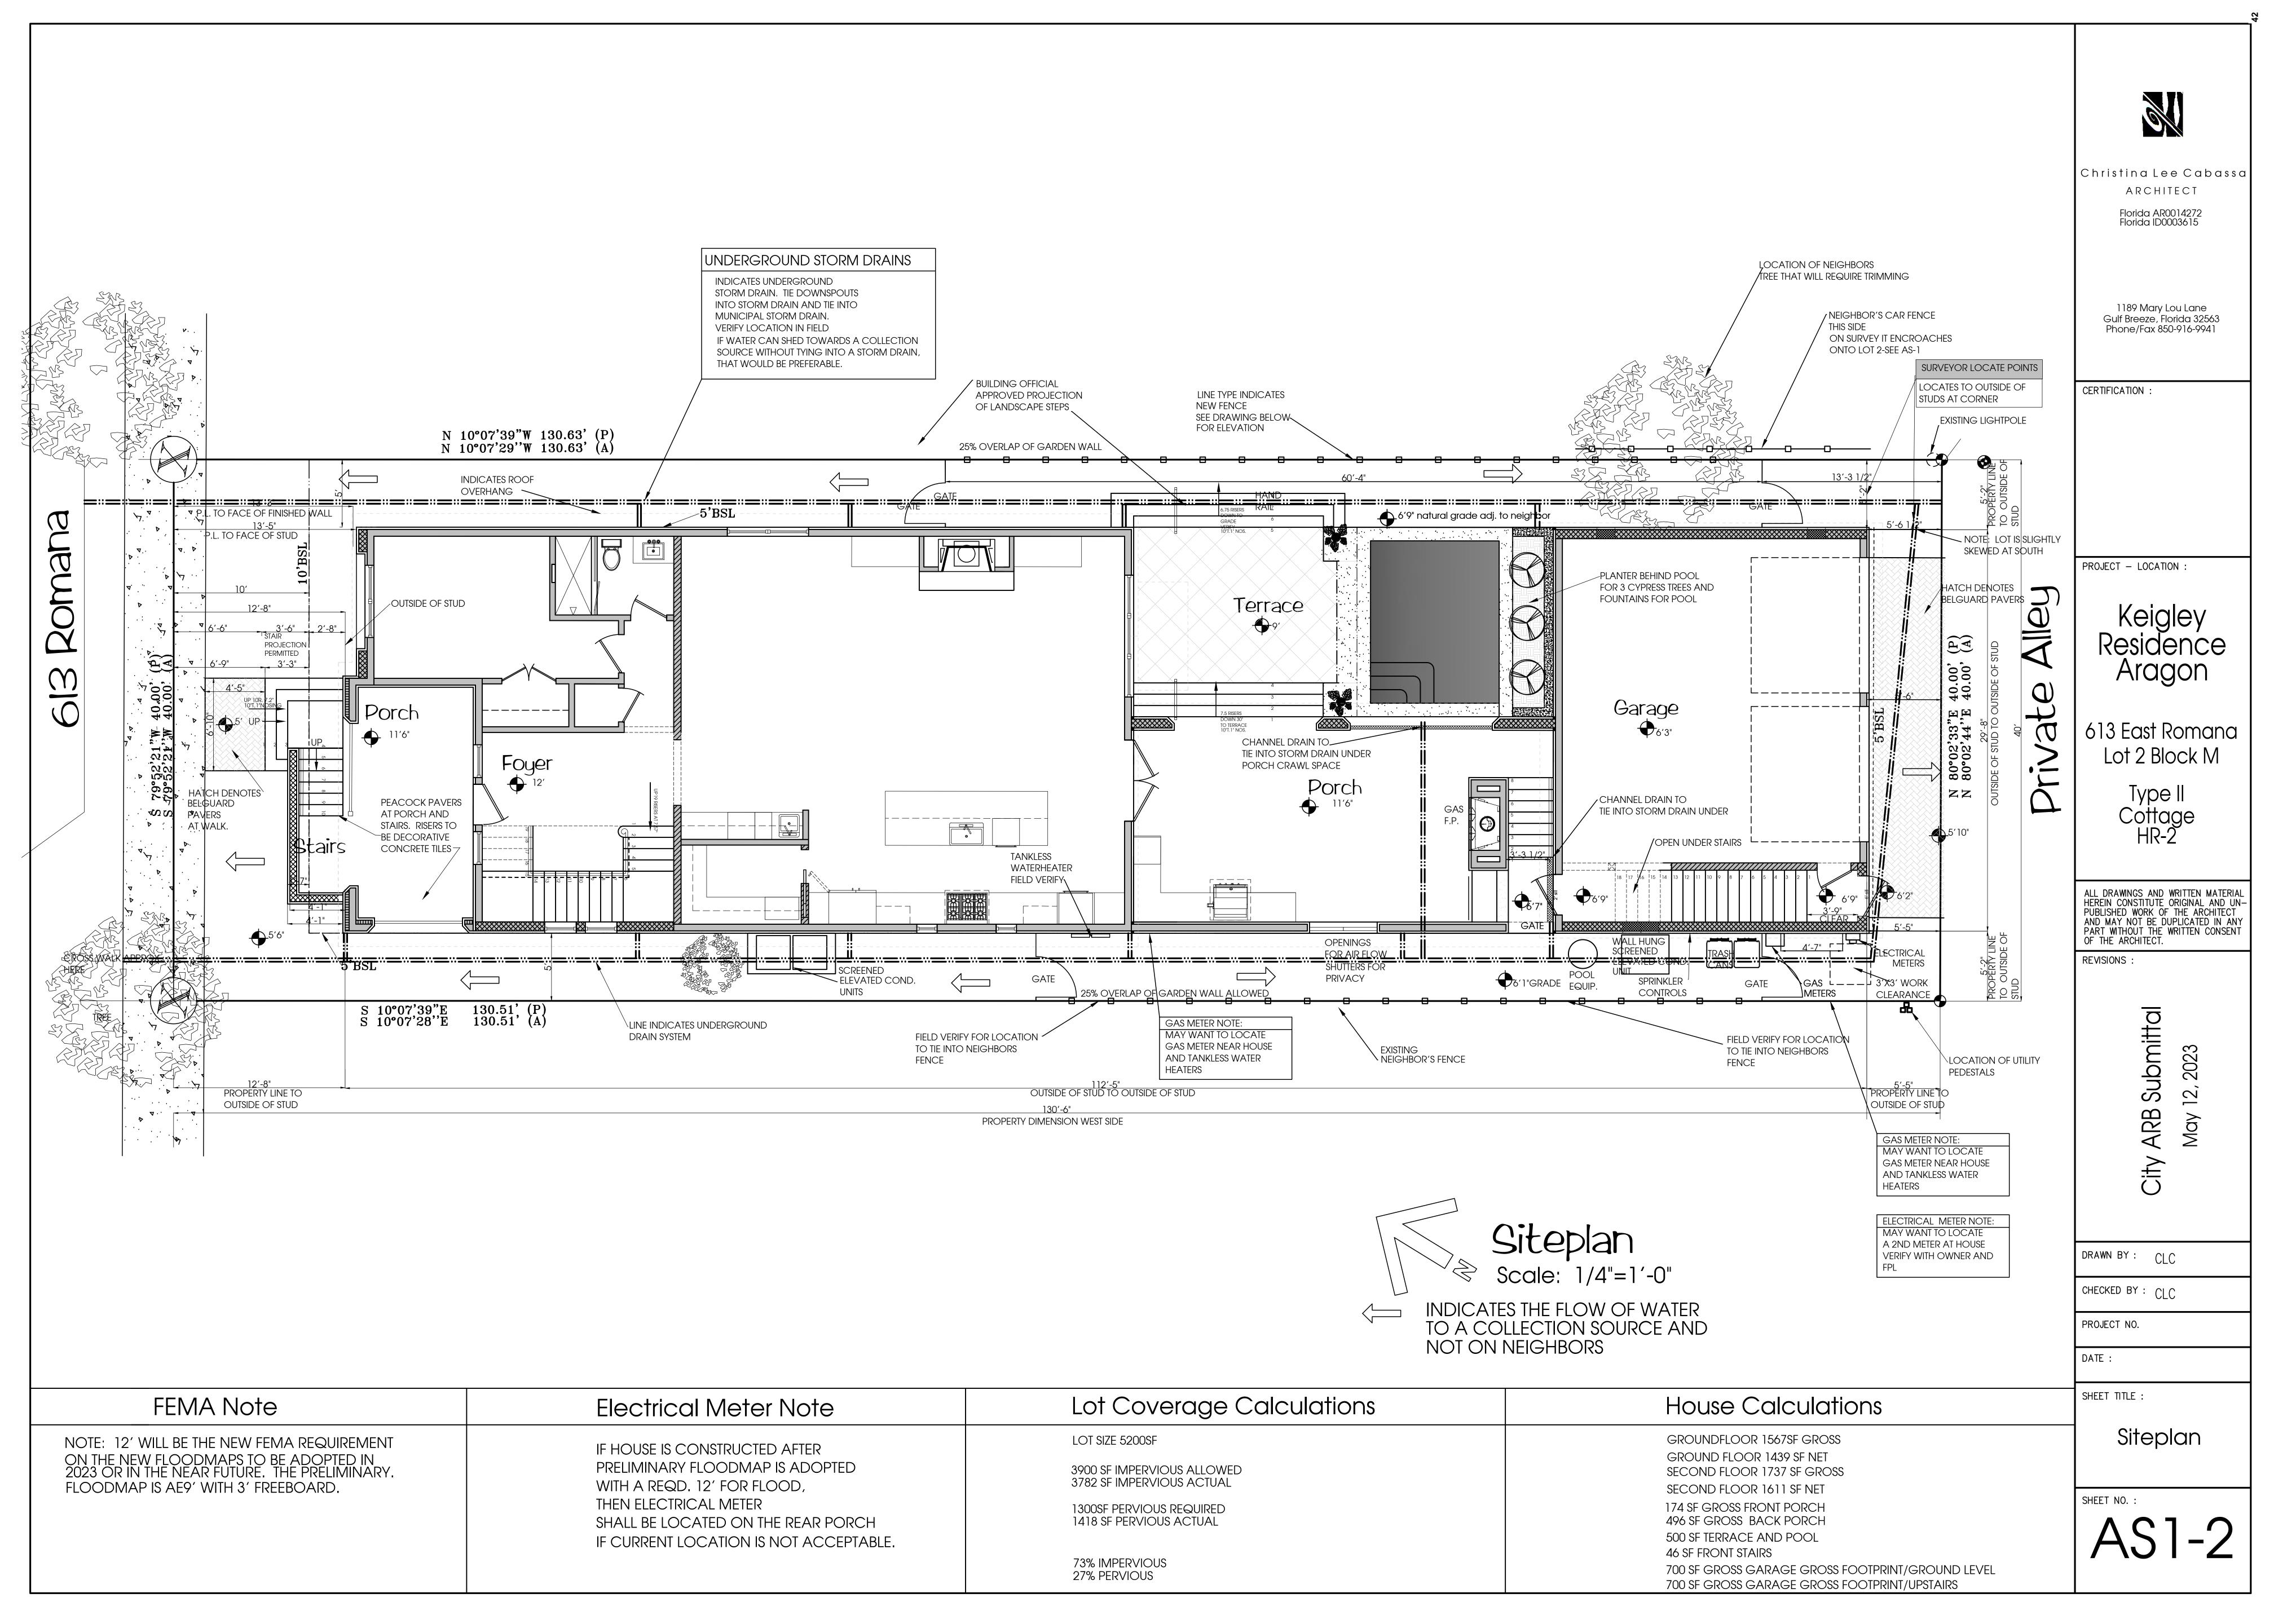

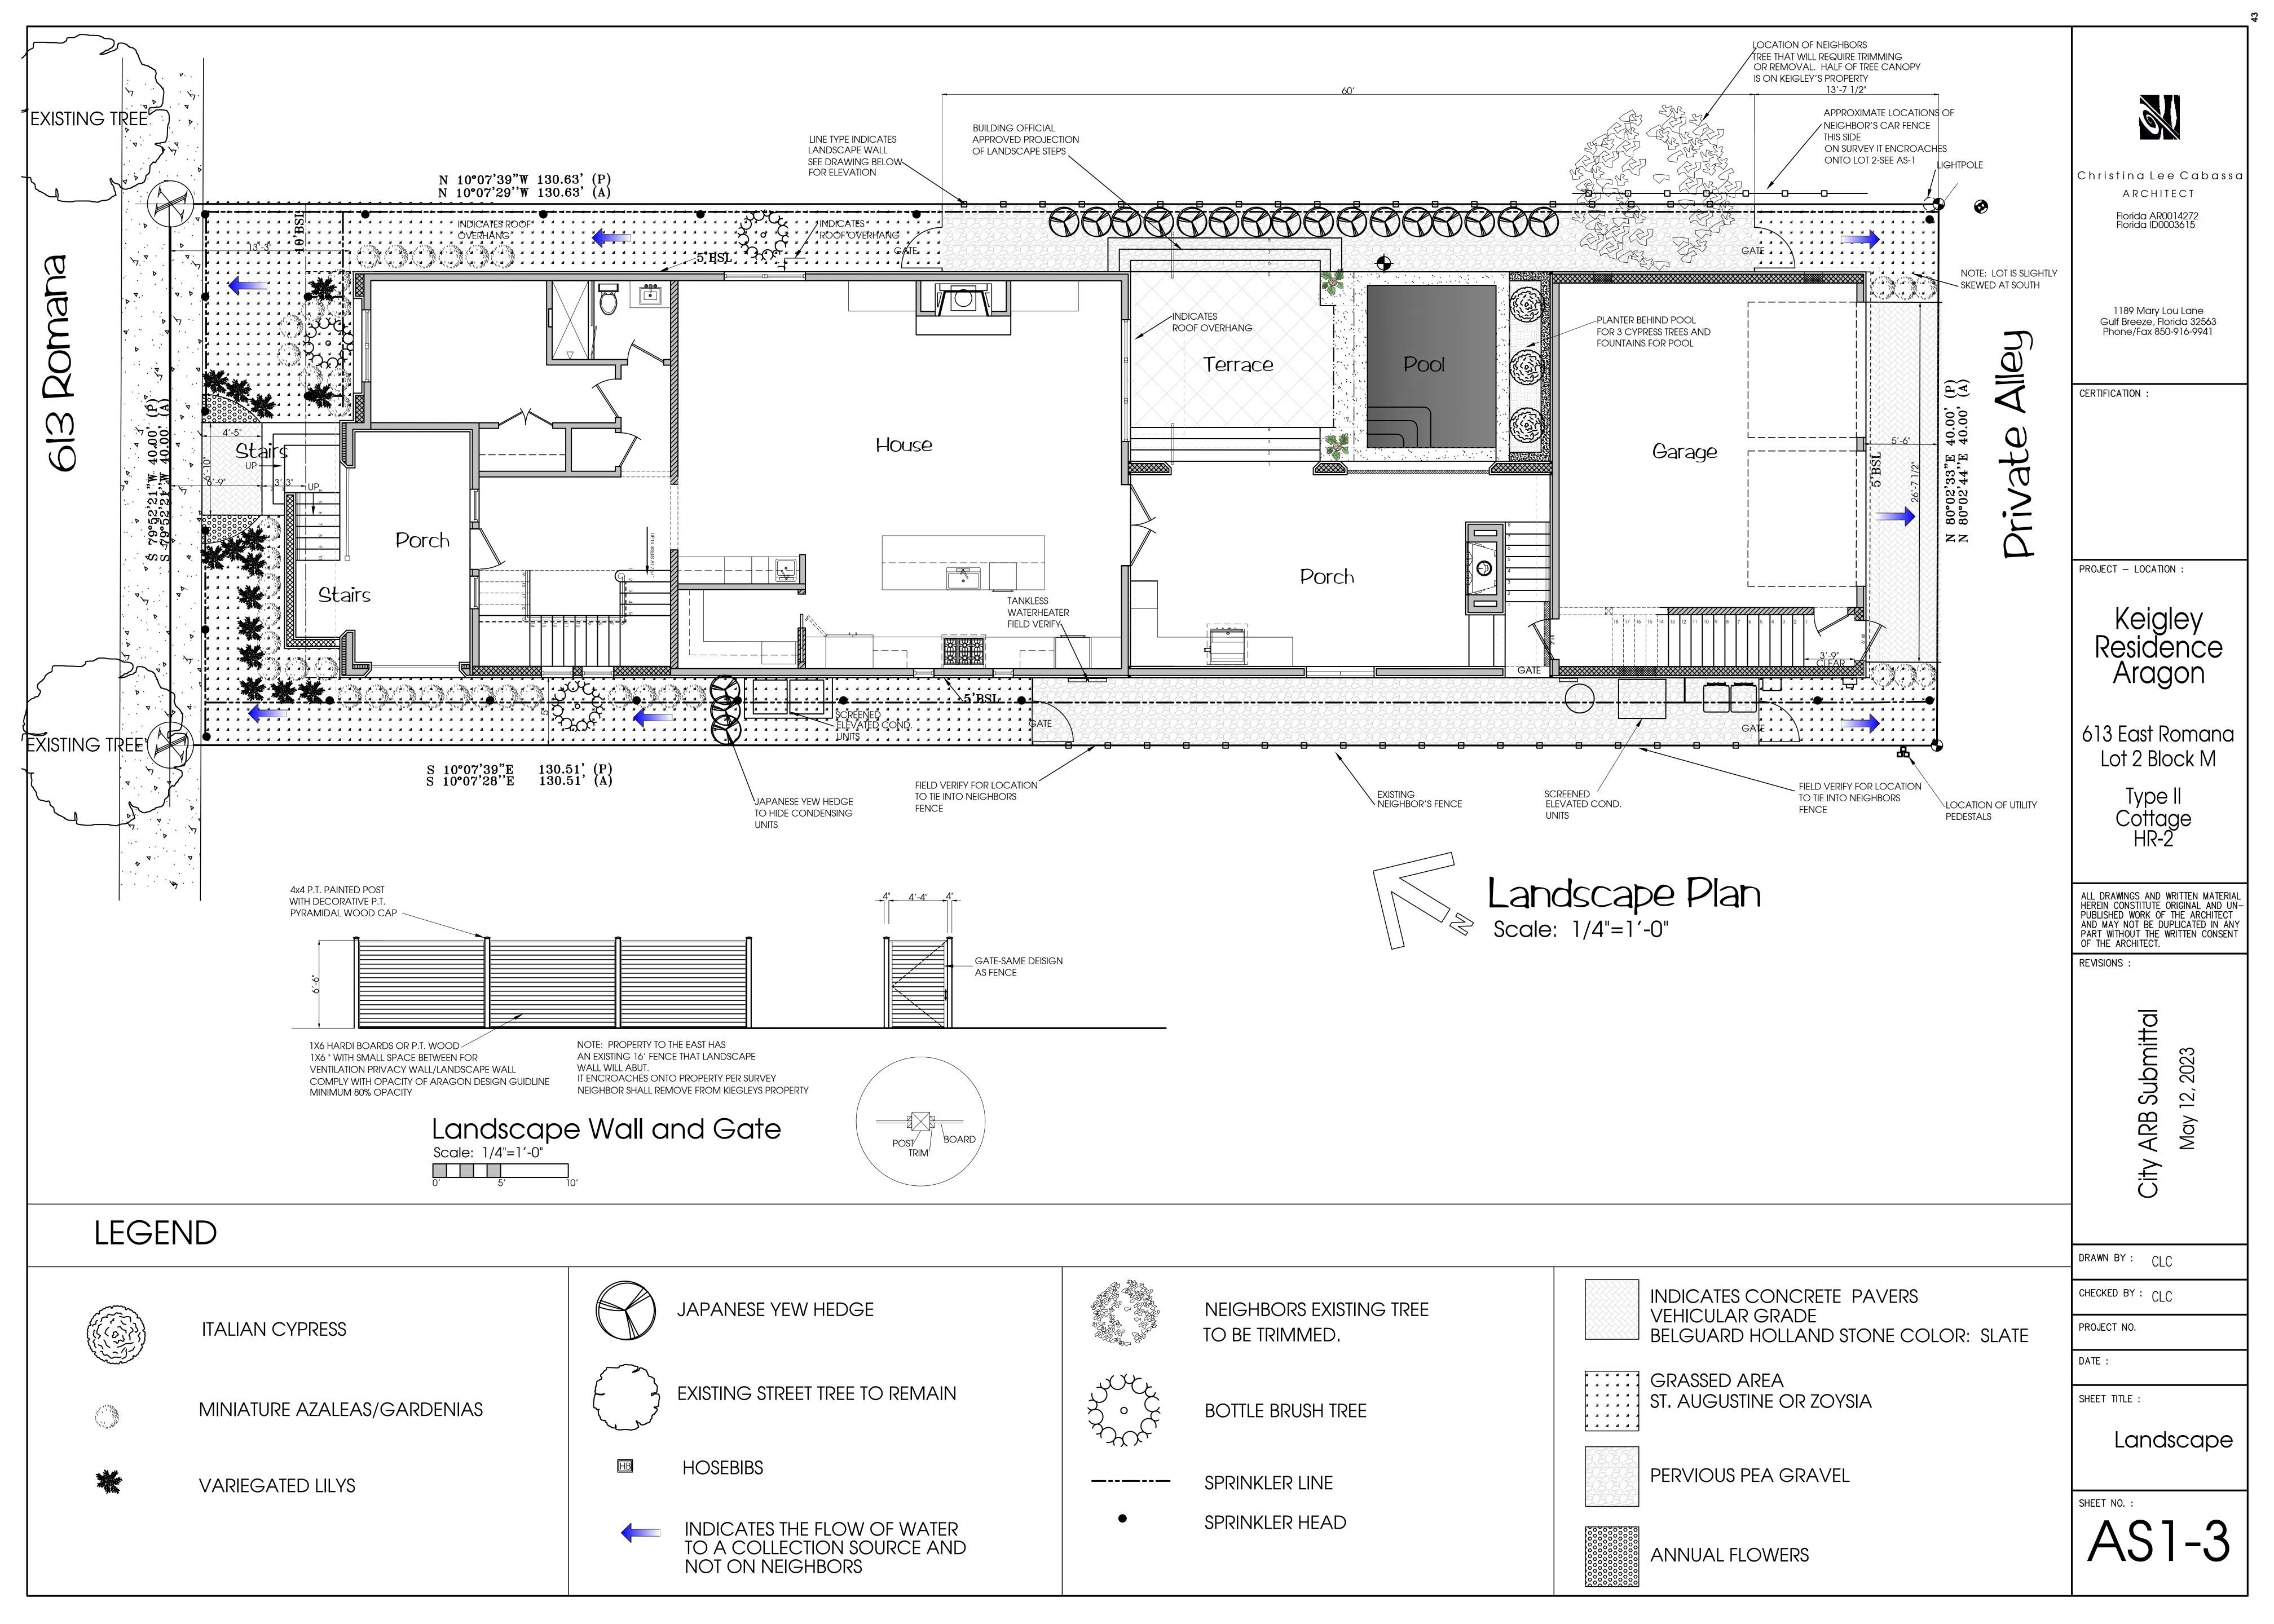

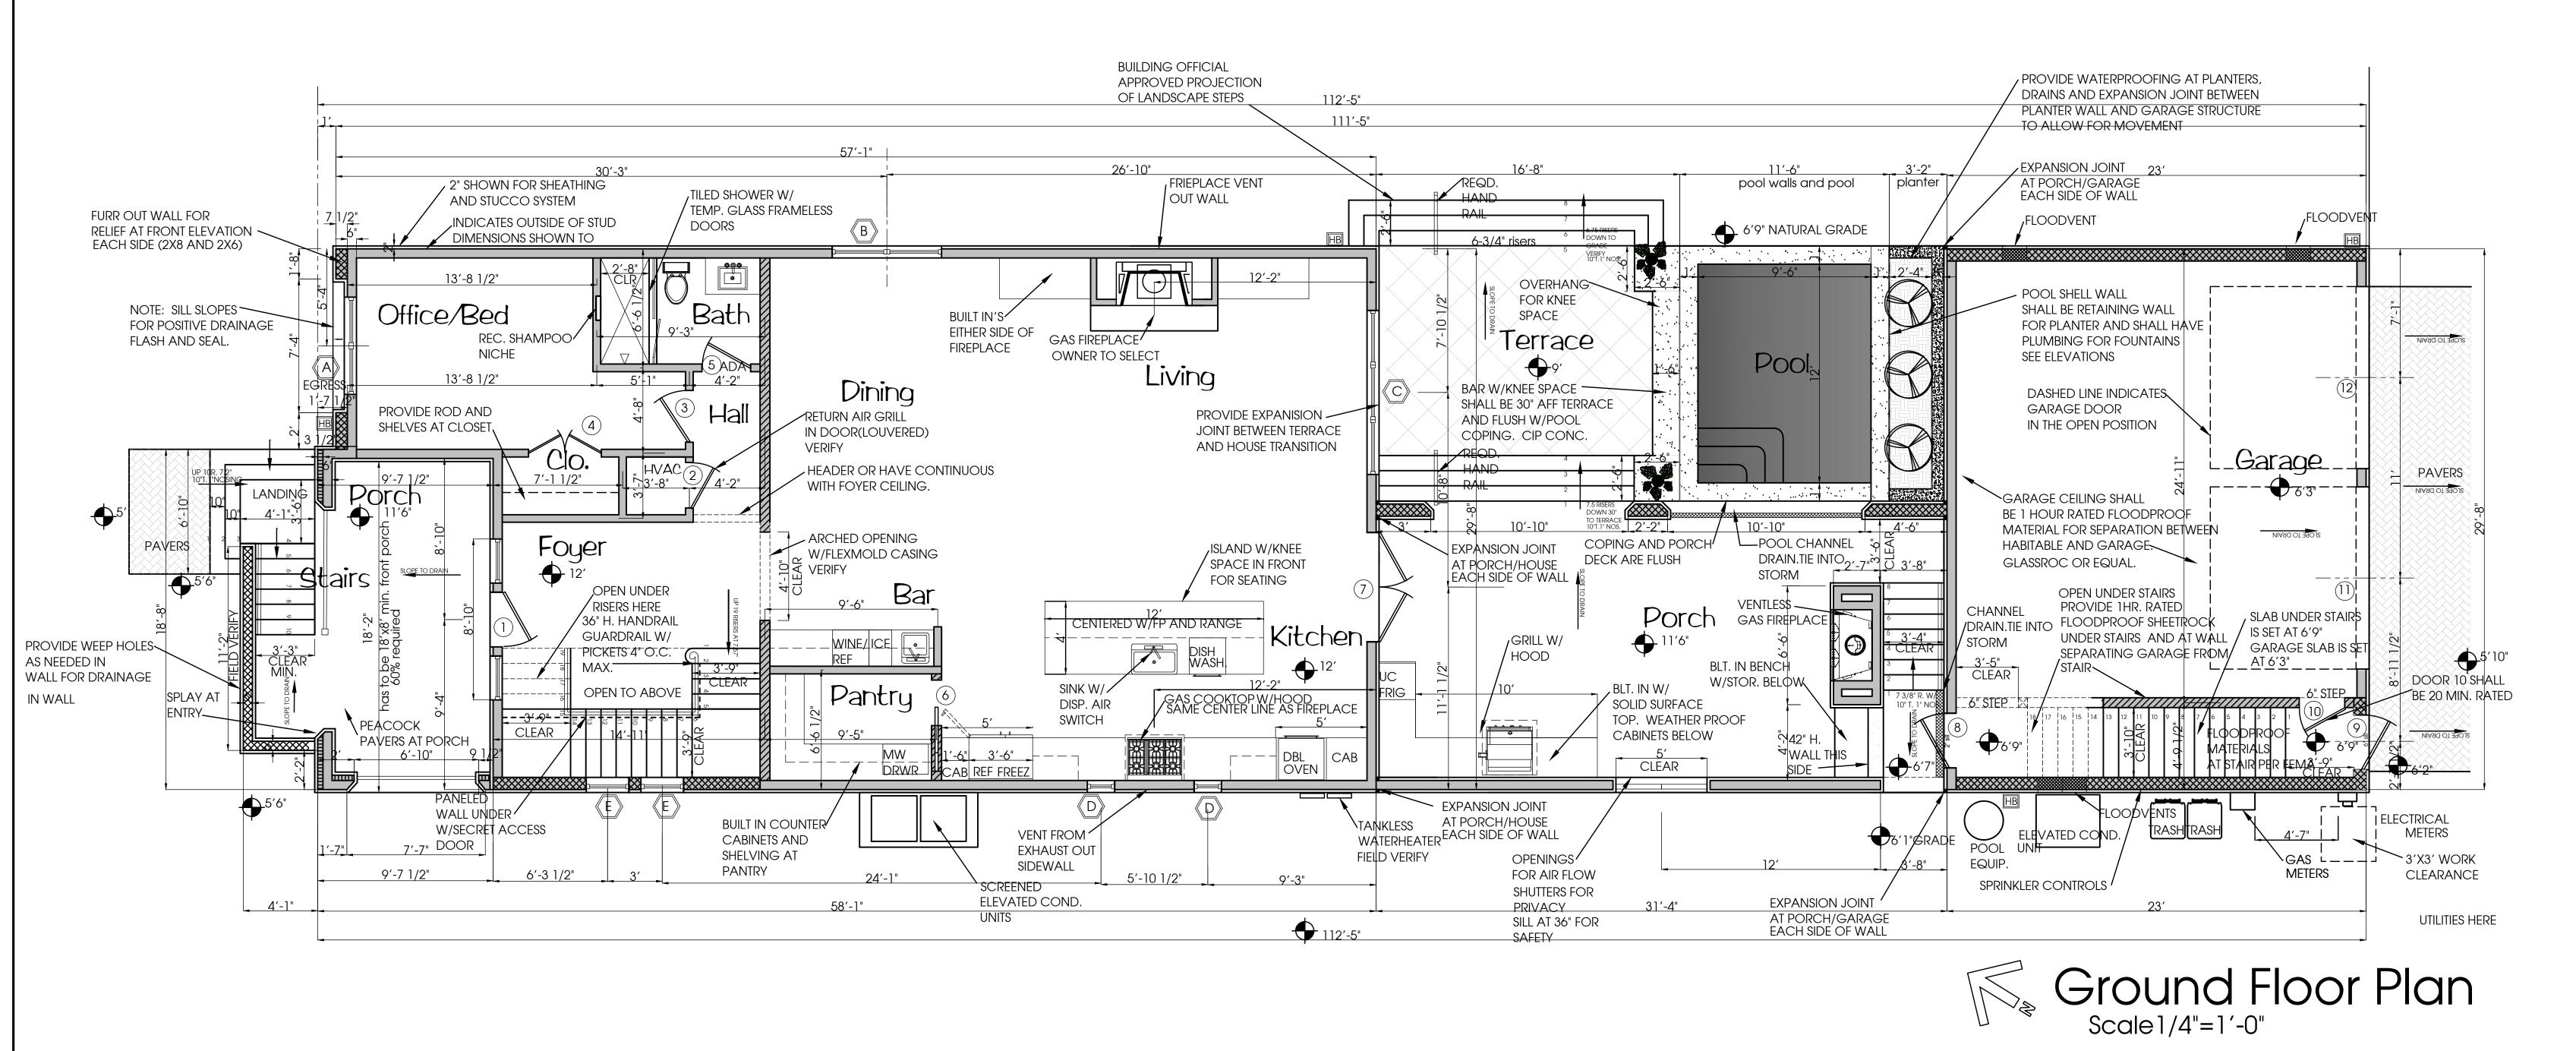

9. DOOR FROM GARAGE RATINGS

10. FLOODVENTS

11. CRAWLSPACE VENTS

1 sf of opening per 150sf of enclosed.

as they are not open for the flow of air.

Door from garage to guesthouse stairs shall be shall be 20 minute rated fiberglass.

Floodvents are required 1 square inch of vent per 1 square foot

Vents are shown on elevations. Coordinate with strucural plans.

All material in garage is required to be floodproof to comply with FEMA AE requirements.

of enclosed space. See plans for locations. Manufacturer shall be CrawlSpaceDoors.com

comply with required 1 square inch per 1 square foot of Gross Area (to include walls).

Bottom of vent shall be no greater than 12" above the finish floor elevation.

House and Porches are 2783 sf - 2783 si required for floodvents for house.

Engineered FEMA Compliant Flood Vent or Equal. Prior to construction verify size and quantity

and manufacturer to make sure block openings are sufficient and that quantity and size will

Enclosed garage space is 700 sf which includes the outer walls. 700 si required for floodvents.

At elevated foundation provide Crawl space vents to comply with Florida Residential code.

House and Porches, Terraces and pool are 2783 sf /150 sf = 19 sf required x 144si/sf = 2736 si

1 square foot of floodvents to meet the Flood requirement. Open crawl space vents may count

towards the Floodvent calculaton. Engineered Floodvents cannot count towards crawl space

An access door to all spaces enclosed is shown on west elevations. Vents shall be provided continuously at foundation walls to allow the flow of air. In addition in these areas there shall be 1 square inch per

*FEMA requirements for flood are greated than the crawlspace. Therefore use 2783 si for venting required.

FLOOR PLAN NOTES

LOCATE SWITCHES AND OUTLETS SO THEY CLEAR CASING.

ARCHITECT. 6" WALLS ARE SHOWN FOR POCKET DOORS.

SHALL IMMEDIATELY NOTIFY OWNER AND ARCHITECT FOR RESOLUTION.

PROVIDE BLOCKING AS REQURIED FOR ALL TOWEL BARS, SHELVING, TV MOUNTS,

DOORS HAVE BEEN LOCATED TO ALLOW FOR CASING AND PAINTED SHEETROCK

PROVIDE AN ADEQUATE ALLOWANCE FOR SELECTION OF TOILET PAPER HOLDERS,

PROVIDE AN ADEQUATE ALLOWANCE FOR SELECTION OF WOOD SHELVING AND METAL

VERIFY POCKET DOOR LOCATIONS AND REQUIRED FRAMING. IF CONFLICTS, CONSULT OWNER\

VERIFY WITH OWNER IF ROUND STANDARD DRAIN OR LINEAR DRAINS ARE REQUIRED AT SHOWERS

Garage ceiling shall be 1 hour Type X Floodproof Material. 5/8" Certainteed GlassRoc or equal.

Wall between house and garage shall also be 1 hour rated Type X floodproof material-5/8"

WHEN THERE IS A CONFLICT IN THE FIELD WITH THE DRAWINGS, CONTRACTOR AND/OR SUB

DOOR CASING DIMENSIONS

TOWEL HOLDERS AND HOOKS.

Provide quality doors and hardware.

BARN DOOR SLIDING DOORS, ETC.

8. GARAGE SEPARATION REQUIREMENTS:

Certainteed GlassRoc or Equal.

2. ACCESSORIES


3. SHELVING AND RODS

RODS IN CLOSETS.

4. POCKET DOOR FRAMING

5. CONFLICTS IN THE FIELD

6. BLOCKING

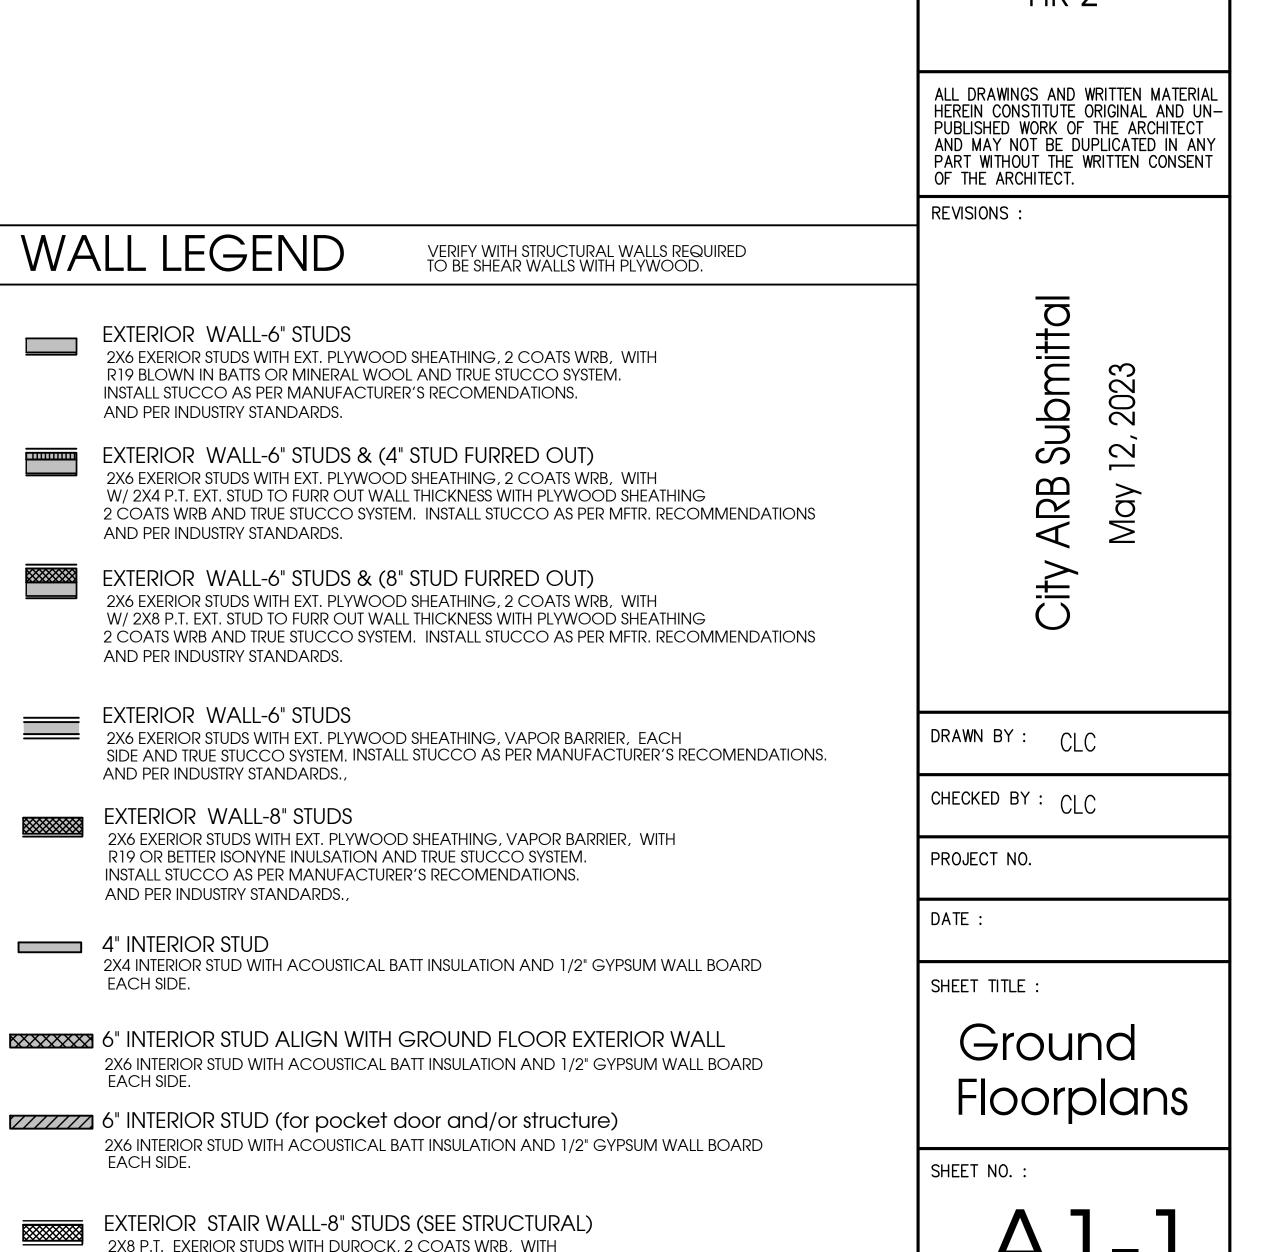

WALL LEGEND

EXTERIOR WALL-6" STUDS

AND PER INDUSTRY STANDARDS.

AND PER INDUSTRY STANDARDS.

AND PER INDUSTRY STANDARDS.

EXTERIOR WALL-6" STUDS

AND PER INDUSTRY STANDARDS.

EXTERIOR WALL-8" STUDS

AND PER INDUSTRY STANDARDS.

4" INTERIOR STUD

TRUE STUCCO SYSTEM.

AND PER INDUSTRY STANDARDS.,

INSTALL STUCCO AS PER MANUFACTURER'S RECOMENDATIONS.

HOUSE CALCULATIONS

GROUNDFLOOR 1567SF GROSS GROUND FLOOR 1439 SF NET

SECOND FLOOR 1737 SF GROSS SECOND FLOOR 1611 SF NET

174 SF GROSS FRONT PORCH

496 SF GROSS BACK PORCH

500 SF TERRACE AND POOL

LEGEND

700 SF GROSS GARAGE GROSS FOOTPRINT/GROUND LEVEL

700 SF GROSS GARAGE GROSS FOOTPRINT/UPSTAIRS

(X) DOOR IDENTIFICATION

X WINDOW IDENTIFICATION

HB HOSEBIB LOCATION

46 SF FRONT STAIRS

Christina Lee Cabassa

ARCHITECT

Florida AR0014272

Florida ID0003615

1189 Mary Lou Lane

Gulf Breeze, Florida 32563

Phone/Fax 850-916-9941

CERTIFICATION

PROJECT - LOCATION


Aradon

613 East Romana

Lot 2 Block M

Type II

Cottage

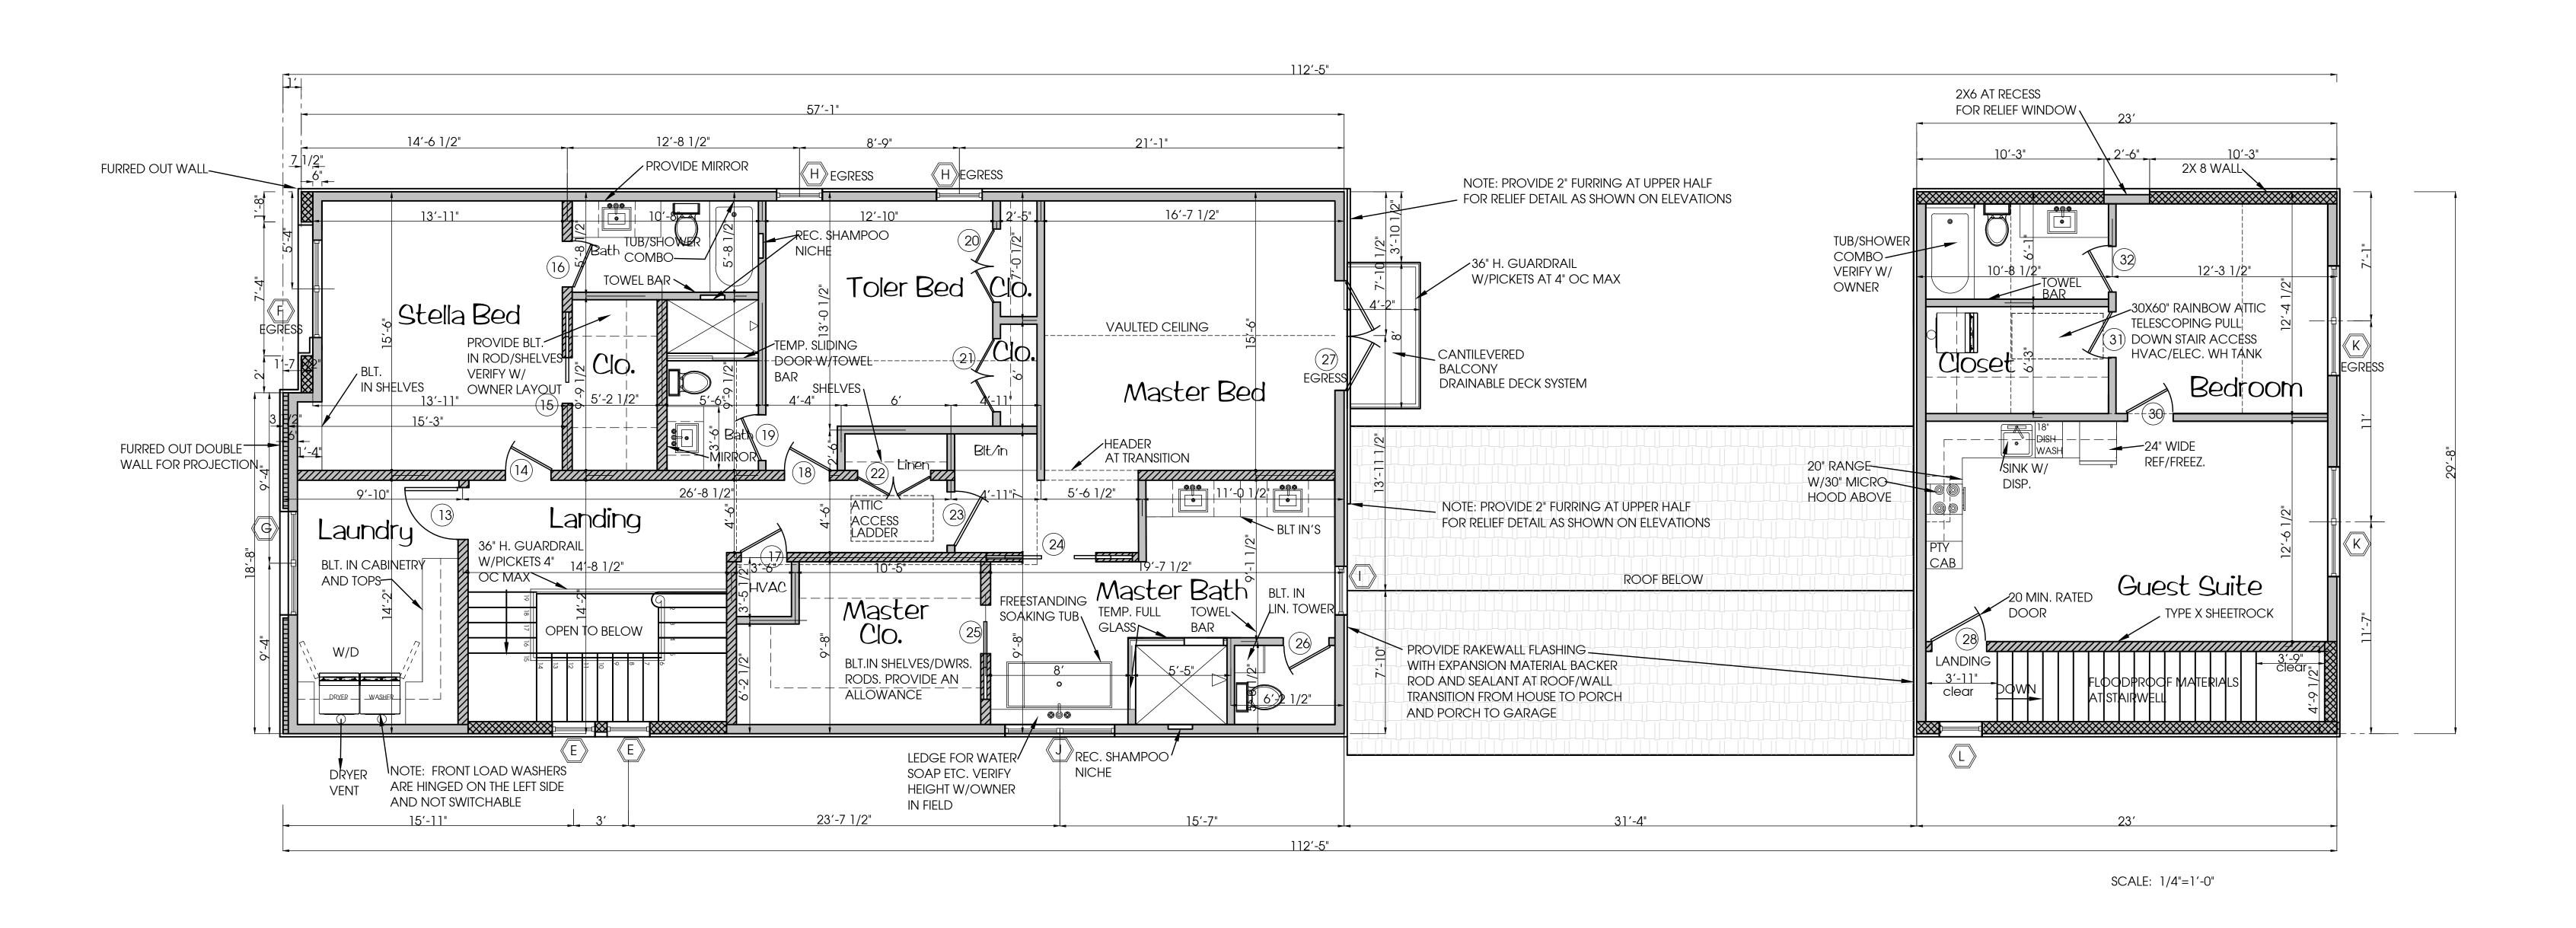




2X8 P.T. EXERIOR STUDS WITH DUROCK, 2 COATS WRB, WITH

INSTALL STUCCO AS PER MANUFACTURER'S RECOMENDATIONS.

TRUE STUCCO SYSTEM.

AND PER INDUSTRY STANDARDS.,

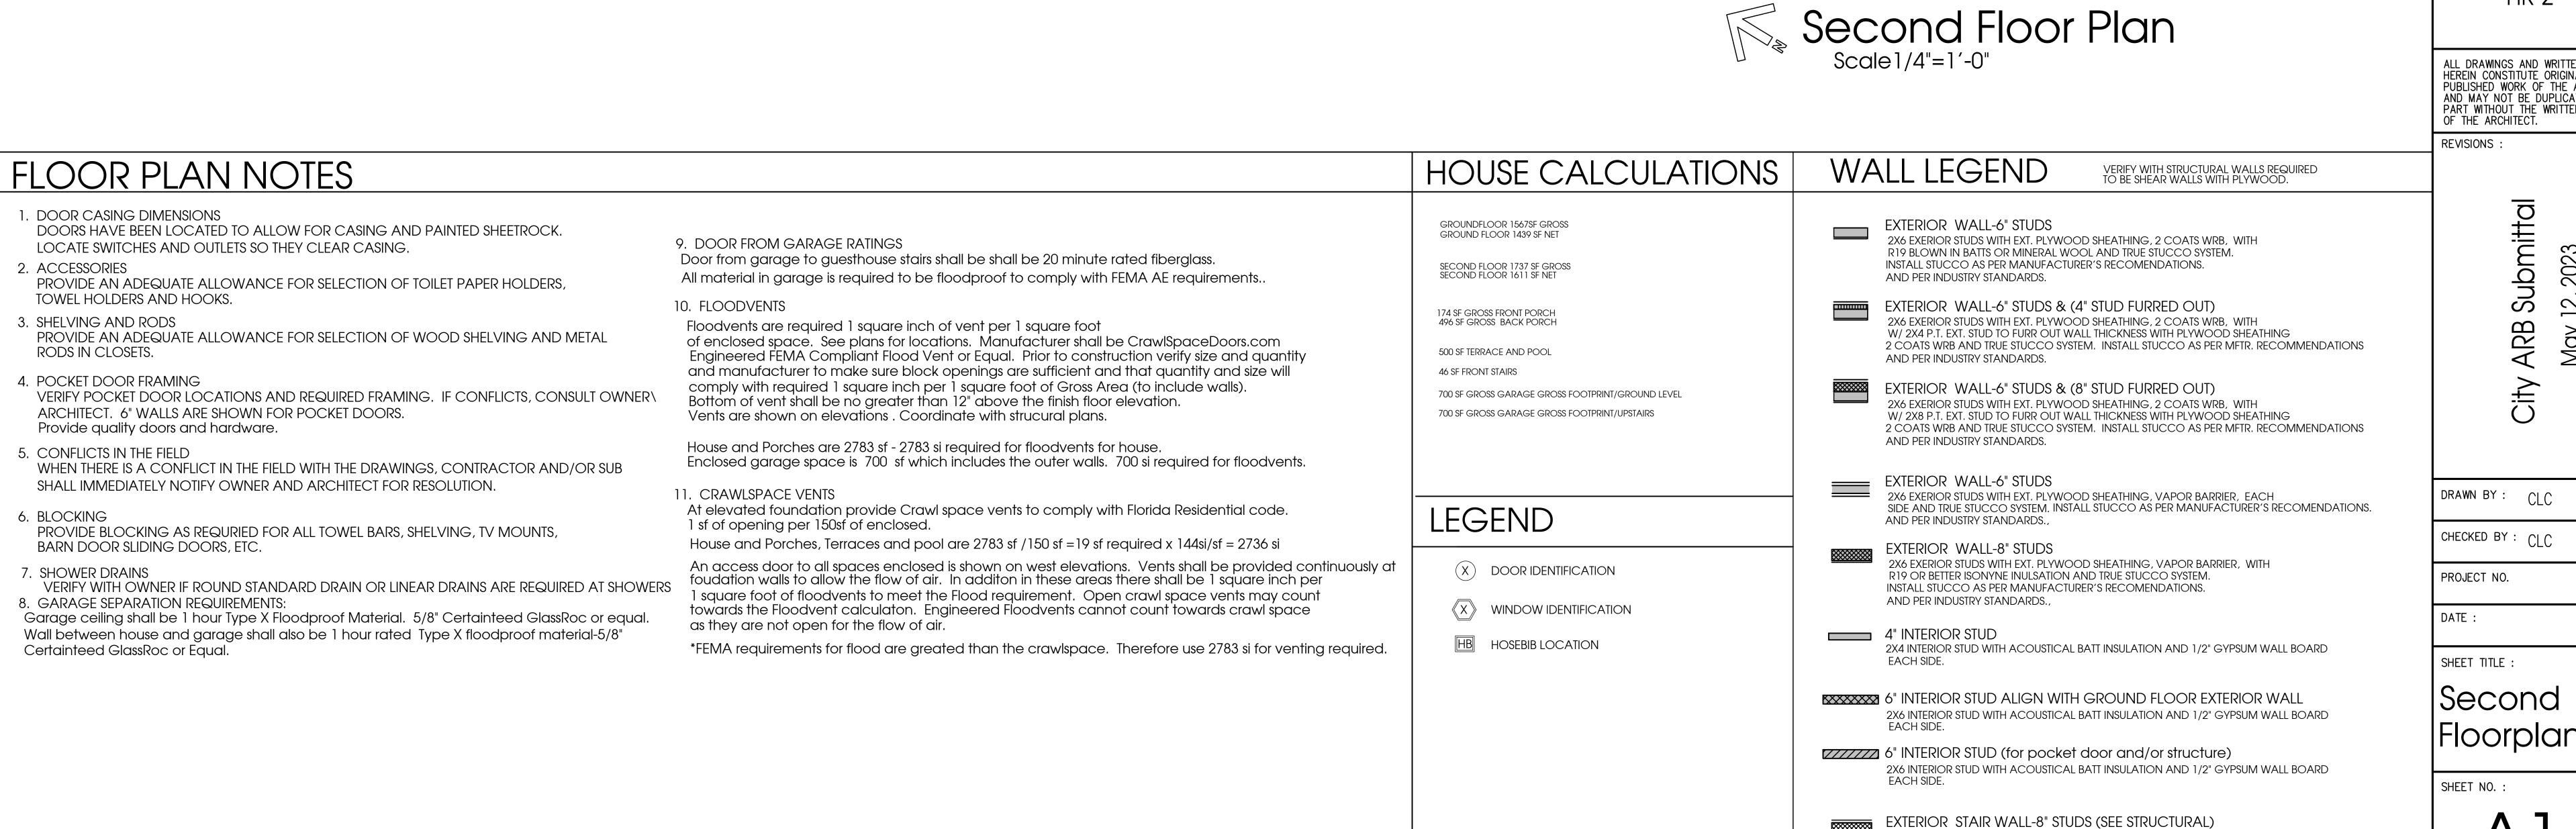

Christina Lee Cabassa ARCHITECT

Florida AR0014272 Florida ID0003615

1189 Mary Lou Lane Gulf Breeze, Florida 32563 Phone/Fax 850-916-9941

CERTIFICATION :

PROJECT - LOCATION


613 East Romana Lot 2 Block M

> Type II Cottage

ALL DRAWINGS AND WRITTEN MATERIAL HEREIN CONSTITUTE ORIGINAL AND UN-PUBLISHED WORK OF THE ARCHITECT AND MAY NOT BE DUPLICATED IN ANY PART WITHOUT THE WRITTEN CONSENT OF THE ARCHITECT.

 $\vec{\sim}$ May

Floorplans

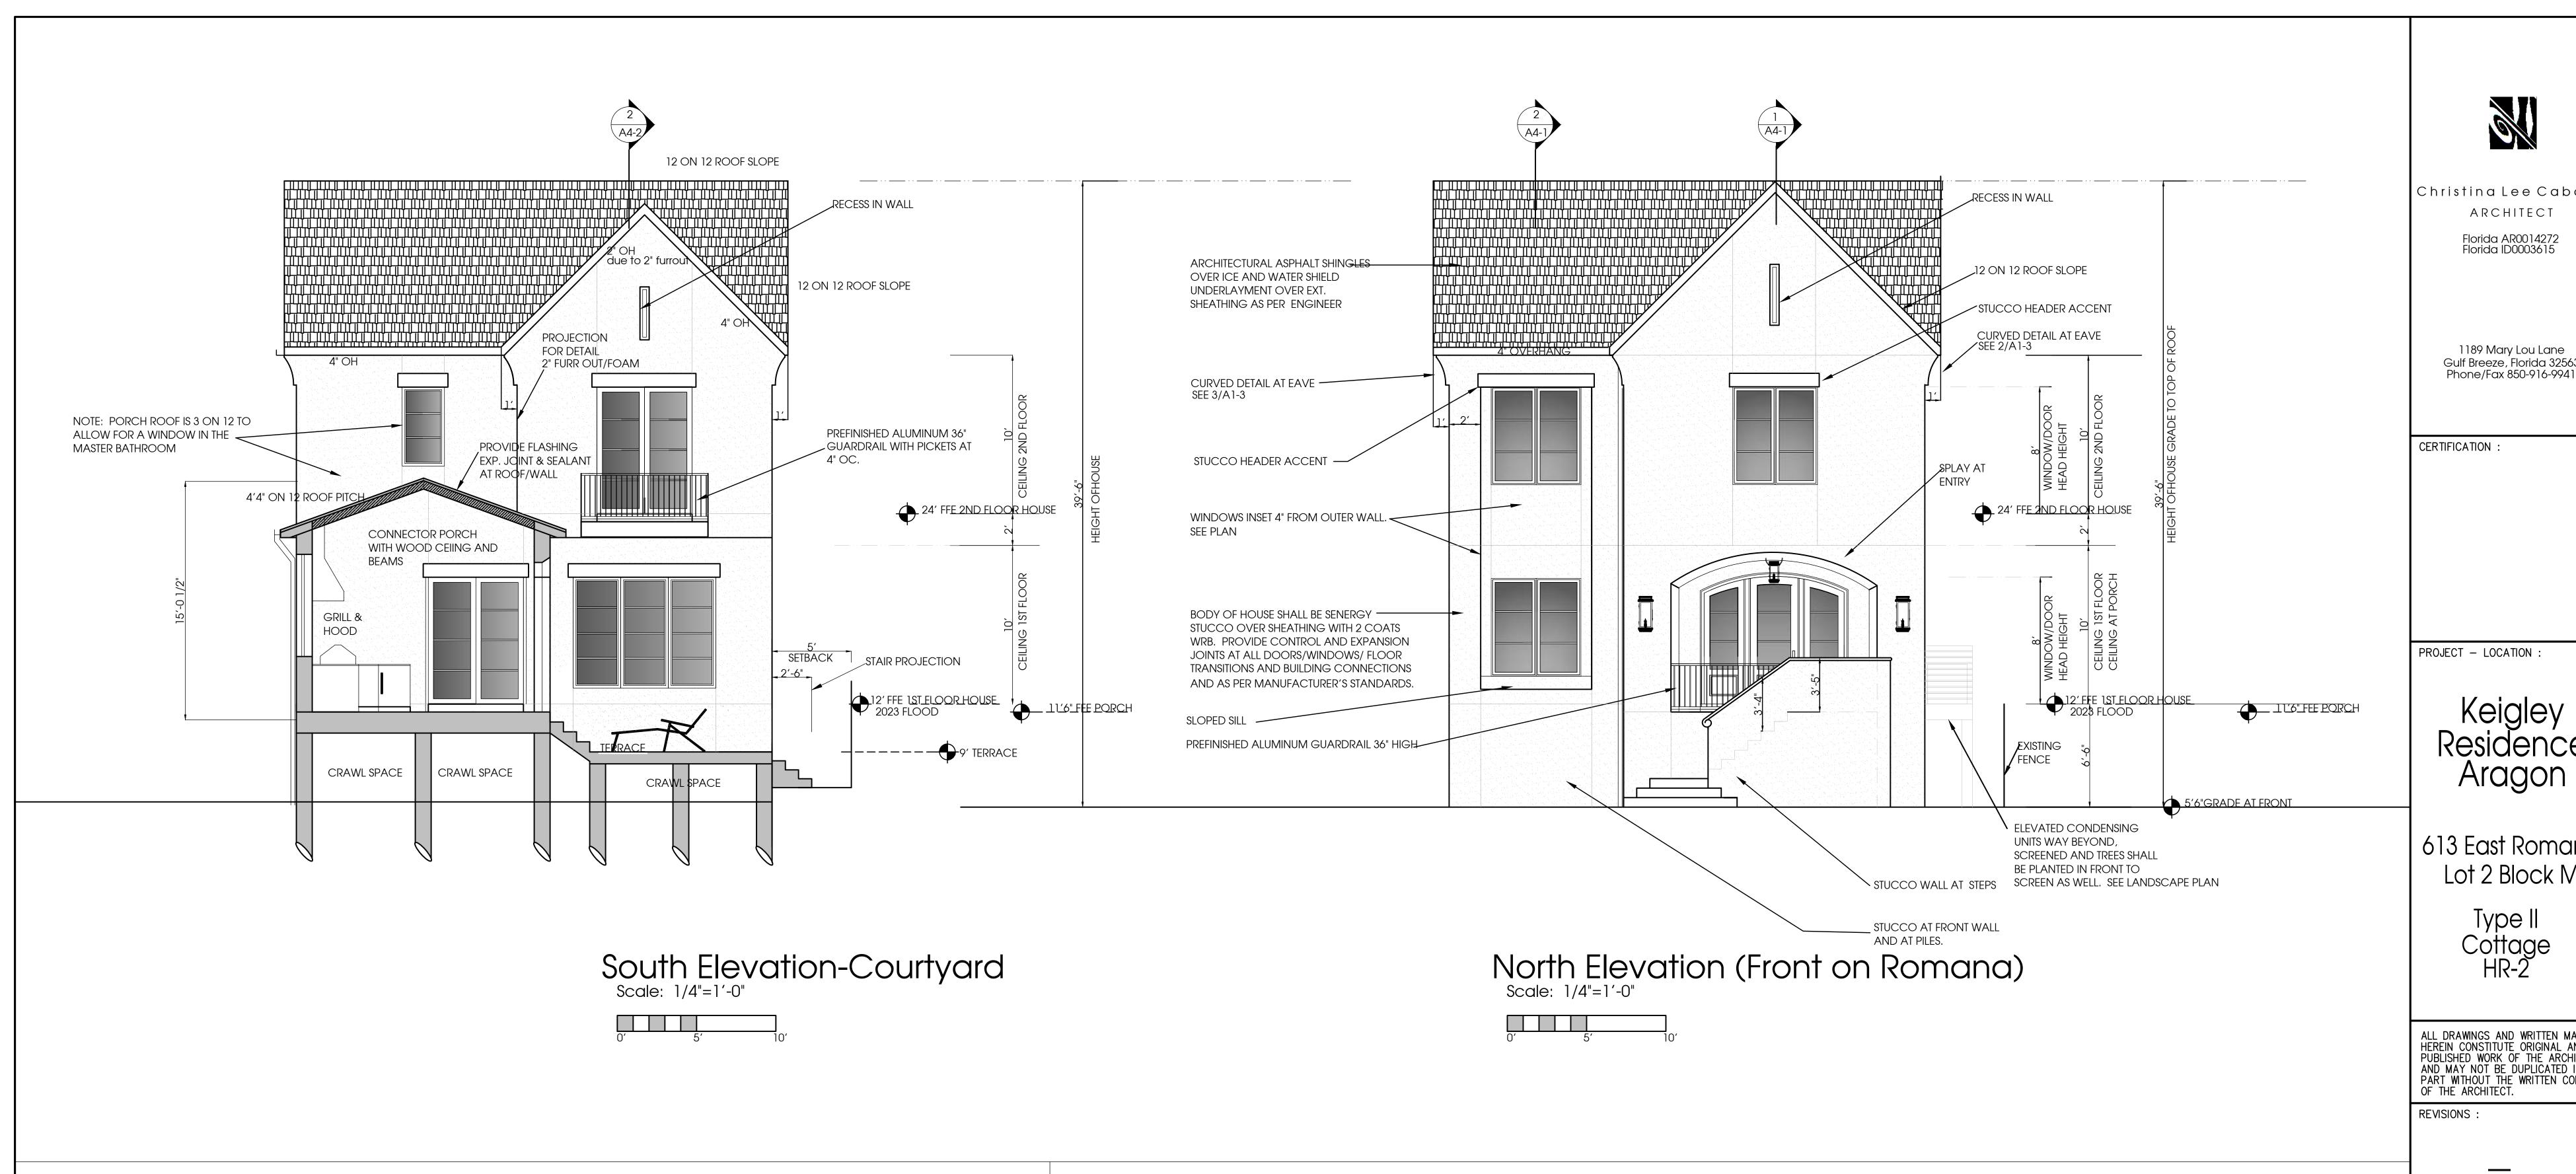

GENERAL NOTES FOR ELEVATIONS

- PROVIDE EXPANSION JOINTS AT ALL FLOOR CHANGES, DISSIMILAR MATERIALS, MOVEMENT JOINTS, SUBSTRATE CHANGES.
- PROVIDE CONTROL JOINTS WHERE AREA IS 144SF MAX. MAXIMUM LENGTH IS 18'.
- PROVIDE SEALANT AT ALL WINDOWS, DOORS, LIGHTS, ELECTRICAL OUTLETS, HOSEBIBS, DRYER VENTS, ETC. ALL PENETRATIONS.
- BACKER ROD AND SEALANT AND FLASHING REQUIRED AT ALL DOOR AND WINDOW OPENINGS.
- INSTALL STUCCO SYSTEM AS PER MANUFACTURER'S INSTRUCTIONS AND SPECIFICATIONS AND AS PER INDUSTRY STANDARDS. PROVIDE EXPANSION JOINT BETWEEN REAR PORCH/HOUSE AND REAR PORCH GARAGE GUEST HOUSE, AT ALL RETAINING AND POOL WALLS NEAR THE HOUSE, DECKS, TO PROVIDE FLEX FOR MOVEMENT BETWEEN DIFFERENT STRUCTURES.

EXTERIOR PROPOSED MATERIALS

EXTERIOR BODY: SENERGY STUCCO COLOR: SW SNOWBOUND 7004

EXTERIOR HEADER TRIM: SENERGY STUCCO COLOR: SW TOUCH OF GREY 9549

WINDOWS: WINDSOR PINNACLE METAL WOOD CLAD W/ SIMULATED TRUE DIVIDED LITE COLOR: BLACK/IMPACT GLASS

FRONT DOOR: STAINED WOOD WITH IMPACT GLASS SPECIES & STAIN COLOR: WHITE OAK/LIGHT STAIN

GARAGE DOORS: MFTR: HAAS INSULATED STEEL 2000 SERIES STYLE: 8 PANELS COLOR: SW TOUCH OF GREY 9549

CRAWL SPACE: VENTED PAINTED 2X HARDI BOARDS HORIZONTAL AS "LATTICE" COLOR: SW TOUCH OF GREY 9549

RAILING: PREFINISHED ALUMINUM COLOR: BLACK

ROOF: ARCHITECTURAL ASPHALT SHINGLES MFTR: ATLAS PINNACLE IMPACT COLOR: PEWTER

SOFFITS: SENERGY STUCCO FOR SOFFIT COLOR: SW SNOWBOUND 7004

FASCIA/FLASHING/DRIP: PREFINISHED ALUMINUM COLOR: WHITE

GUTTER AND DOWNSPOUTS: PREFINISHED ALUMINUM COLOR: WHITE

PORCH SHUTTERS: PREFINISHED ALUMINUM OR PAINTED PVC COLOR: SW WILLIAMS TOUCH OF GREY 9549

PORCH CEIINGS: STAINED WOOD (OR SENERGY WOOD PRODUCT) SPECIES: WHITE OAK COLOR: WHITE WASHED STAIN

EXTERIOR DRIVE AND SIDEWALK: PAVERS MANUFACTURER/STYLE BELGUARD HOLLAND PAVER COLOR: SLATE

TERRACE AND PORCH: MANUFACTURER/STYLE: PEACOCK PAVERS

COLOR: RICE WHITE

FENCE AND LANDSCAPE WALL: HARDIBOARD OR P.T. 2X PAINTED COLOR: SW TOUCH OF GRAY 9549

EXTERIOR LIGHTING: ST. JAMES WINNIPEG COPPER OUTDOOR LIGHTING AND CHANDELIER: COLOR: DARK BRONZE

Christina Lee Cabassa ARCHITECT

> 1189 Mary Lou Lane Gulf Breeze, Florida 32563

PROJECT - LOCATION

Aragon

613 East Romana Lot 2 Block M

> Type II Cottage HR-2

ALL DRAWINGS AND WRITTEN MATERIAL HEREIN CONSTITUTE ORIGINAL AND UN-PUBLISHED WORK OF THE ARCHITECT AND MAY NOT BE DUPLICATED IN ANY PART WITHOUT THE WRITTEN CONSENT OF THE ARCHITECT.

12,

DRAWN BY: CLC

CHECKED BY: CLC


PROJECT NO.

SHEET TITLE :

Elevations

SHEET NO.:

A2-1

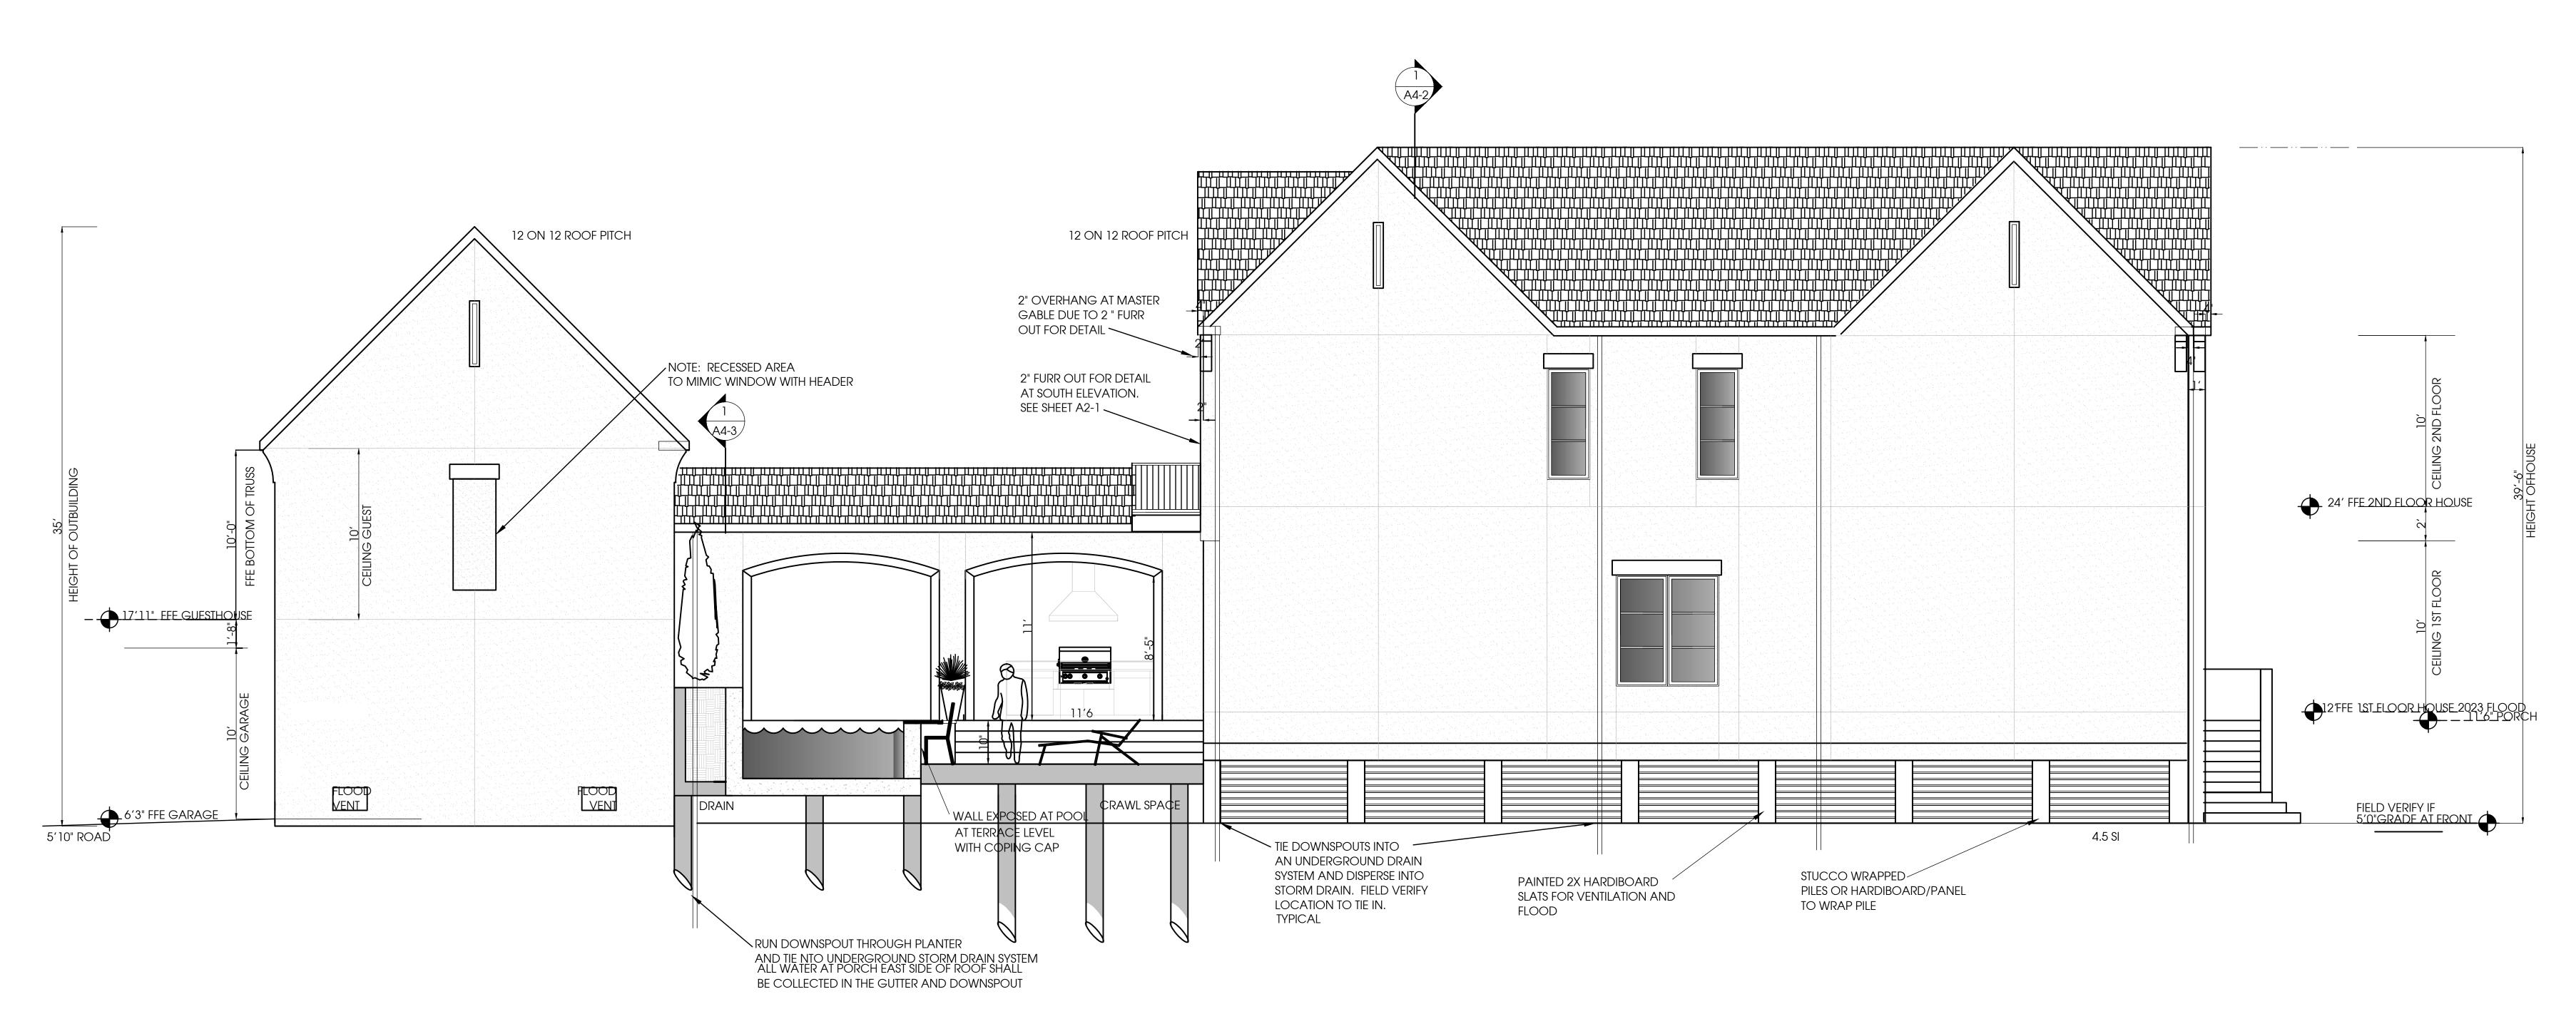

East Elevation
Scale: 1/4"=1'-0"

Christina Lee Cabassa ARCHITECT

> Florida AR0014272 Florida ID0003615

1189 Mary Lou Lane Gulf Breeze, Florida 32563 Phone/Fax 850-916-9941

CERTIFICATION:

PROJECT - LOCATION :

Keigley Residence Aragon

613 East Romana Lot 2 Block M

> Type II Cottage HR-2

ALL DRAWINGS AND WRITTEN MATERIAL HEREIN CONSTITUTE ORIGINAL AND UN-PUBLISHED WORK OF THE ARCHITECT AND MAY NOT BE DUPLICATED IN ANY PART WITHOUT THE WRITTEN CONSENT OF THE ARCHITECT.

REVISIONS :

City ARB Submittal
May 12, 2023

DRAWN BY: CLC

CHECKED BY: CLC


PROJECT NO.


SHEET TITLE :

Elevations

SHEET NO. :

A2-2

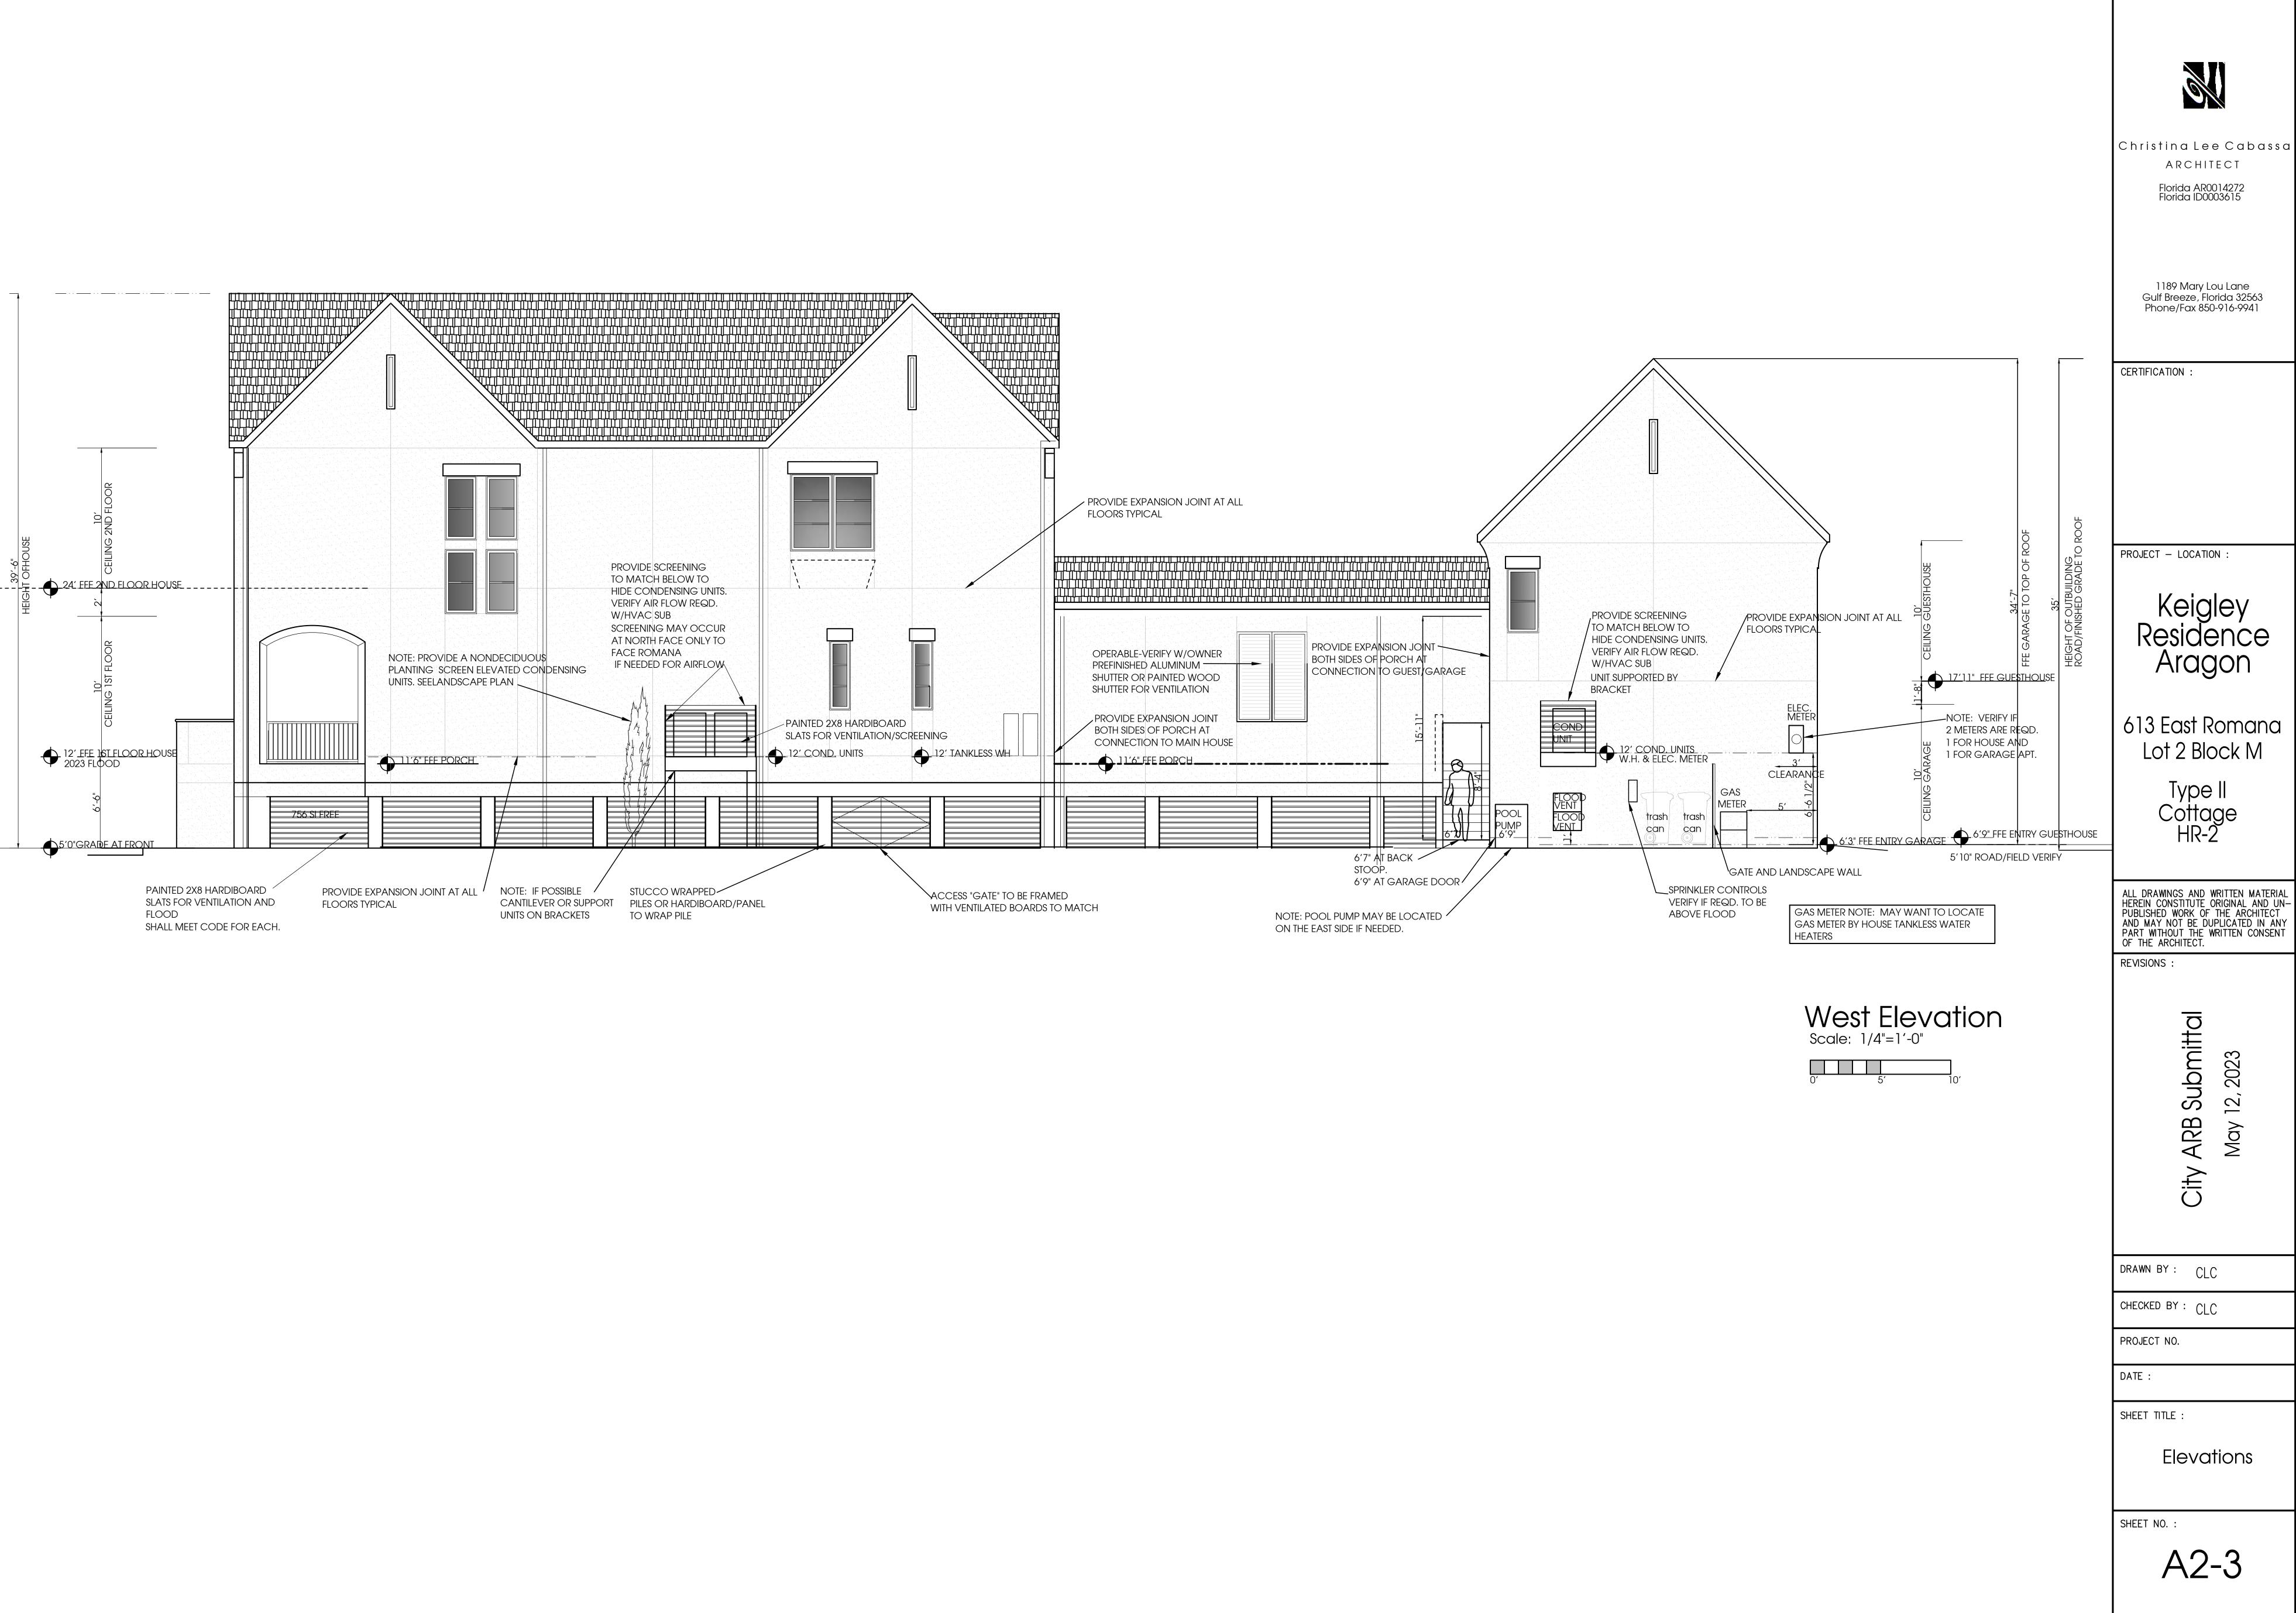


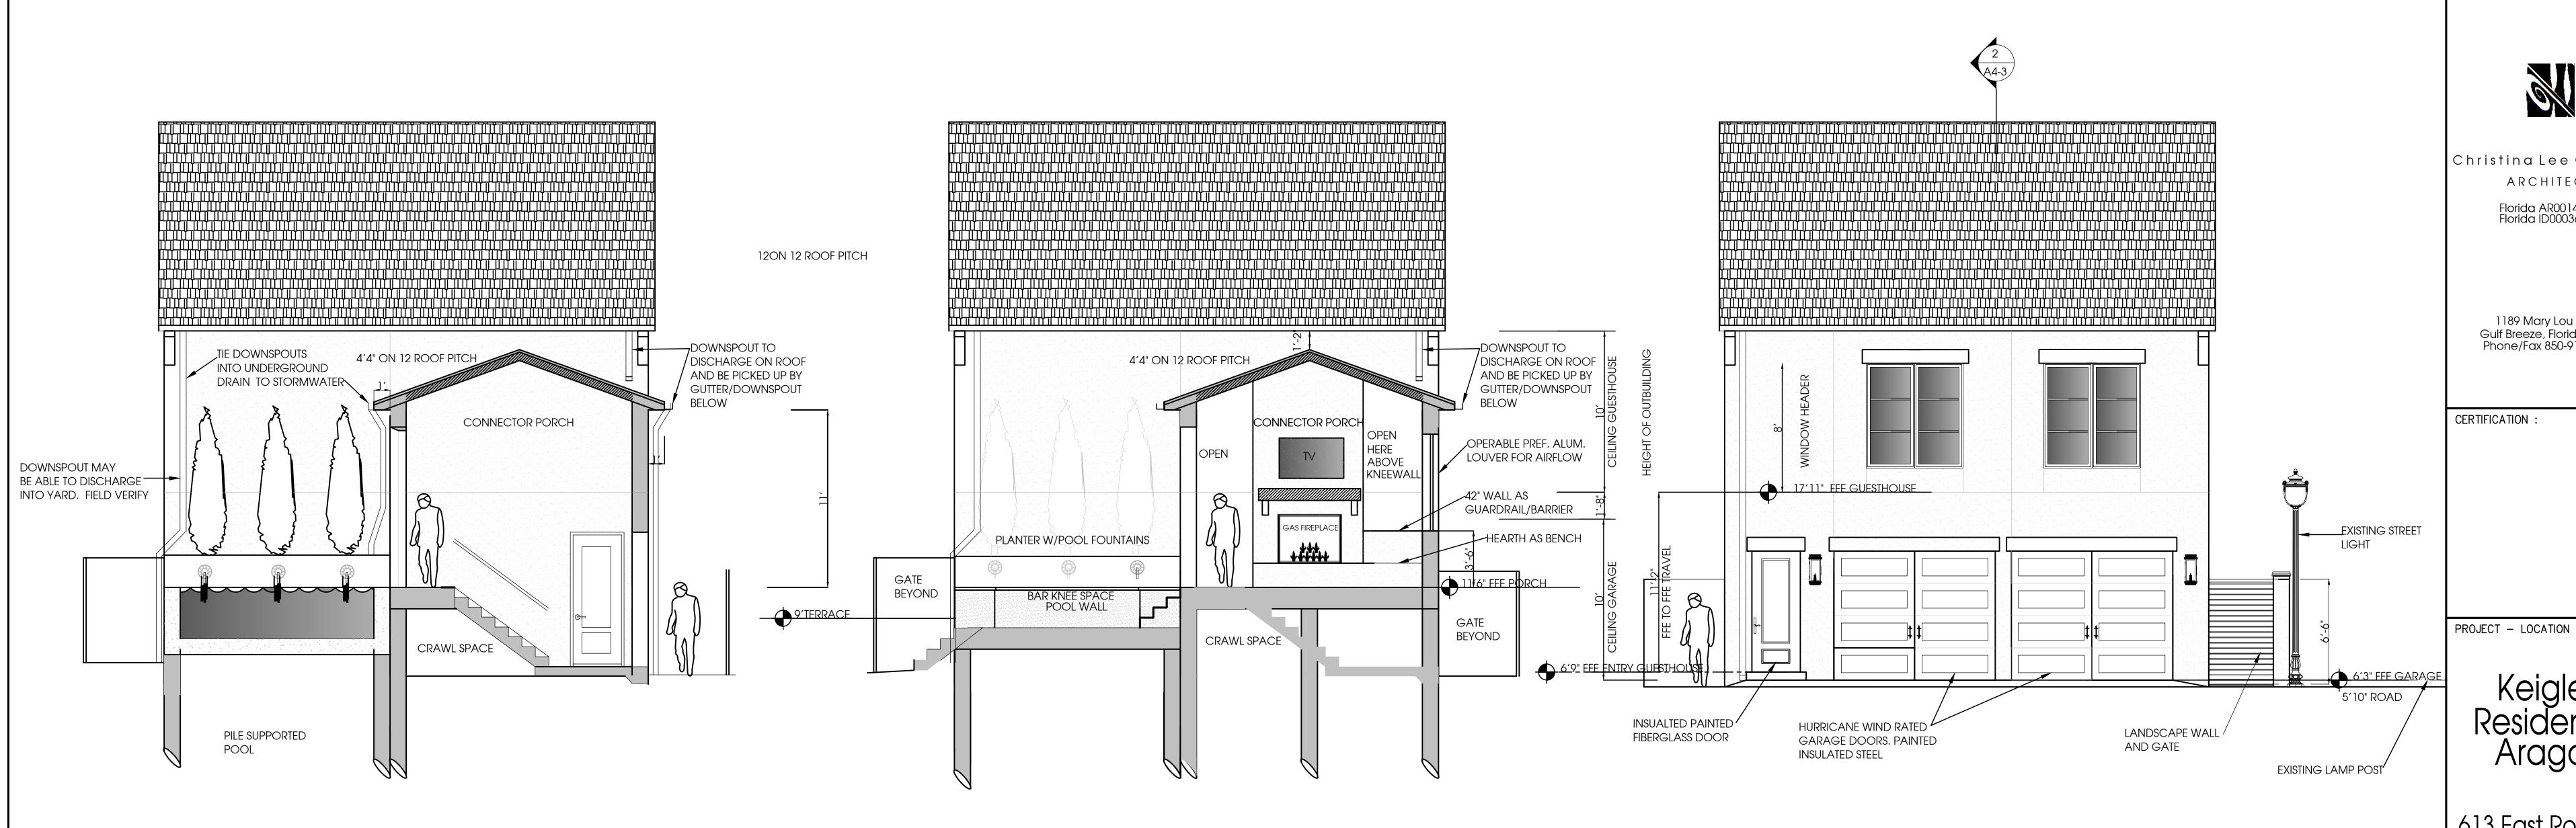

Garage Outbuilding Section at Steps steps to garage/pool

Garage Outbuilding North Elevation
Scale: 1/4"=1'-0" courtyard/fireplace /terrace

Garage Outbuilding-South Elevation

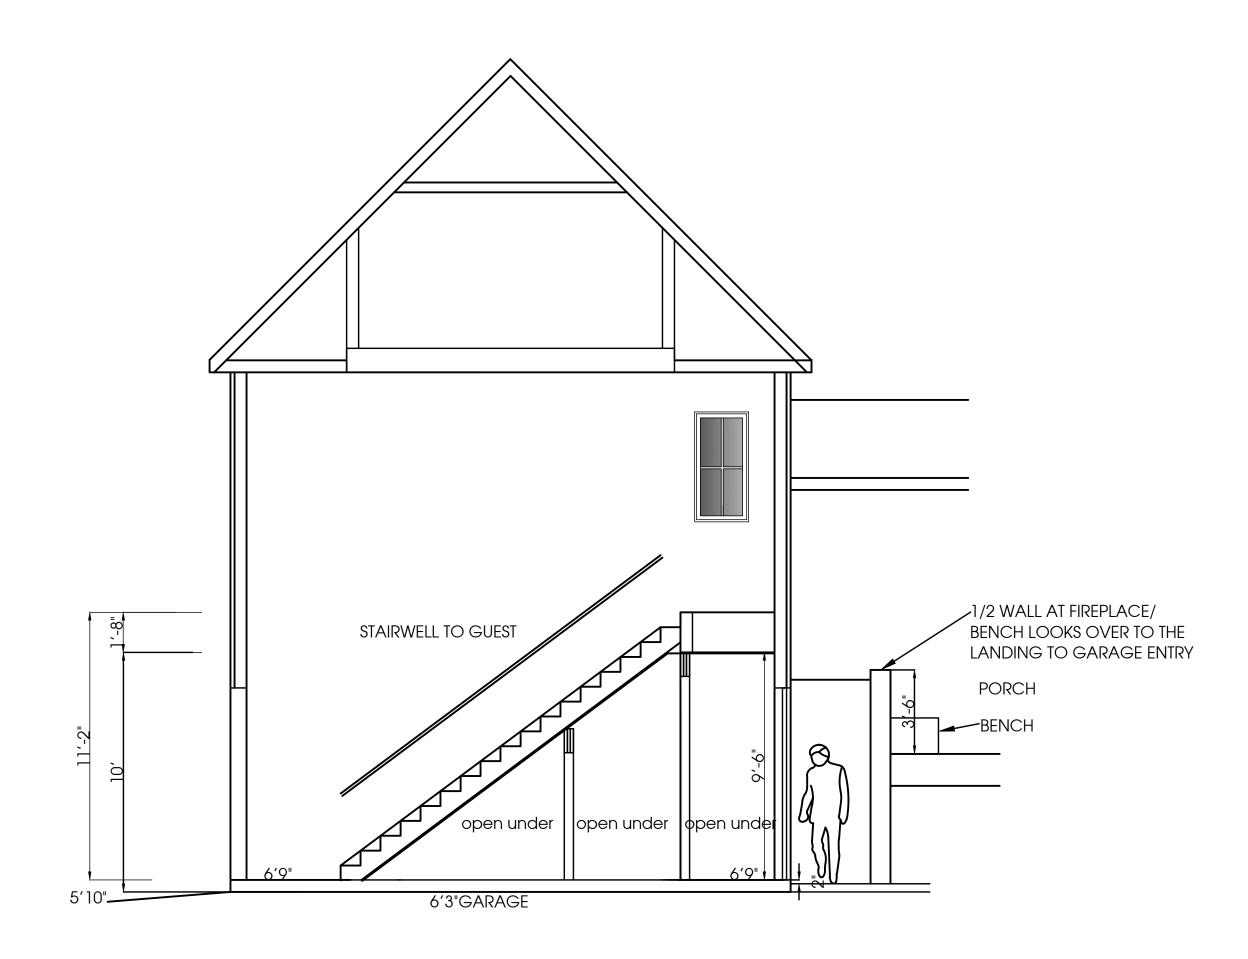

Section at Garage Stair looking West

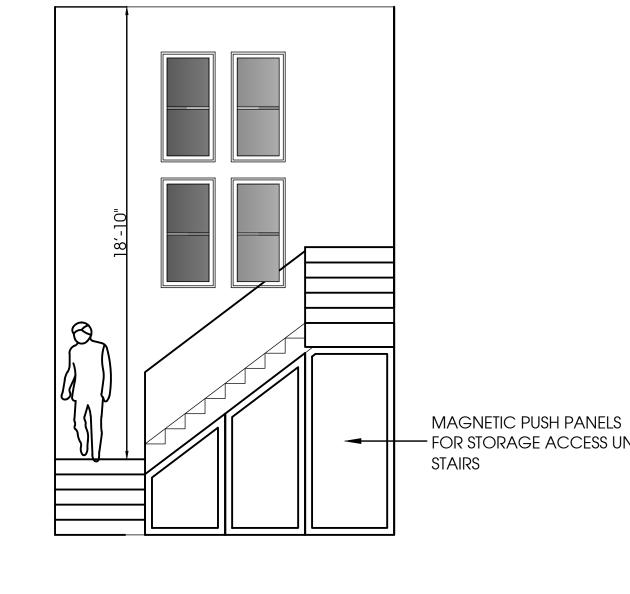
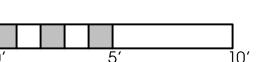


Diagram at Stair looking West




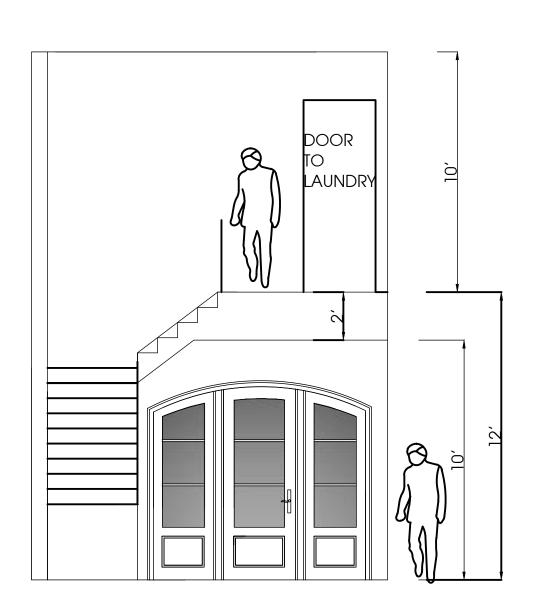


Diagram at Stair looking at Front Door



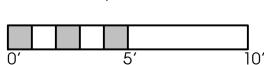

Christina Lee Cabassa ARCHITECT

> 1189 Mary Lou Lane Gulf Breeze, Florida 32563 Phone/Fax 850-916-9941

Florida AR0014272 Florida ID0003615

613 East Romana Lot 2 Block M

> Type II Cóttage HR-2

ALL DRAWINGS AND WRITTEN MATERIAL HEREIN CONSTITUTE ORIGINAL AND UN-PUBLISHED WORK OF THE ARCHITECT AND MAY NOT BE DUPLICATED IN ANY PART WITHOUT THE WRITTEN CONSENT OF THE ARCHITECT.

REVISIONS:

ARB Submittal 12,

DRAWN BY: CLC

CHECKED BY : CLC


PROJECT NO.

SHEET TITLE :

Elevations

SHEET NO.:

A2-4

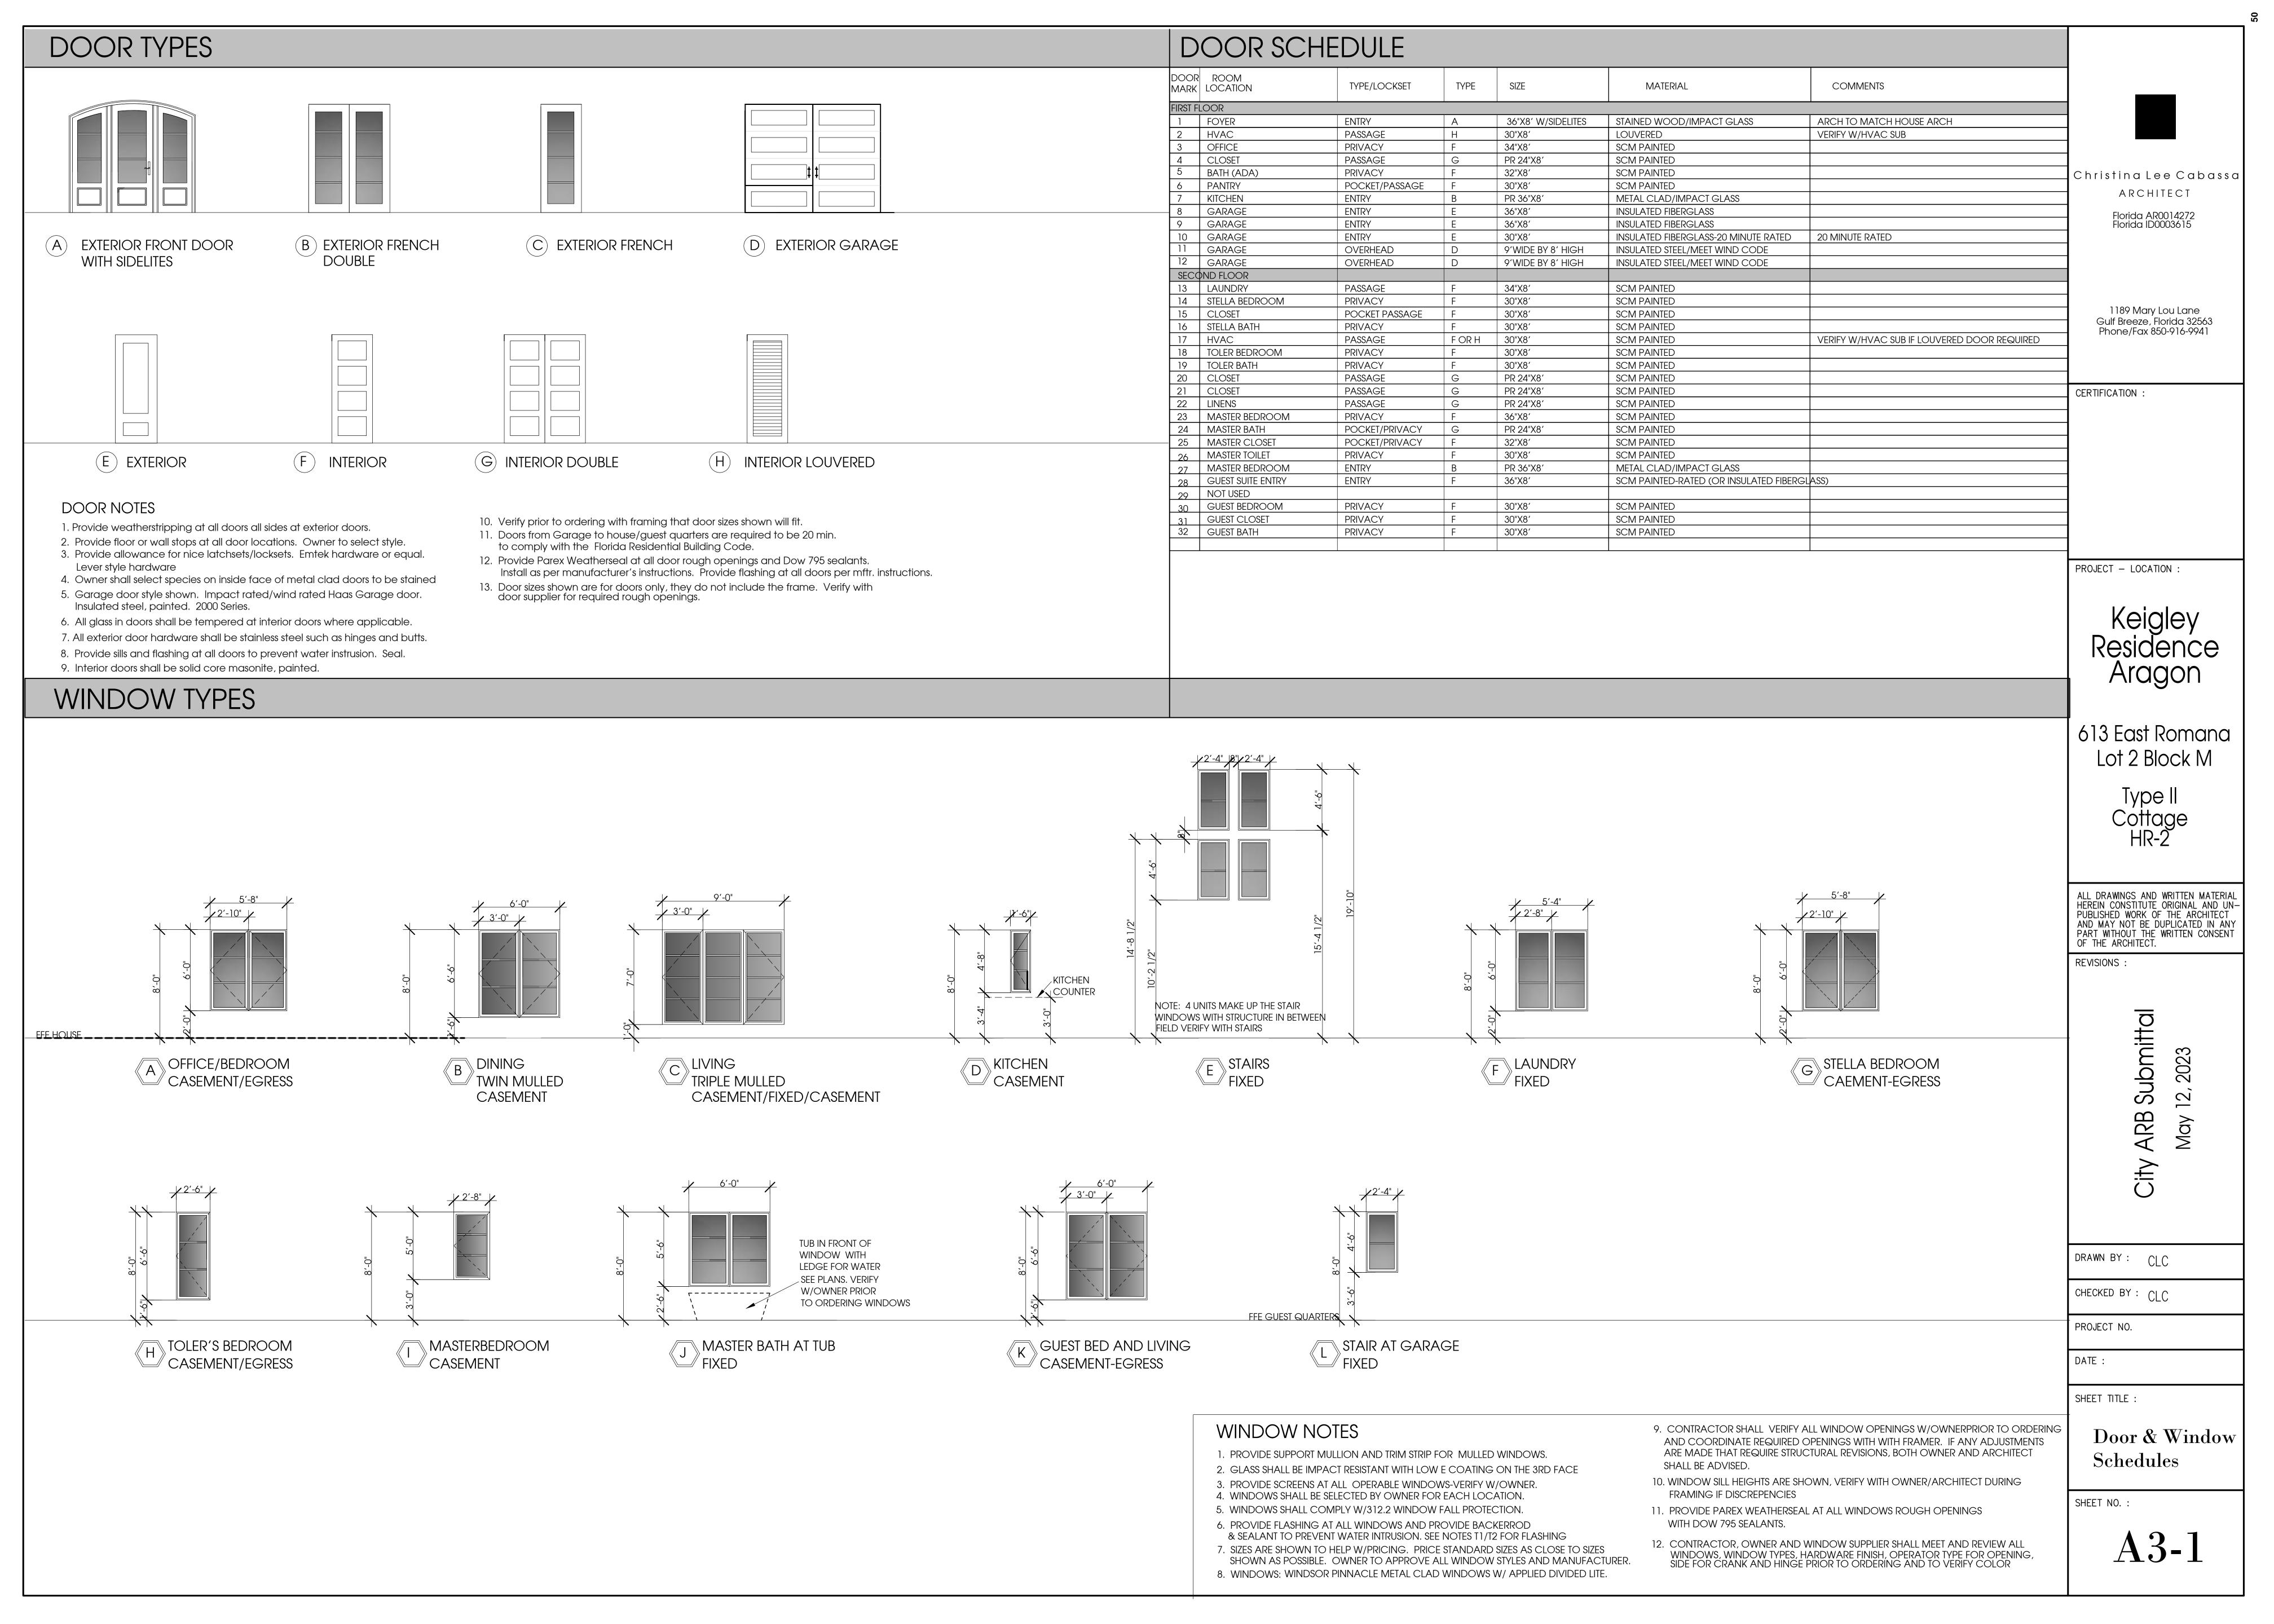



Site Looking South



Site Looking East



Site Looking West




1189 Mary Lou Lane Gulf Breeze, Florida 32563 Phone/Fax 850-916-9941

CERTIFICATION :




Site Looking North

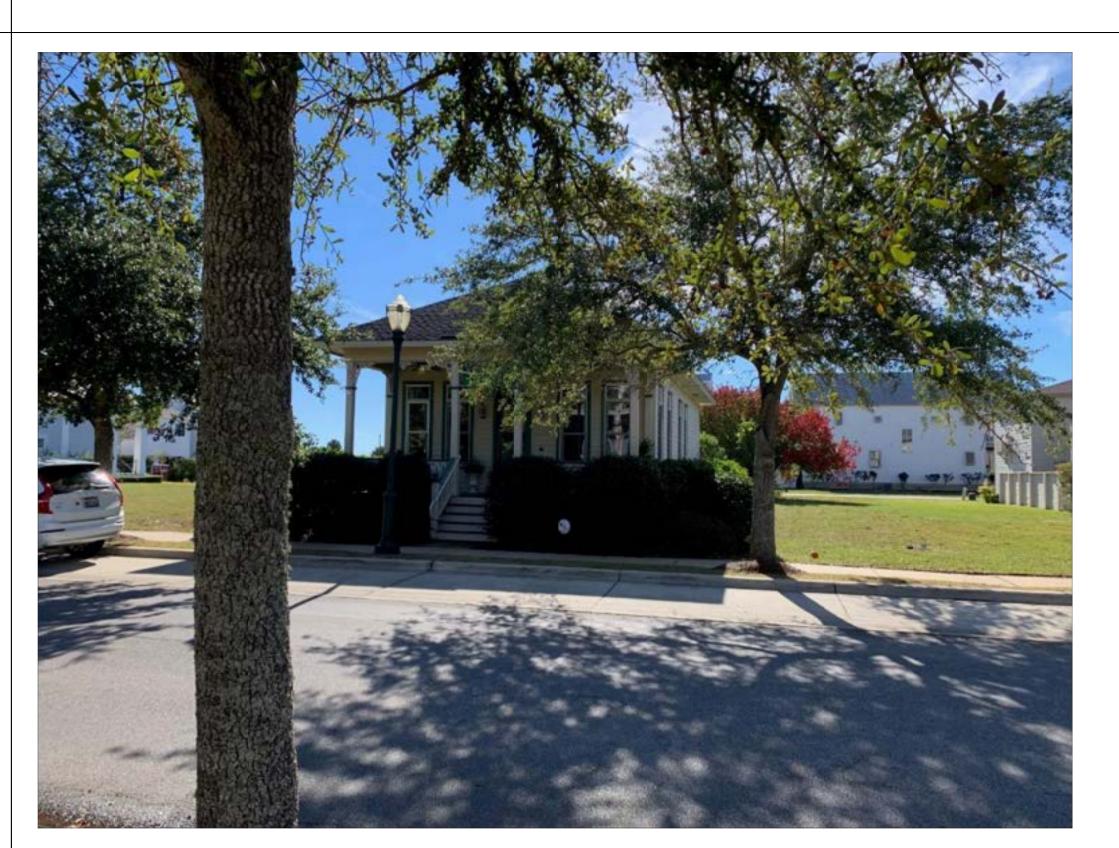

Improved Property to the East/Office



Improved Property to the West/Residence

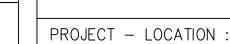

Keigley Residence Aragon

613 East Romana Lot 2 Block M

> Type II Cottage HR-2

ALL DRAWINGS AND WRITTEN MATERIAL HEREIN CONSTITUTE ORIGINAL AND UN-PUBLISHED WORK OF THE ARCHITECT AND MAY NOT BE DUPLICATED IN ANY PART WITHOUT THE WRITTEN CONSENT OF THE ARCHITECT.

REVISIONS:

City ARB Submittal

DRAWN BY:	CLC
CHECKED BY:	CLC

PROJECT NO.

DATE:

SHEET TITLE :

SHEET NO. :


Site Photos



East Neighbors Tree encroaching which will have to be trimmed or removed. Car wall is encroaching onto Keigley's property as indicated on the survey




Wall Surface and Paint Colors

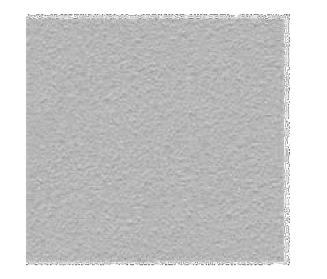

Stucco Finish Sand Fine (not color)

SW 7004 Snowbound

House Color Stucco Finish

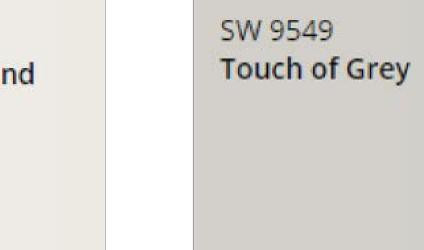

Designer Edition™

Trim Color & Garage Door

Emerald®

Exterior Lighting



St. James The Winnipeg Copper Outdoor Lantern & Chandelier Wall Sconce & Front Door Lantern (In Dark Bronze)

Front Door -Custom built



Style of Front door(no vertical mullions)



Color of Wood Finish



Christina Lee Cabassa ARCHITECT

Florida AR0014272 Florida ID0003615

1189 Mary Lou Lane Gulf Breeze, Florida 32563 Phone/Fax 850-916-9941

CERTIFICATION :

Railing Color & Example



BLACK STALLION Price per lb: Total Price 3 Description:
Black Stallion is a rich black. This coldr.
and has a high gloss finish. High Gloss 85+ Gloss Units

Railing Paint Color

Railing Style-Prefinished Aluminum

House Numbers (In Dark Bronze)




Number Style



Color: Dark Bronze

Back Yard French Doors

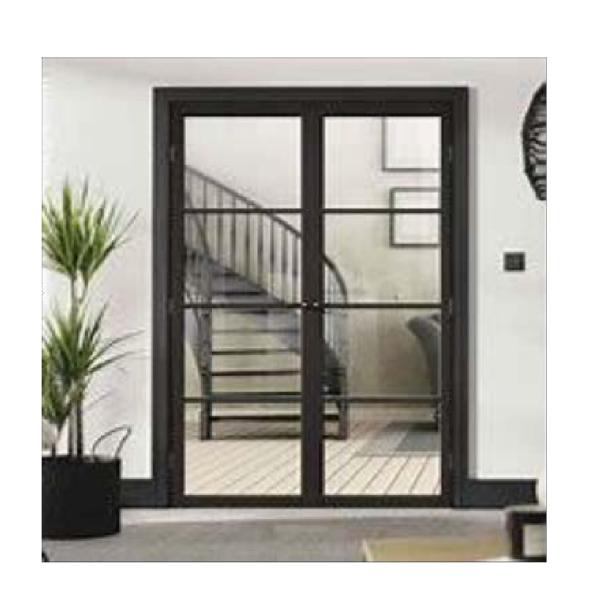


Windsor Pinnacle Metal Clad Doors Mullions 5/8" Putty TDL



Color: Black

Windows

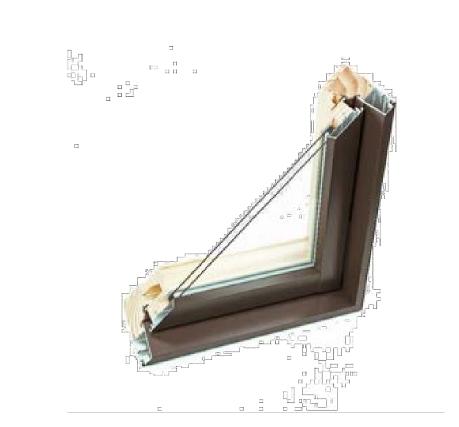

Windsor Pinnacle Metal Clad

w/applied mullions both sides

Style of window Casement 5/8" Putty TDL

Color: Black

Garage Doors



Haas 2000 Series Insulated Steel Doors 8 panel



Emerald® Designer Edition™

Paint color

Roof Material



Atlas Manufacturer Architectural Asphalt Shingle Color: Pewter

PROJECT - LOCATION

Aragon

613 East Romana Lot 2 Block M

Type II Cottage HR-2

ALL DRAWINGS AND WRITTEN MATERIAL HEREIN CONSTITUTE ORIGINAL AND UN-PUBLISHED WORK OF THE ARCHITECT AND MAY NOT BE DUPLICATED IN ANY PART WITHOUT THE WRITTEN CONSENT OF THE ARCHITECT.

REVISIONS :

Submittal 12, ARB

DRAWN BY: CLC

| CHECKED BY : CLC

PROJECT NO.

DATE :

SHEET TITLE :

SHEET NO. :

PRODUCTS 1

Ceiling Style



Ceiling Wood Color and Stain Weather washed Coating

Exterior Pavers Porches & Backyard




Peacock Pavers Style



Color: Rice White

Front Stair Riser Tile Example

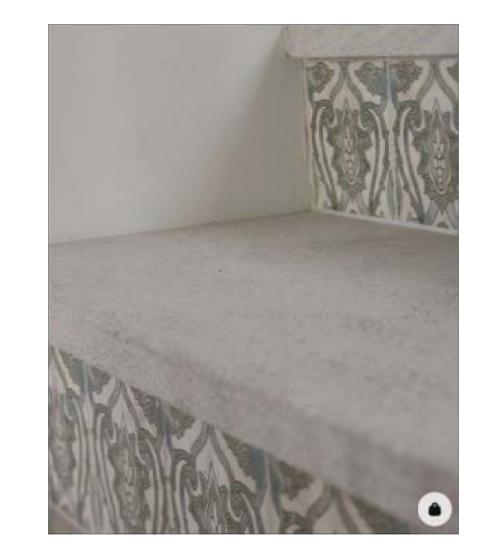

Concrete Decorative Tile at Riser

Christina Lee Cabassa

ARCHITECT
Florida AR0014272
Florida ID0003615

1189 Mary Lou Lane Gulf Breeze, Florida 32563 Phone/Fax 850-916-9941

CERTIFICATION:

Gutter and Downspout Style



Ogee Style gutter

Color: White

Landscape Fence style




Style of Fence

SW 9549 Touch of Grey

Emerald® Designer Edition™

Color of Fence

Floodvents Venting

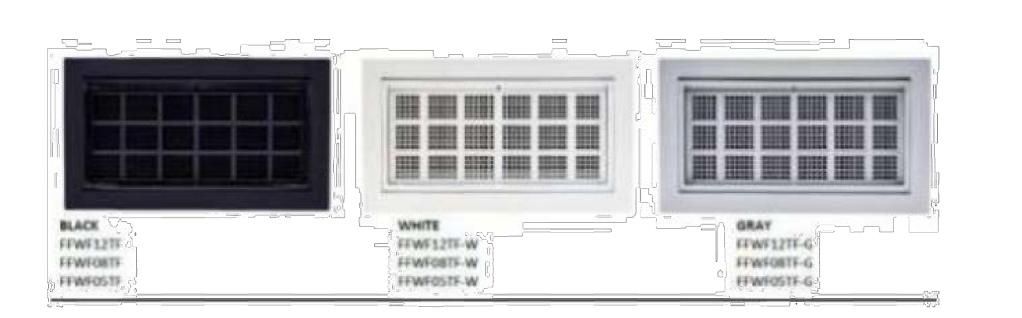


FEMA Approved for Floodvents at Garage

Color: White

Pavers at sidewalk and Driveway



Belguard Holland Pavers

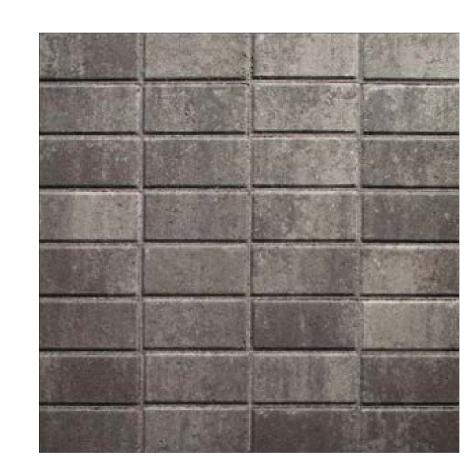

Color: Slate

Residence Aragon

PROJECT - LOCATION:

613 East Romana Lot 2 Block M

> Type II Cottage HR-2

ALL DRAWINGS AND WRITTEN MATERIAL HEREIN CONSTITUTE ORIGINAL AND UN-PUBLISHED WORK OF THE ARCHITECT AND MAY NOT BE DUPLICATED IN ANY PART WITHOUT THE WRITTEN CONSENT OF THE ARCHITECT.

REVISIONS:

ity ARB Submittal May 12, 2023

DRAWN BY: CLC

CHECKED BY: CLC

PROJECT NO.


DATE :

SHEET TITLE :

SHEET NO. :

PRODUCTS 2

WINDOW AND BACK DOOR GRILL PROFILE

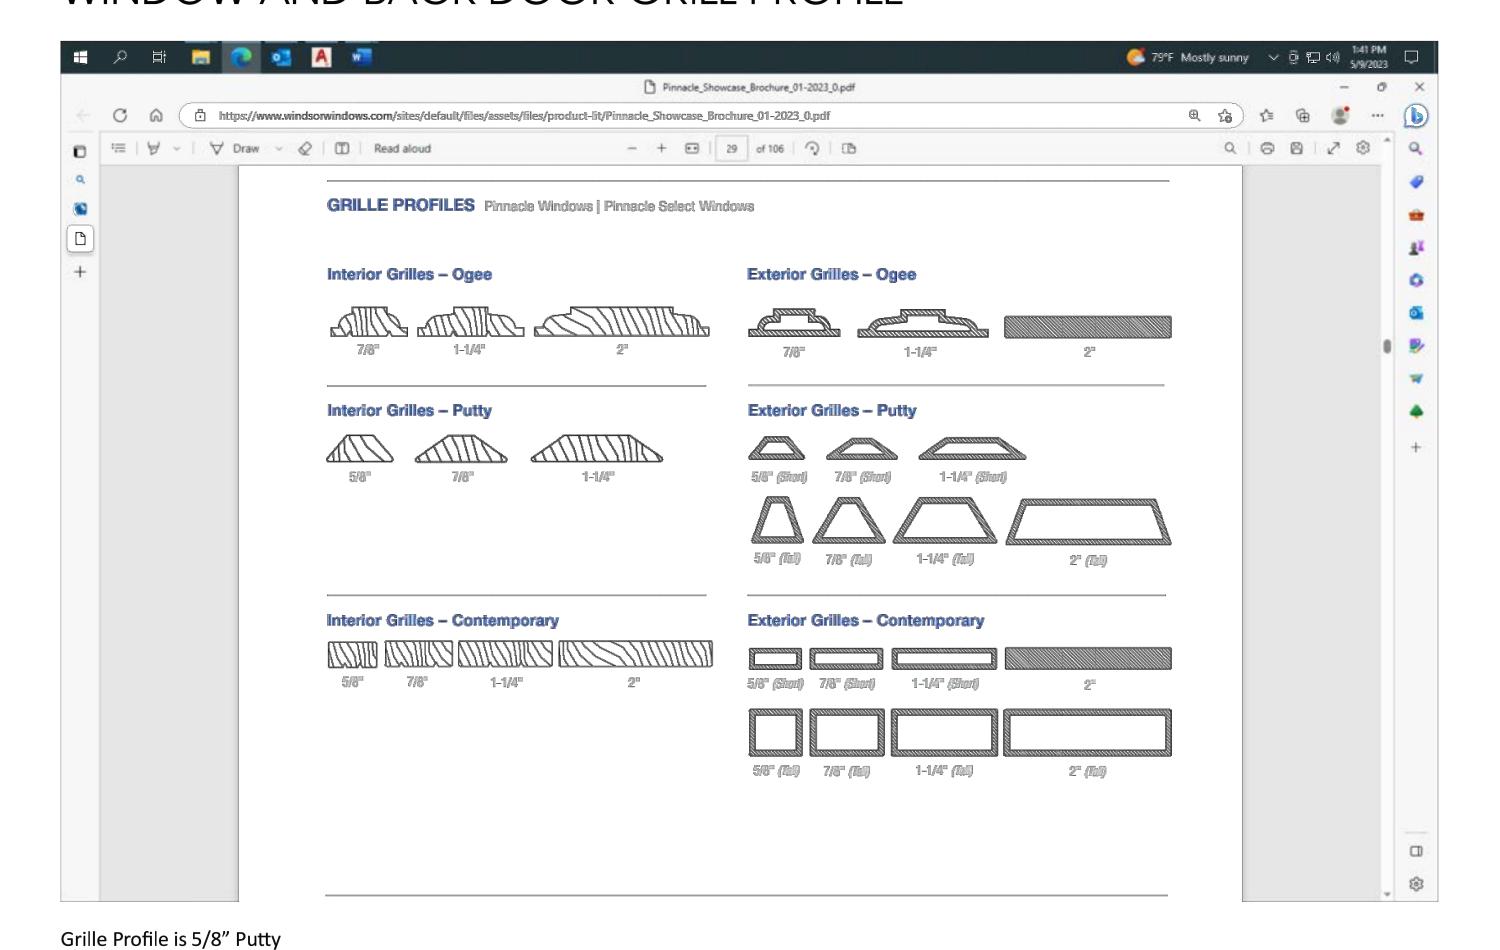

WINDOWS & DOORS

Pinnacle Swinging Patio Door

Features and Benefits

- Stainless steel multi-point locking hardware option for added security Integral structural astragal allows for
- doors up to 12 feet wide to be placed in a single frame, which decreases the potential for air and water infiltration
- "Easy Adjust" hinge system for effortless operation and correction after installation Wept sill system to eliminate water infiltration
- Dual-seal frame weatherstripping at panel face and edge improves air and thermal performance
- Taller sill provides excellent water performance and design pressure ratings
- Foam-backed glazing bead prevents paint and stain from bleeding Active stiles constructed of an LVL core
- material for added strength and stability Panel exterior matches Pinnacle product line with consistent depth from glass to face of the panel for a clean,
- complementary appearance Panels available in traditional French or contemporary narrow stile
- Low clearance (ADA-approved) sill options In-swing and out-swing options available • 1/2 and 3/4 lite available with flat or split panel option

Seg-top available

Sizes

- Five standard heights: 6'8", 6'10", 8'0", 9'0" and 10'0" (9'0" and 10'0" doors available in French panels only)
- Custom sizes available





 Windsor Glazing System provides 3/4" double pane insulated glass; Cardinal® LoE 366 glass standard; tinted, tempered, obscure and laminated glass available

Interior stop glazed with silicone sealant

casing; primed doors available with WM

Custom and special glass types available

- Interior Available in Clear Select Pine, **Exterior Trim** Douglas Fir or Natural Alder Clad doors available with WM 180 - Primed: white or black brickmould, Williamsburg or 3-1/2" flat
- Painted: white, black or gray - Stained: 9 color options 180 brickmould, WM 180 brickmould with Exterior – Clad doors available in heavy-

Weatherstripping

Finishes

encased in polyethylene film

Rigid, weatherable PVC or urethane foam

bottom heavy-duty, self-adjusting sweep

In-swing and out-swing doors feature

duty extruded aluminum cladding; primed flange, Williamsburg, 3-1/2" flat, 4-1/2" backband, 5-1/2" flat or plantation casing doors offer an assortment of traditional All prime door trims are cellular PVC cellular PVC trim options

Clad Colors Windsor Divided Lite (WDL) = simulated divided lite All clad colors painted in-house with the • 7/8" and 1-1/4" Perimeter Grille highly durable AAMA 2604 standard finish, • 3-4" and 1" Profiled Inner Grille or upgrade to AAMA 2605 for the most

- 13/16" Flat Inner Grille challenging of environments • 7/8" and 1-1/4" Ogee WDL 23 Standard Clad Colors available in 2604 • 5/8", 7/8", 1-1/4" and 2" Short Putty and 2605 finish
- 20 Feature Clad Colors available in 2604 • 5/8", 7/8", 1-1/4" and 2" Short and 2605 finish (Custom color matching Contemporary WDL is also available)
- 3-3/8" Simulated Mid Rail • 7 Matte Clad Colors available in the 2604 Standard and custom grille patterns finish only

Hardware

Classic or contemporary handle available in white, brushed chrome, polished chrome, satin nickel, antique nickel, brass, antique brass, faux bronze, oil rubbed bronze and black; Euro handle available in satin nickel

Performance Ratings

For current performance ratings, visit our website at windsorwindows.com and click on "Professional Information" in the menu bar

WINDOWS & DOORS

Pinnacle Select Impact Casement & Awning

Push-outs equipped with adjustable

Operating casement uses adjustable

Laminated glass allows unit to crack

instead of shatter when under great

Meets and exceeds building codes for

extreme coastal environment conditions

Laminated glass dampens sounds from

traffic, neighbors and the outdoors

Available in hundreds of standard and

Glazed with tape and structural glazing

Cardinal Sea-Storm[®] LoE 366 insulated

glass standard, featuring stainless steel

spacers; tinted, tempered and laminated

Custom and special glass types available

Insulated glass utilizes annealed glass on

exterior and laminated glass on interior

• Laminated glass features PVB inner layer

on operating units with optional SGP inner

layer; fixed units feature SGP inner layer

custom sizes

glass available

Exterior Trim

Glazing

Preserve protective film standard

Certified against hurricane blasts:

casement and awning

maintains sash opening

friction hinges and lock rollers in both

Features and Benefits

- Clear Select Pine, Douglas Fir or Natural Alder interior
- Constructed with 2-5/16" wide stiles and rails that add structural stability and provide a more massive architectural
- appearance Robust 2-3/16" thick sash adds dimension and strength
- Double mortise and tenon sash joints fastened with screws for strength and
- Select casement and awning available
- in two styles Operating: standard crank

same wood species as window

Push-out: lever handle Retractable screens available on operating and push-out products; pull bar, cartridge case and frame of screen produced from



 Full-width extension jambs standard Push-out hardware consists of an easyto-operate lever with cam rollers and keepers; this mechanism provides a multipoint locking system that is standard*



available on radius casements)

Clad windows available with WM 180 brickmould, Williamsburg or 3-1/2" flat casing; 3/8", 1-1/4" and 2-1/4" subsill

- Windsor Divided Lite (WDL) = simulated divided lite • 7/8" and 1-1/4" Perimeter Grille (NOT
- 7/8" and 1-1/4" Stick Grille • 3/4" and 1" Profiled Inner Grille • 13/16" Flat Inner Grille
- 7/8" and 1-1/4" Ogee WDL • 5/8", 7/8", 1-1/4" and 2" Tall and Short Putty WDL

- 5/8", 7/8", 1-1/4" and 2" Tall and Short
- Contemporary WDL • 2" Simulated Check Rail Friction device on larger push-out awning Standard and custom grille patterns available

- Interior Available in Clear Select Pine, Douglas Fir or Natural Alder - Primed: white or black
- Painted: white, black or gray Stained: 9 color options
- Exterior Clad windows feature heavyduty extruded aluminum cladding on sash and frame

Clad Colors

- All clad colors painted in-house with the highly durable AAMA 2604 standard finish, or upgrade to AAMA 2605 for the most
- challenging of environments • 23 Standard Clad Colors available in
- 2604 and 2605 finish • 20 Feature Clad Colors available in 2604 and 2605 finish (Custom color matching
- is also available) 7 Matte Clad Colors available in the 2604

Hardware

- Encore folding nesting crank and cover by Truth® available in champagne, white, bronze and black; optional finishes in faux bronze, oil rubbed bronze, satin nickel and bright brass. Push-out available in white, black, faux bronze, satin nickel or
- Units come standard with Seacoast upgraded hinges and locking hardware

Performance Ratings

oil rubbed bronze

For current performance ratings, visit our website at windsorwindows.com and click on "Professional Information" in the menu bar

Christina Lee Cabassa ARCHITECT

> Florida AR0014272 Florida ID0003615

1189 Mary Lou Lane Gulf Breeze, Florida 32563

Phone/Fax 850-916-9941

CERTIFICATION

PROJECT - LOCATION

Aragon

613 East Romana Lot 2 Block M

ALL DRAWINGS AND WRITTEN MATERIAL HEREIN CONSTITUTE ORIGINAL AND UN-PUBLISHED WORK OF THE ARCHITECT AND MAY NOT BE DUPLICATED IN ANY PART WITHOUT THE WRITTEN CONSENT OF THE ARCHITECT.

REVISIONS:

Submittal 12 ARB

DRAWN BY: CLC CHECKED BY: CLC

PROJECT NO. DATE :

SHEET TITLE :

SHEET NO.:

Manufacturer 1


www.windsorwindows.com

9/2022


www.windsorwindows.com

12/2022


FRONT LIGHT

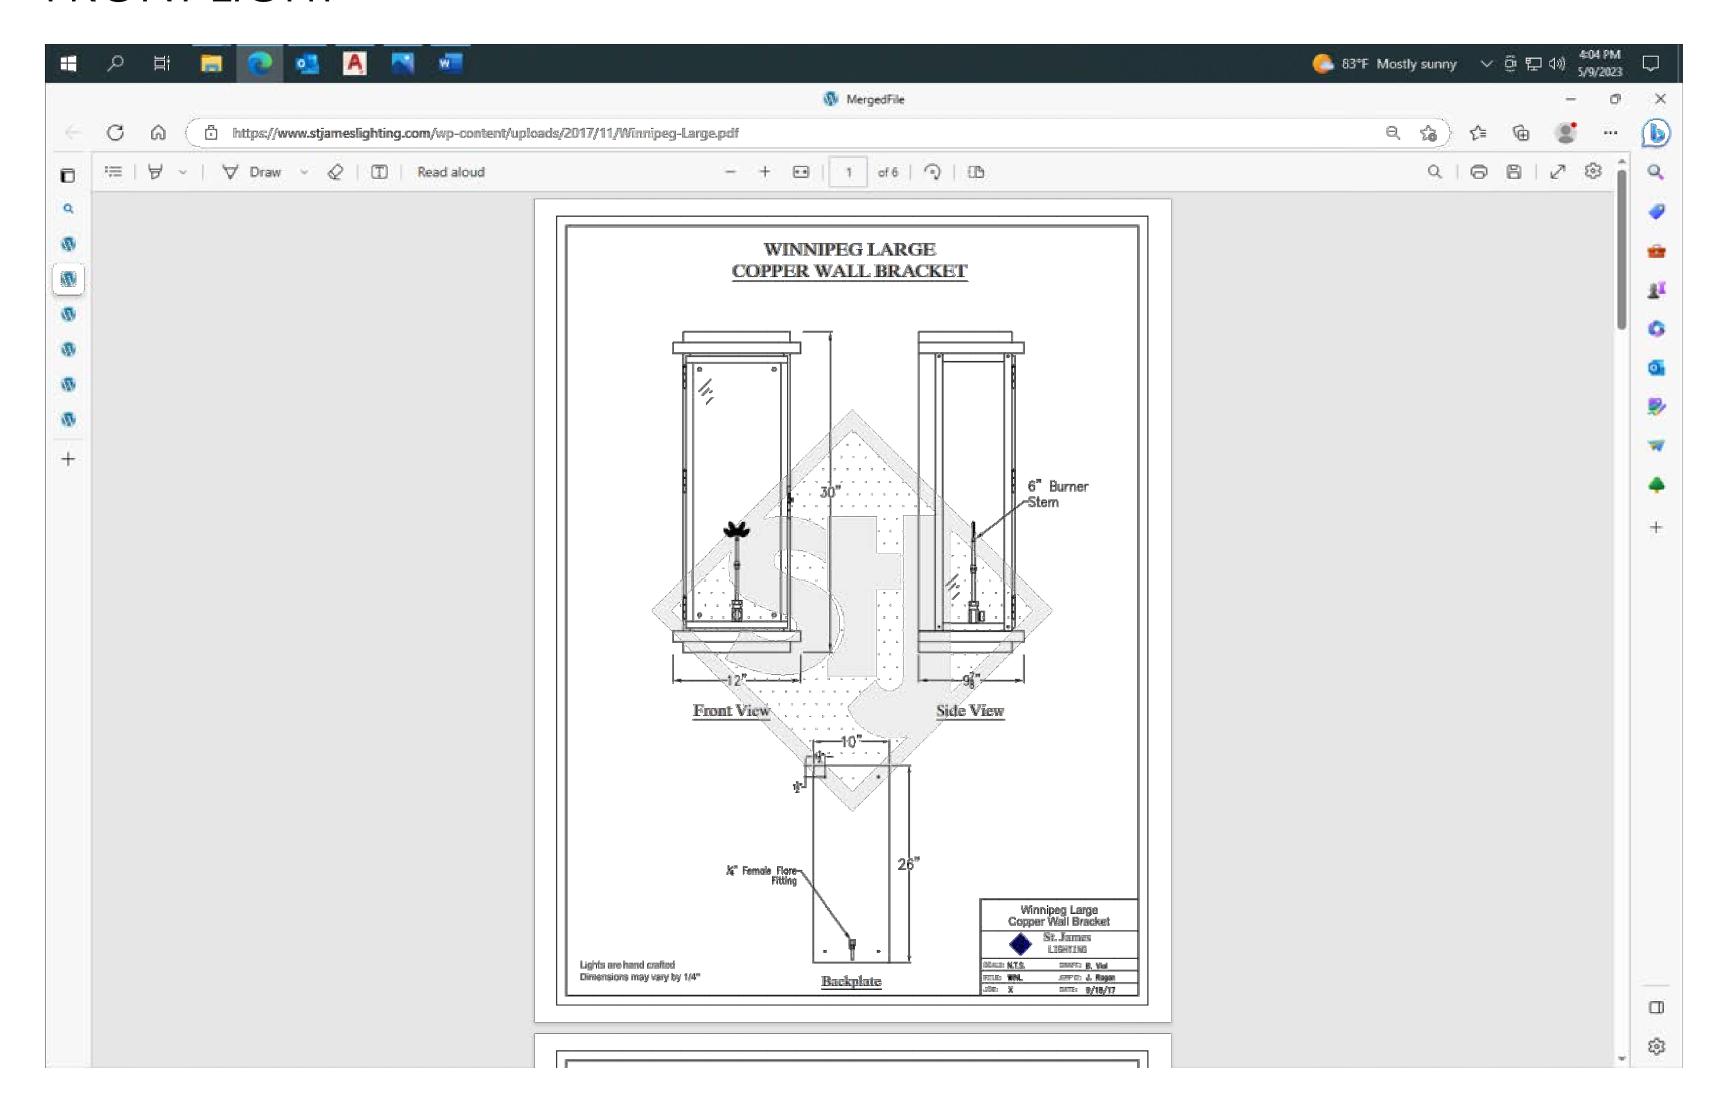


GARAGE LIGHTS

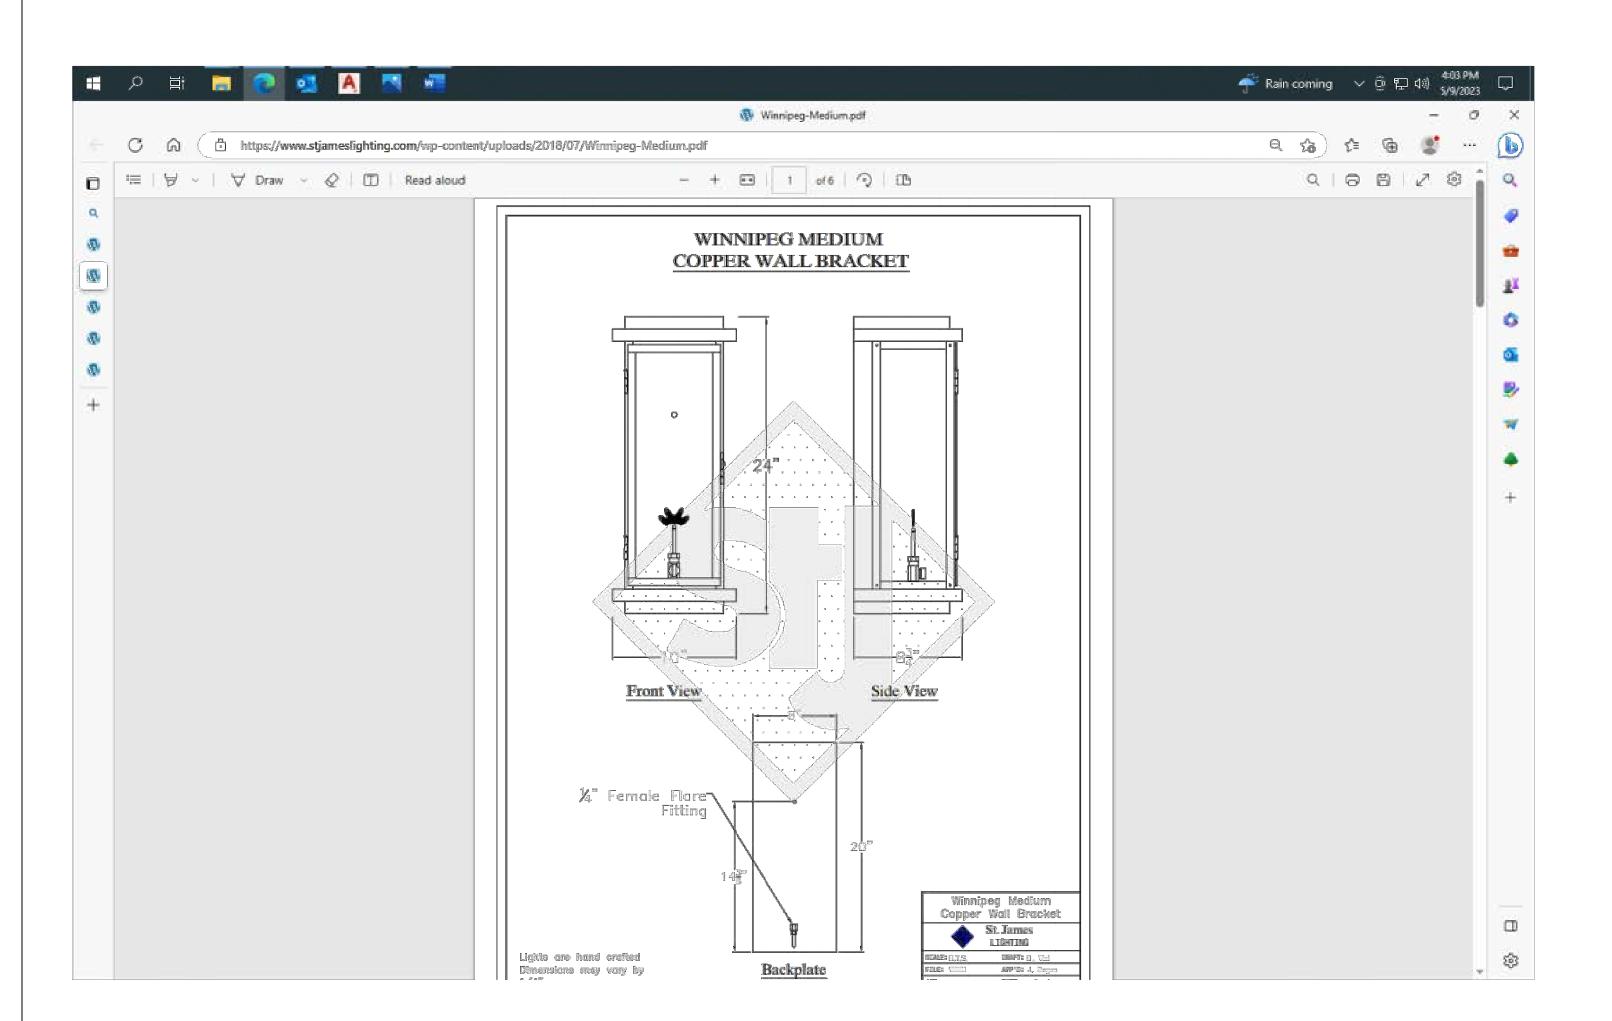

GARAGE DOOR SPECS

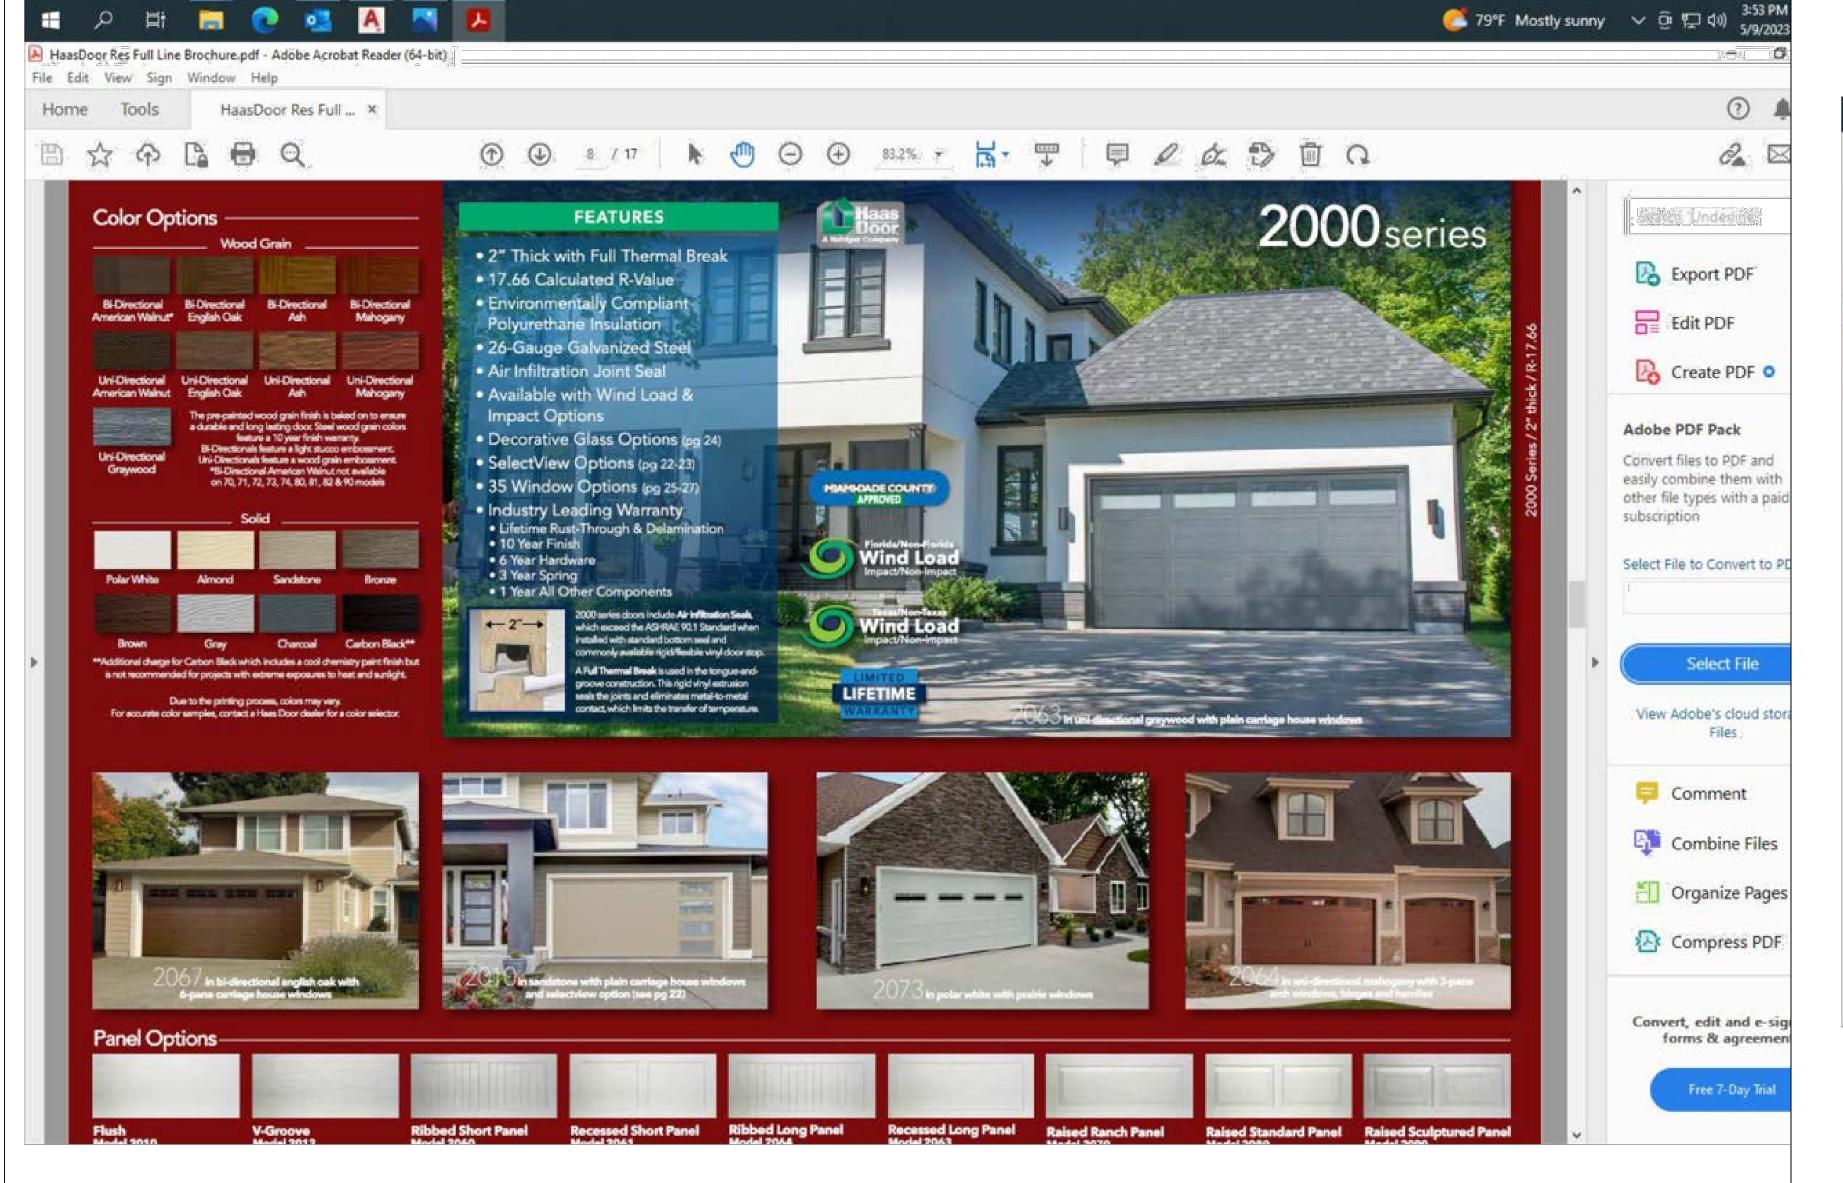

FRONT PORCH YOKE LIGHT

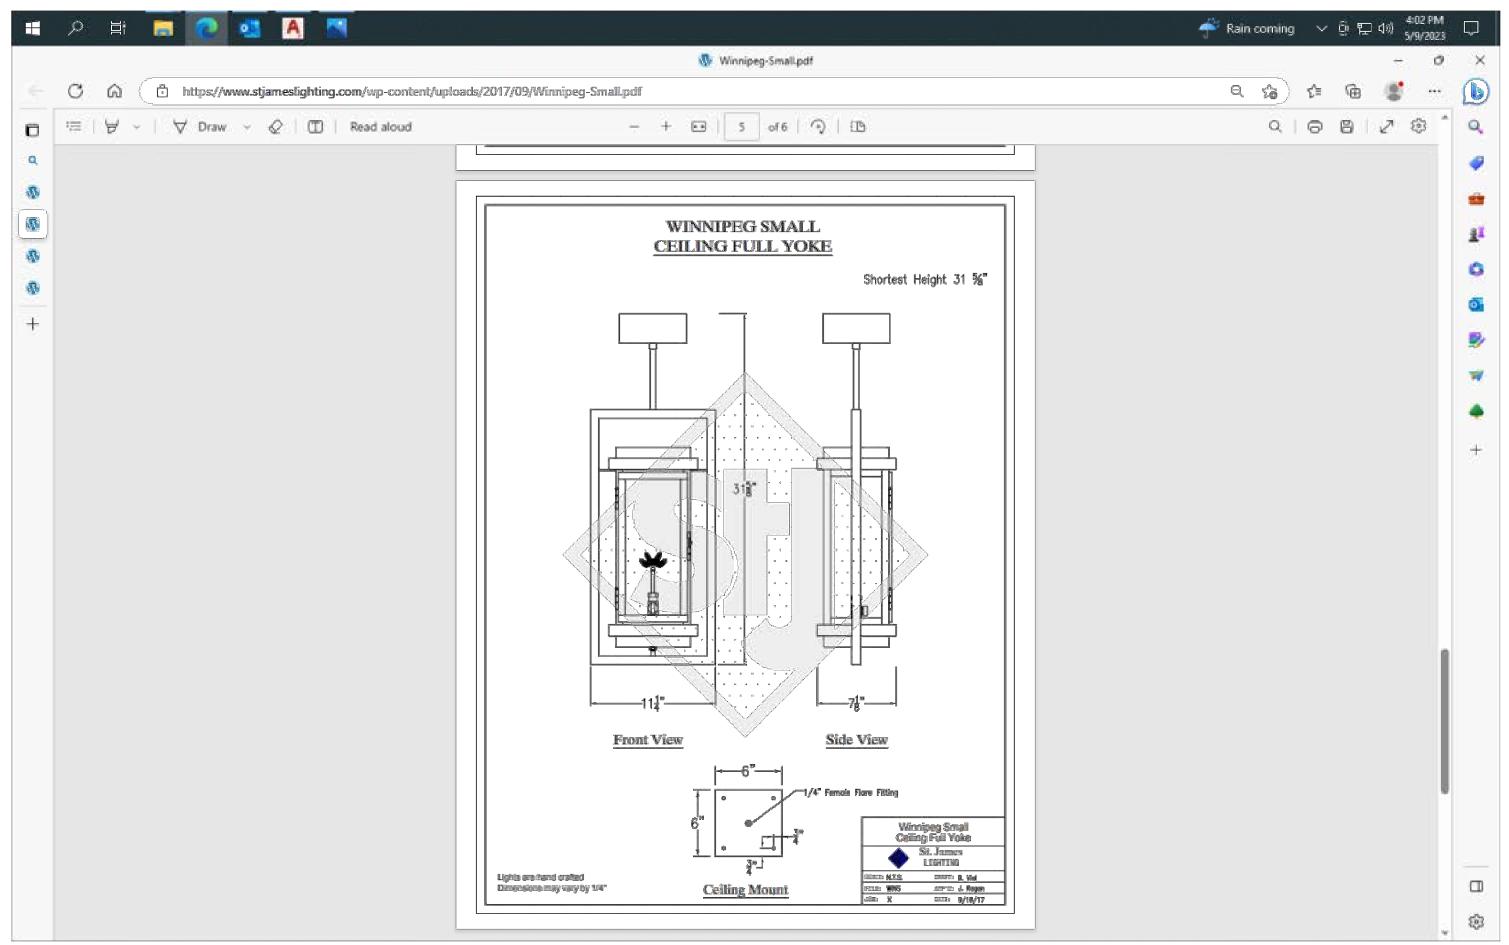




PROJECT - LOCATION :

613 East Romana Lot 2 Block M

Aragon

Type II Cottage HR-2

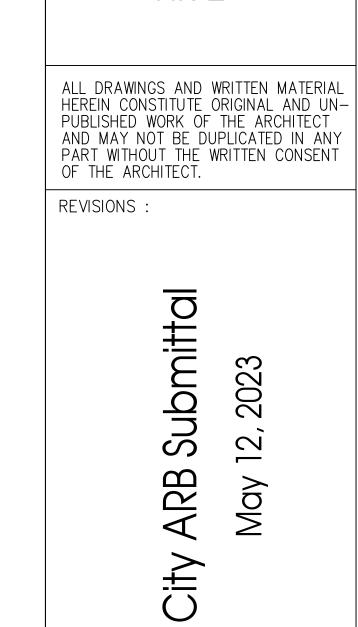

DRAWN BY: CLC

CHECKED BY: CLC

PROJECT NO.

DATE:

SHEET TITLE:

Manufacturer 2

Adrianne Walker

From: Adrianne Walker

Sent:Tuesday, May 9, 2023 11:36 AMTo:Christy Cabassa; Gregg HardingCc:Ashley Keigley; 'Brian Keigley'

Subject: RE: [EXTERNAL] FW: Keigley Construction Document Review

Hi Christy,

The Aragon ARB email correspondence should suffice, and I can include it in your packet as a memo.

The City ARB will require the same information for a complete packet e.g. product information for windows and doors/garage door, window/door schedule, etc. and it probably wouldn't hurt to increase the size of the some of the material imagery just for detail sake. I also suggest including product information/ a brochure for all exterior light fixtures as well.

You are correct, the June 15 ARB meeting deadline for submission is May 25. Providing the complete pdf application ahead of the deadline is always helpful so there is time to review for any last-minute additions. Please let me know if you have any questions.

Thanks, Adrianne

Adrianne Walker, RPA

Cultural Resources Coordinator
Visit us at http://cityofpensacola.com
222 W Main St.

Pensacola, FL 32502

Office: 850.435.1671

awalker@cityofpensacola.com



Tell us how we are doing by completing this short <u>survey</u>.

Florida has a very broad public records law. As a result, any written communication created or received by City of Pensacola officials and employees will be made available to the public and media, upon request, unless otherwise exempt. Under Florida law, email addresses are public records. If you do not want your email address released in response to a public records request, do not send electronic mail to this office. Instead, contact our office by phone or in writing.

From: Christy Cabassa <christy931@mchsi.com>

Sent: Tuesday, May 9, 2023 8:34 AM

To: Gregg Harding <GHarding@cityofpensacola.com>; Adrianne Walker <AWalker@cityofpensacola.com>

Cc: Ashley Keigley <akeigley@gmail.com>; 'Brian Keigley' <keigley@gmail.com>

Subject: [EXTERNAL] FW: Keigley Construction Document Review

THIS EMAIL IS FROM AN EXTERNAL EMAIL ACCOUNT

Gregg and Adrianne

Good Morning!!

Before I submit my final documents on an Aragon project I wanted to be sure this email approval from Aragon ARB would suffice.

See below.

I had the metal clad windows called out and doors on the drawings and on this ARB selections document.

I have attached to make sure this is what you all will be looking for as well for the material selecitons.

I hope to submit by Friday or Monday May 15th. I believe the deadline is May 25 for the June 15th meeting.

Can you please confirm?



1189 Mary Lou Lane phone 850-712-5788 + Gulf Breeze, Fl 32563 + email: christy931@mchsi.com

Florida Registered Architect AR0014272 Florida Licensed Interior Designer ID0003615

From: Michael Crawford <michael@caldwell-assoc.com>

Sent: Friday, May 5, 2023 9:44 AM

To: Christy Cabassa < christy931@mchsi.com>

Cc: 'Brian Keigley' <keigley@gmail.com>; Ashley Keigley@gmail.com>; kelly.wieczorek@gmcnetwork.com;

Michelle MacNeil <michellemacneil22@gmail.com>; Nora Bailey <norabailey52@gmail.com>; Susan Moody

<susan@professionalassociationmanagers.com>

Subject: RE: Keigley Construction Document Review

Christy – your Construction Document Review application has been approved with the following comments:

- 1. Please indicate the product line (which determines material composition) of your Windsor windows they have several that are clad.
- 2. Please indicate product line of the Haas garage doors there are 8 different series. Note the carriage style doors are encouraged.
- 3. PDF packaged worked great thank you.
- 4. Please follow up with verification of FEMA minimum flood elevation and if any modifications to the approved plans should be required.
- 5. Note that this is in the ARB jurisdiction and will need to be presented for approval before its board.

Good luck on your new home.

Michael Crawford

AIA, LEED AP, CPTED (850) 439.3237 michael@caldwell-assoc.com caldwell-assoc.com



City of Pensacola

Memorandum

File #: 23-00462 Architectural Review Board 6/15/2023

TO: Architectural Review Board Members

FROM: Adrianne Walker, Cultural Resources Coordinator

DATE: 6/8/2023

SUBJECT:

410 S. Florida Blanca Street
Pensacola Historic District / Zone HC-1 / City Council District 6
New Accessible Ramp for a Contributing Structure

BACKGROUND:

Carter Quina is seeking approval for a wood accessible ramp connecting to an existing raised porch. The Barkley House is a contributing structure, but the raised porch and restroom/kitchen addition are modern reconstructions. The wood ramp, guard rail, and post caps will be painted white to match the existing with an aluminum brushed grab rail and a paver landing to match existing.

Please find attached all relevant documentation for your review.

RECOMMENDED CODE SECTIONS

Sec. 12-3-10(1) b. Historic and preservation land use district, Historic zoning districts: HR-1, HR-2, HC-1, and HC-2, Character of the district.

Sec. 12-3-10(1)e.8. Paint colors.

Sec. 12-3-10(1)f.11. Restoration, rehabilitation, alterations or additions to existing contributing structures in the historic district, Accessibility ramps and outdoor stairs.

Page 1

☐ Original ☑ Update



HISTORICAL STRUCTURE FORM FLORIDA MASTER SITE FILE

Version 4.0 1/07

Site #8 ES00128
Field Date 9-9-1997
Form Date 9-9-1997
Recorder #

Shaded Fields represent the minimum acceptable level of documentation. Consult the *Guide to Historical Structure Forms* for detailed instructions.

			Multiple Lieting (DHR only)	
Site Name(s) (address if none) BARKLEY HOUSE Survey Project Name FLORIDA FOLK ARCHITECTURE SU	JRVEY		Multiple Listing (DHR only) Survey # (DHR only)	
National Register Category (please check one) 🗵 building				
Ownership: private-profit private-nonprofit private-individual				n u nknown
LOG	CATION & MA	PPING		
Street Number Direction Street Name		Street Type	Suffix Direction	
Address: 410 S FLORIDA BLA		Street	S	
Cross Streets (nearest/between) ZARAGOZA AND FLORIDA		Plot or O	4	
USGS 7.5 Map Name PENSACOLA City / Town (within 3 miles) Pensacola In	City Limits? Files F	<u>1987</u> Flatolo Ino Flunknown (ther Map TAX ASSESSORS, P	ENSACOLA
			Irregular-name:	
Tay Parcel # STATE-OWNED	L		Y TRACT; SITE OF SPANISH	
Subdivision Name PENSACOLA HISTORIC DISTR		3lock <u> </u>	Lot 31	
UTM Coordinates: Zone ☐16 ☐17 Easting ☐ ☐ ☐	Northing			
Other Coordinates: X: Y:	Coordinate	System & Datum		
Name of Public Tract (e.g., park)				<u> </u>
	HISTORY			
MANUAL SALLES AND A STORY		= + + + = = + + +		
Construction Year: 1821 Mapproximately Uye				
Original Use Private Residence (House/Cottage/Courant Use Boardinghouse): 1825): 1930	To (year): 1966 To (year): 1940	
Other Use Community center	From (year): 198 <u>5</u>	To (year):	
Moves: Tyes The Tunknown Date:	Original address	·		
Alterations: yes no unknown Date: 1-1-1950	Nature1972;	1988; REHAB UN	DER DIRECTION HPPB	
Additions: yes no unknown Date:	Nature			
Architect (last name first): N/A			KLEY, CHARLES	ייי שידים
Ownership History (especially original owner, dates, profession, etc.) CLARA GARNIER OF NEW ORLEANS, COMBINES ENGLI	BUILT BY CUNYTHE	CHARACTERIS	TTCS	H MIEE
is the Resource Affected by a Local Preservation Ordinance				
The state of the s	•	BARROWS PROPERTY.		
		NI		
	DESCRIPTIO			40
Style French Colonial	DESCRIPTIO Exterior Plan Recta	ngular	Number of Stone	§ 3
Extenor Fabric(s) 1. Drop siding	DESCRIPTIO Exterior Plan Recta 2. Glazed masons	ngular Y	Number of Stone	3
Exterior Fabric(s) 1. <u>Drop siding</u> Roof Type(s) 1. <u>Gable</u>	DESCRIPTIO Exterior Plan Recta 2. Glazed masons 2.	ngular Y	Number of Stone 3. 3.	3
Roof Type(s) Roof Material(s) Roof Secondary strucs. (dormers etc.) 1. Gable dormer	DESCRIPTIO Exterior Plan Recta 2. Glazed masonr 2 2 er	ngular Y	Number of Stone 3. 3.	3
Roof Type(s) 1. Drop siding Roof Type(s) 1. Gable Roof Material(s) 1. Wood shingles	DESCRIPTIO Exterior Plan Recta 2. Glazed masonr 2 2 er	ngular Y	Number of Stone 3. 3.	3
Exterior Fabric(s) 1. Drop siding Roof Type(s) 1. Gable Roof Material(s) 1. Wood shingles Roof secondary strucs. (dormers etc.) 1. Gable dormer Windows (types, materials, etc.) TRIPLE HUNG SASH; WOOD	Exterior Plan Recta 2. Glazed masonr 2. 2. 2. er MULTI-PANE	ngular Y 2.	Number of Stone 3. 3. 3.	
Roof Type(s) Roof Material(s) Roof Secondary strucs. (dormers etc.) 1. Gable dormer	Exterior Plan Recta 2. Glazed masonr 2. 2. 2. er MULTI-PANE	ngular Y 2.	Number of Stone 3. 3.	
Exterior Fabric(s) 1. Drop siding Roof Type(s) 1. Gable Roof Material(s) 1. Wood shingles Roof secondary strucs. (dormers etc.) 1. Gable dormer Windows (types, materials, etc.) TRIPLE HUNG SASH; WOOD	Exterior Plan Recta 2. Glazed masonr 2. 2. 2. er MULTI-PANE	ngular Y 2.	Number of Stone 3. 3. 3.	
Roof Type(s) 1. Gable Roof Material(s) Roof Secondary Strucs. (dormers etc.) Windows (types, materials, etc.) TRIPLE HUNG SASH; WOOD Distinguishing Architectural Features (exterior or interior ornamer	Exterior Plan Recta 2. Glazed masonr 2. 2. 2. er D MULTI-PANE	ngular Y 2.	Number of Stone 3. 3. 3. 3. PLY CURVED TURNED COLUMN	5
Exterior Fabric(s) 1. Drop siding Roof Type(s) 1. Gable Roof Material(s) 1. Wood shingles Roof secondary strucs. (dormers etc.) 1. Gable dormer Windows (types, materials, etc.) TRIPLE HUNG SASH; WOOD	Exterior Plan Recta 2. Glazed masons 2 2 er D MULTI-PANE nts) TURNED WOOD scape features; use continua	2aALUSTERS, DEE	Number of Stone 3. 3. 3. 3. PLY CURVED TURNED COLUMN: NONE REMAINING, NOW MUSE	S
Roof Type(s) 1. Gable Roof Material(s) Roof Material(s) Roof secondary strucs. (dormers etc.) Windows (types, materials, etc.) TRIPLE HUNG SASH; WOOD Distinguishing Architectural Features (exterior or interior ornamer	Exterior Plan Recta 2. Glazed masons 2 2 er D MULTI-PANE nts) TURNED WOOD scape features; use continua	2aALUSTERS, DEE	Number of Stone 3. 3. 3. 3. PLY CURVED TURNED COLUMN: NONE REMAINING, NOW MUSE	S
Roof Type(s) 1. Gable Roof Material(s) 1. Wood shingles Roof secondary strucs. (dormers etc.) 1. Gable dormer Windows (types, materials, etc.) TRIPLE HUNG SASH; WOOD Distinguishing Architectural Features (exterior or interior ornament Ancillary Features / Outbuildings (record outbuildings, major lands SETTING. ONCE HAD A COMPLEX OF SEVERAL UTILITY	Exterior Plan Recta 2. Glazed masons 2 2 er D MULTI-PANE nts) TURNED WOOD scape features; use continua	2aALUSTERS, DEE	Number of Stone 3. 3. 3. 3. PLY CURVED TURNED COLUMN: NONE REMAINING, NOW MUSE	S
Roof Type(s) 1. Gable Roof Material(s) 1. Wood shingles Roof secondary strucs. (dormers etc.) 1. Gable dormer Windows (types, materials, etc.) Distinguishing Architectural Features (exterior or interior ornament Ancillary Features / Outbuildings (record outbuildings, major lands SETTING. ONCE HAD A COMPLEX OF SEVERAL UTILITY WALKWAY.	Exterior Plan Recta 2. Glazed masonr 2. 2. er D MULTI-PANE Ints) TURNED WOOD scape features; use continua TARIAN BUILDINGS	2. 2. BALUSTERS, DEE!	Number of Stone 3. 3. 3. 9LY CURVED TURNED COLUMN NONE REMAINING, NOW MUSE IGN ATTACHED WITH A RAIS	S
Roof Type(s) 1. Gable Roof Material(s) 1. Wood shingles Roof secondary strucs. (dormer etc.) 1. Gable dormer windows (types, materials, etc.) TRIPLE HUNG SASH; WOOD Distinguishing Architectural Features (exterior or interior ornament Ancillary Features / Outbuildings (record outbuildings, major lands SETTING. ONCE HAD A COMPLEX OF SEVERAL UTILITY WALKWAY.	Exterior Plan Recta 2. Glazed masons 2 2 er D MULTI-PANE nts) TURNED WOOD scape features; use continua	2. 2. BALUSTERS, DEE!	Number of Stone 3. 3. 3. 3. PLY CURVED TURNED COLUMN: NONE REMAINING, NOW MUSE	S
Roof Type(s) 1. Gable Roof Material(s) 1. Wood shingles Roof secondary strucs. (dormer etc.) 1. Gable dormer Windows (types, materials, etc.) Distinguishing Architectural Features (exterior or interior ornamer Ancillary Features / Outbuildings (record outbuildings, major lands SETTING. ONCE HAD A COMPLEX OF SEVERAL UTILITY WALKWAY. DHR USE ONLY O NR List Date SHPO - Appears to meet criteria for NR	Exterior Plan Recta 2. Glazed masonr 2. 2. 2. er D MULTI-PANE Ints) TURNED WOOD Scape features; use continua TARIAN BUILDINGS OFFICIAL EVALUA R listing: Uyes □no	2. 2. BALUSTERS, DEE!	Number of Storie 3. 3. 3. 3. PLY CURVED TURNED COLUMN: NONE REMAINING, NOW MUSE IGN ATTACHED WITH A RAIS DHR USE ONLY Date	S UM ED
Roof Type(s) 1. Gable Roof Material(s) 1. Wood shingles Roof secondary strucs. (dormer etc.) 1. Gable dormer windows (types, materials, etc.) Distinguishing Architectural Features (exterior or interior ornamer and another secondary strucs) Ancillary Features / Outbuildings (record outbuildings, major lands setting. Once had a complex of several utility walkway.	Exterior Plan Recta 2. Glazed masonr 2 2 er D MULTI-PANE Ints) TURNED WOOD Scape features; use continue TARIAN BUILDINGS OFFICIAL EVALUA R listing:yesno	2. BALUSTERS, DEE! Stion sheet if needed.) OF SIMILAR DES	Number of Stone 3. 3. 3. 3. PLY CURVED TURNED COLUMN: NONE REMAINING, NOW MUSE IGN ATTACHED WITH A RAIS DHR USE ONLY Date	S UM ED

HISTORICAL STRUCTURE FORM

Site #8 ES00128


	DESCRIPT	ON (continued)	
Chimney: No. 4 Chimney Material(s): 1.	Brick	2	
Structural System(s): 1. Braced wood	frame 2 B	rick	3. Masonry - General
Foundation Type(s): 1. Continuous			
Foundation Material(s): 1. Brick		tucco	
Main Entrance (stylistic details) MULTI PANE			
Porch Descriptions (types, locations, roof types, etc.) THREE OPEN PORCHES	S AND TWO INCISED PORCHES.	SOUTH, EAST AND WEST
FACADES. APRON PORCH ON WEST; WRA	P AROUND PORCH TO SO	UTH, INCISED PORCH ON EAST	•
Condition (overall resource condition): excellent			THE MUTE ALTERIATED TO DESIGN
Narrative Description of ResourceRARE_E: VALLEY. MIGHT ALSO BE IDENTIFIED R			
HOUSE OF THIS PERIOD.	AS AN AMERICAN COTTAC	GE BECASUE OF THE CENTER H	ALLWAY, UNUSUAL IN A CREOLE
Archaeological Remains JUDY BENSE OF U	WE EYCAVATED AN HIST	ARCH LOG CARIN SITE ON	THE Chack if Archaeological Form Completed
Alchaeological Nemanis GODY BENSE OF C	MI BACAVAIBD AN MIDI	. ARCH. DOG CAPIN DITE ON	
RI	ESEARCH METH	ODS (check all that apply)	
☑FMSF record search (sites/surveys)	⊠library research	☐ building permits	⊠Sanborn maps
☑FL State Archives/photo collection	☐ city directory	☐ occupant/owner interview ☐ neighbor interview	⊠plat maps □Public Lands Survey (DEP)
□ property appraiser / tax records □ cultural resource survey (CRAS)	□ newspaper files □ historic photos	☑ interior inspection	☐HABS/HAER record search
ther methods (describe)	Musicine buotos	Militerior inspection	HIADO/IIALINTecold Sealch
Bibliographic References (give FMSF manuscript	# if relevant use continuation sho	set if needed)	·
District the residence of the the mendoune	ii ii rotorani, aco contanadon en		
OP	INION OF RESOU	JRCE SIGNIFICANCE	
A	Outlandividual califolisate		ifficient information
Appears to meet the criteria for National Reg Appears to meet the criteria for National Reg			ifficient information
Explanation of Evaluation (required, whether sign			
SIGNIFICANT FOR HISTORIC AND ARCH.		" Heeded/ COLD REPAIREMENT OF COL	TOTAL CARDEN TOTAL TOTAL TOTAL
DIGHTICAL TON MIDIONIO 1210 FARON.			
Area(s) of Historical Significance (see National i	Register Bulletin 15, p. 8 for categ	ories: e.g. "architecture", "ethnic heritage",	"community planning & development", etc.)
1. Architecture			munity planning & development
2. Ethnic heritage	4. Local	6	
	DOCUME	ENTATION	
Accessible Documentation Not Filed with the	Cito Eilo includios sold actor		an ordent documents
Accessible Documentation Not Filed with the Approximation Processing Document type Field maps	Site File - including field flotes	, analysis notes, photos, plans and other in Maintaining organization Historic Pensac	riportant documents cola Preservation Board
1) Document description SANBORN MAPS; LOCAL		File or accession #'s BY ADDRESS	
		Maintaining organization Historic Pensac	rola Preservation Board
2) Document type Photographs Document description PHOTO FILES BY ADDR	<u>'</u>	File or accession #'s BY ADDRESS	Sura Friesel Vacion Board
Document description		THE 01 0000033011 #73	
	RECORDER I	NFORMATION	
*** I. A. 1800			_
Recorder Name DR. DIANA GODWIN		Affiliation University of Cer	ntral FL
Recorder Contact Information	VEGAS TRAIL, NAVARRE	, FL (850)939~3001	
farmings i known in inch in a tright			

Required Attachments

- USGS 7.5' MAP WITH STRUCTURE LOCATION PINPOINTED IN RED
- LARGE SCALE STREET, PLAT OR PARCEL MAP (available from most property appraiser web sites):

⑤ PHOTO OF MAIN FACADE, ARCHIVAL B&W PRINT <u>OR</u> DIGITAL IMAGE FILE If submitting an image file, it must be included on disk or CD <u>AND</u> in hard copy format (plain paper is acceptable). Digital image must be at least 1600 x 1200 pixels, 24-bit color, jpeg or tiff.

410 S. Florida Blanca

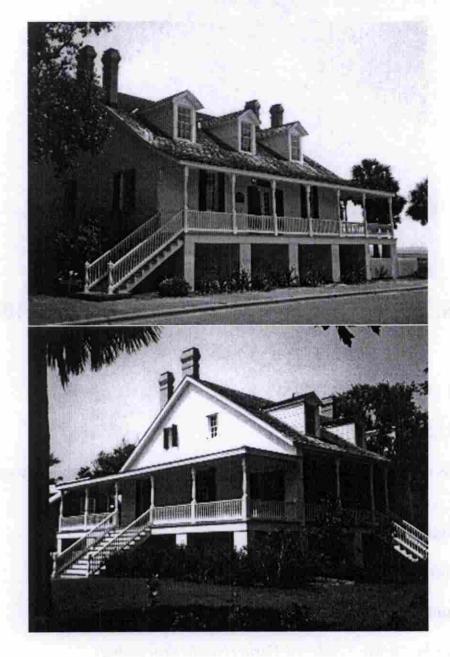

410 S. Florida Blanca Street








Architectural Review Board Application Full Board Review

	Αŗ	oplication Date: 5/23/2023
Project Address:	410 South Florida Blanca Street	Pensacola, FL 32502
Applicant:	Carter Quina	
Applicant's Address:	400 West Romana Street Pensaco	la, FL 32502
Email:	CQUINA@QGARCHITECTS.COM	Phone: 850-433-5575
Property Owner:	UWF Historic Trust	
District:	PHD NHPD OEHPE	rom Applicant) PHBD GCD
Residential Hon Commercial/Ot	ade for the project as described herein: nestead – \$50.00 hearing fee her Residential – \$250.00 hearing fee	ytoriala hava haan subsetti da
deemed complete by th	e scheduled to be heard once all required mo e Secretary to the Board. You will need to in Please see pages 3 – 4 of this application for	nclude ten (10) copies of the
Project specifics/descrip		
Installation of accessi	ble ramp.	
that no refund of these j	cant, understand that payment of these fees fees will be made. I have reviewed the appl the present on the date of the Architectural F	icable zonina requirements and
		5/23/2023
*Applicar	nt Signature	Date
	Diameter Committee	

Planning Services 222 W. Main Street * Pensacola, Florida 32502 (850) 435-1670 Mail to: P.O. Box 12910 * Pensacola, Florida 32521

Barkley House Accessible Ramp Addition University of West Florida Historic Truste 410 S Florida Blanca Street

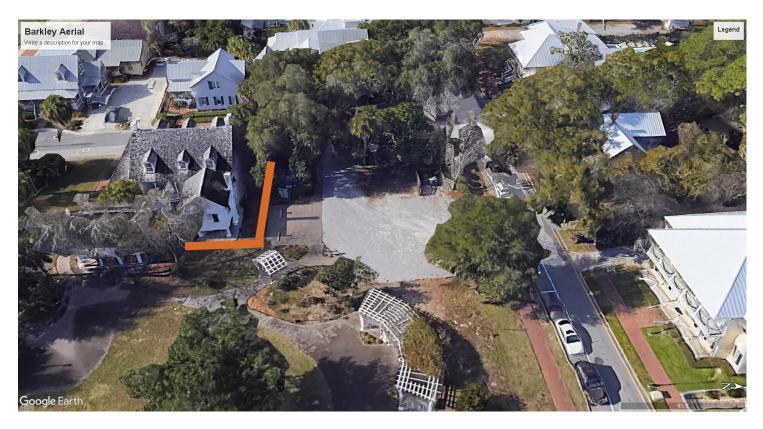

Aerial view of Barkley House from the east. The proposed new accessible ramp will be placed north and east of the existing Kitchen which was added to the Barkley House in 2008 to accommodate Restrooms. Zarraggossa Street is to the right and S Florida Blanca Street is beyond.



View of S Florida Blanca Elevation. The new ramp will be located beyond the stair shown on the left. The existing oak tree will remain.




View of the South Elevation. The proposed ramp will have no effect on this primary view.





View of the north elevation of the Kitchen and the Barkley House.



View of the east elevation of the Kitchen used for Restrooms.

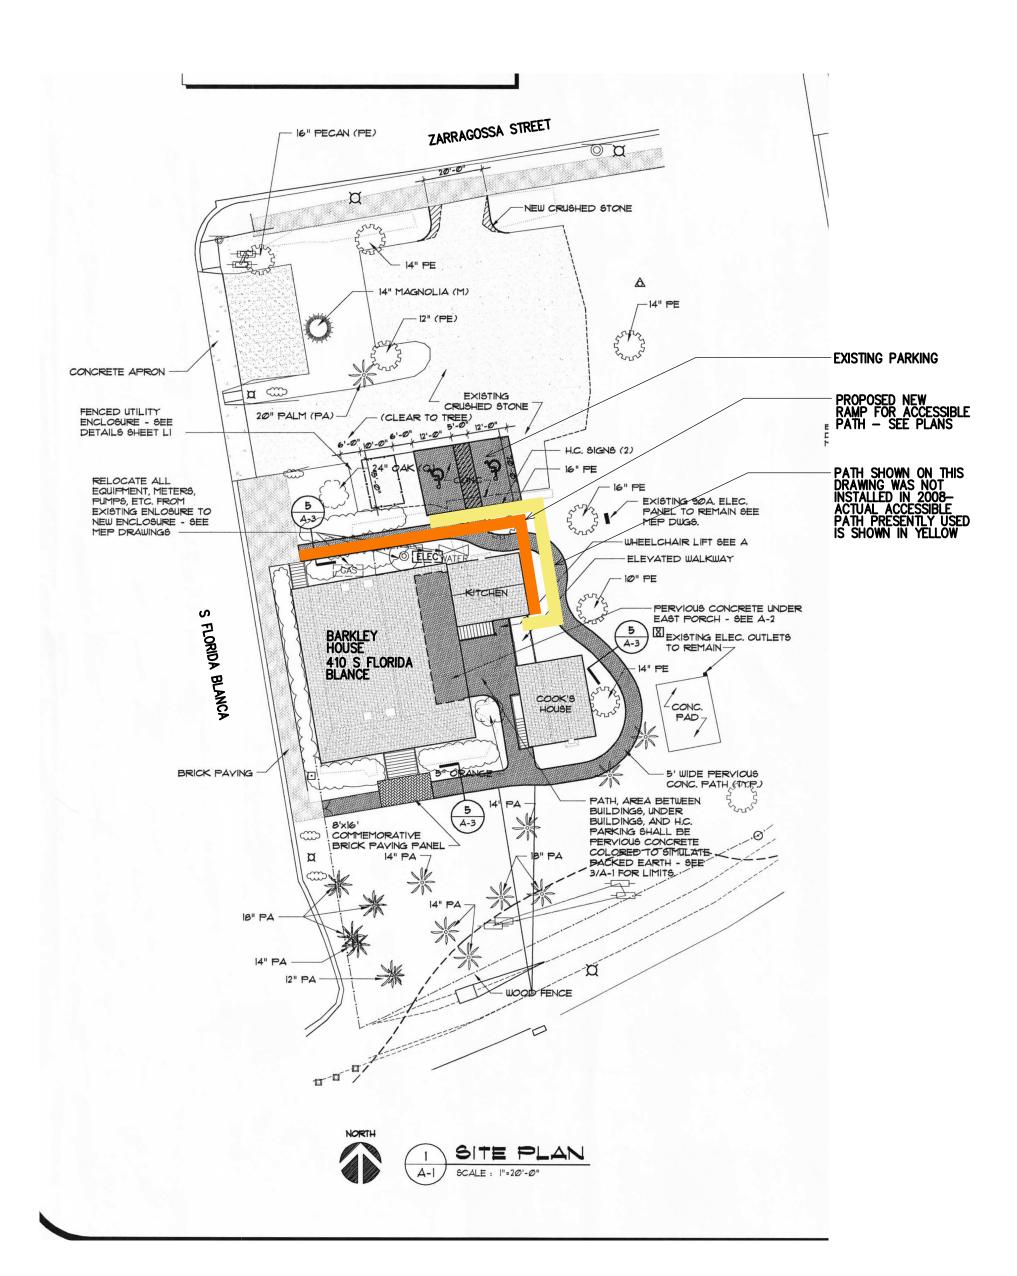

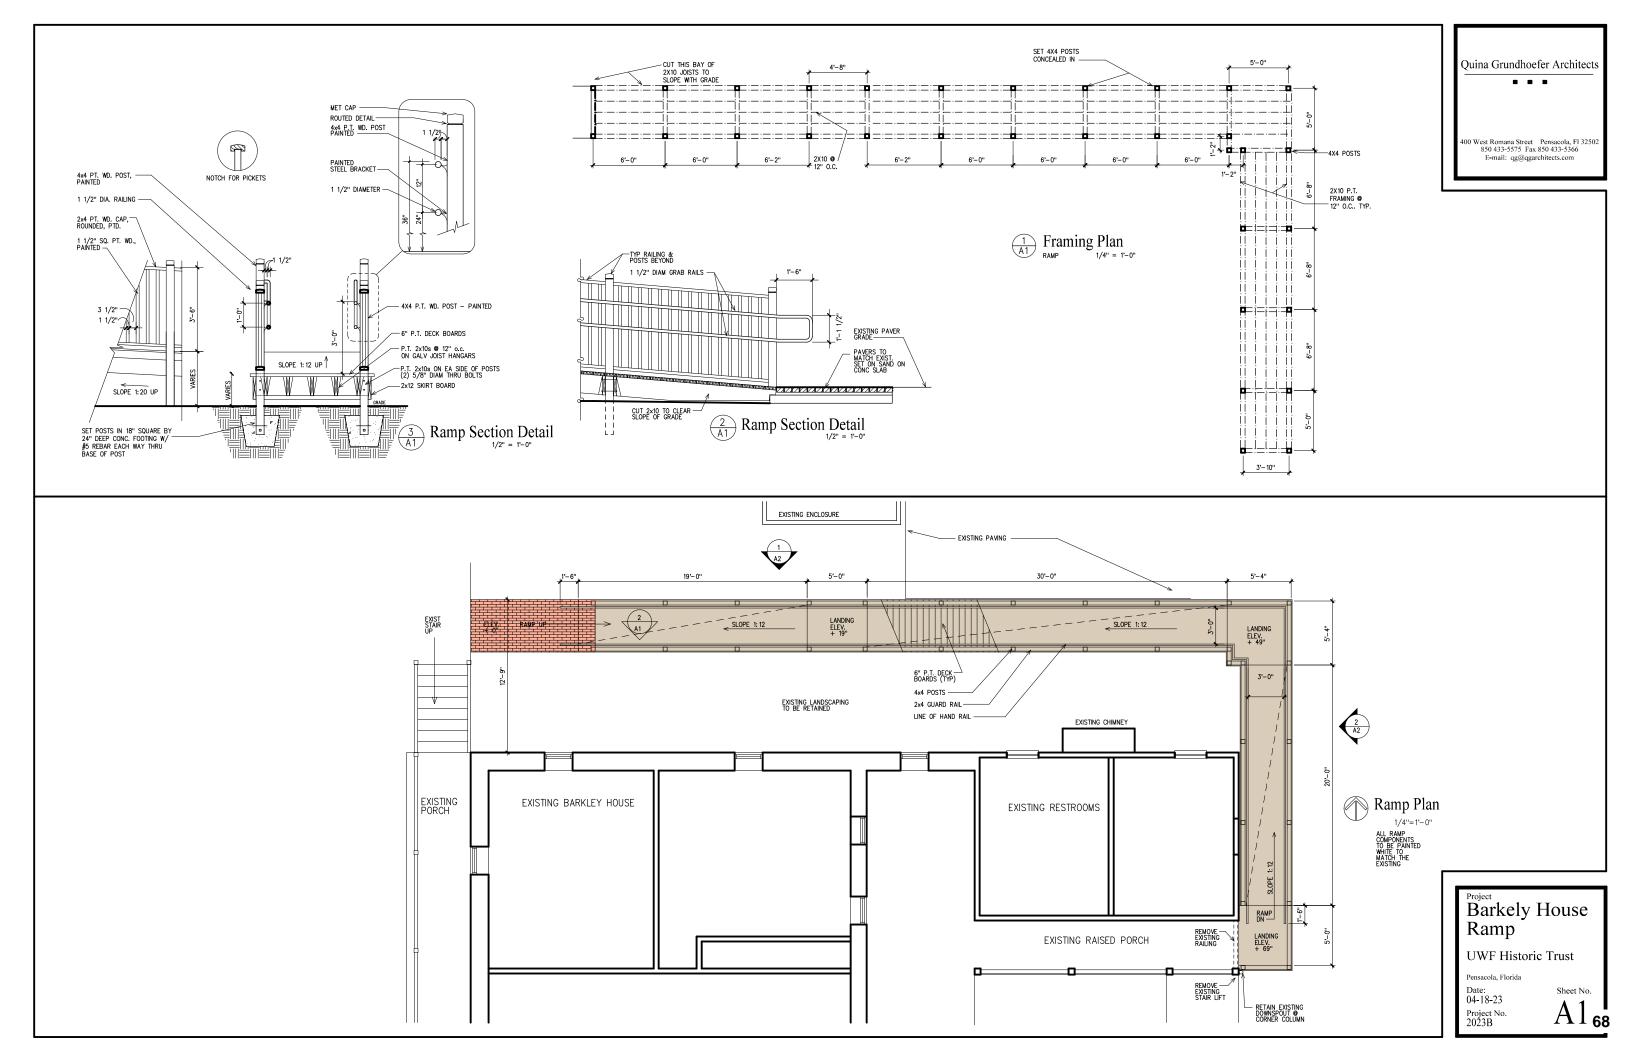

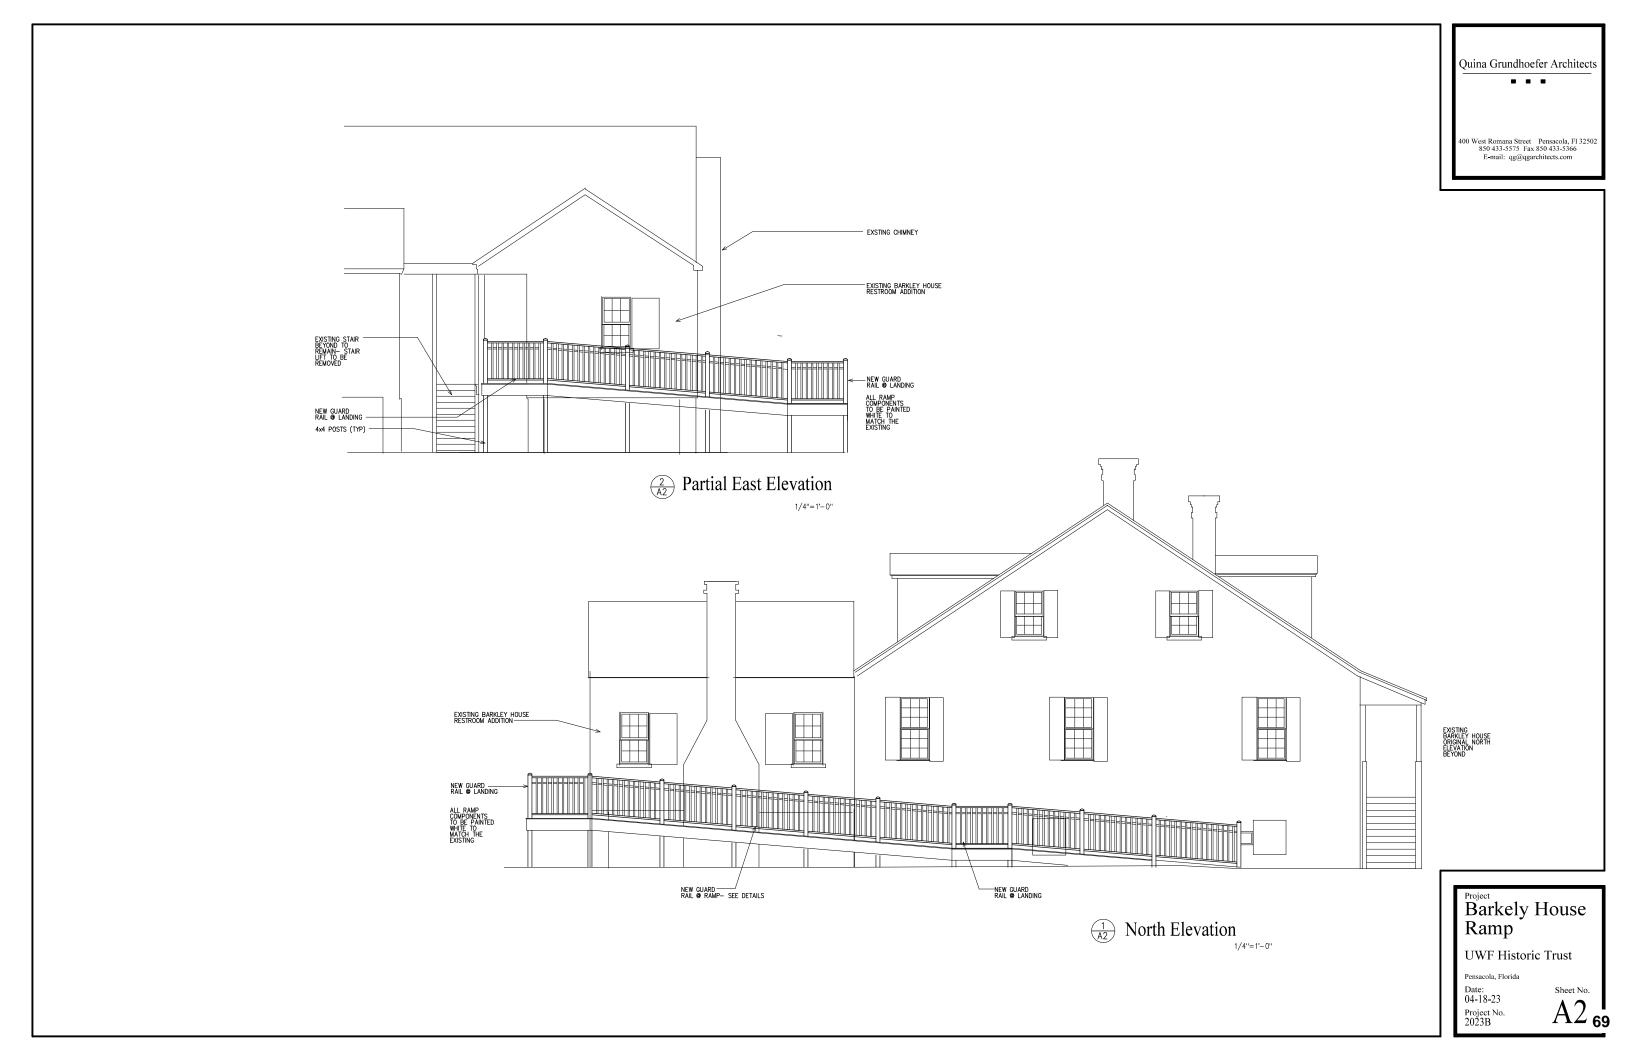

Waddell (Brand Rating: 4.2/5) (i)

4 in. x 4 in. Black Pyramid Post Cap with Pine Base

**** (5) V Questions & Answers (4)













City of Pensacola

Memorandum

File #: 23-00463 Architectural Review Board 6/15/2023

TO: Architectural Review Board Members

FROM: Adrianne Walker, Cultural Resources Coordinator

DATE: 6/8/2023

SUBJECT:

29 S. DeVilliers Street
Governmental Center District / Zone C-2 / City Council District 7
Addition to an Existing Structure

BACKGROUND:

Carter Quina is seeking approval for a 280-sf. addition to an existing structure. The proposed addition will match an existing addition including a galvanized corrugated metal roof, matching wood shutters, 30-inch exposure cedar shingle siding painted to match, new masonry piers with painted stucco and painted metal crawl spaces to match, two existing windows will be relocated, and one, new single hung wood window with true divided lite will be installed.

Please find attached all relevant documentation for your review.

RECOMMENDED CODE SECTIONS

Sec. 12-3-28(b) Governmental Center District, Procedure for review of plans

Sec. 12-3-28(c) Governmental Center District, Decisions

29 S. DeVilliers Street







Architectural Review Board Application Full Board Review

				Applica	ation Date: <u>3/23/2023</u>
Project Address:	29 South	DeVilliers Str	eet	Pensacol	la, FL 32502
Applicant:	Carter Quina				
Applicant's Address:	400 West Romana Street Pensacola, FL 32502				
Email:	CQUINA@QGARCHITECTS.COM Phone: 850-433-5575				
Property Owner:	Quina Group Ltd.				
	√ PHD	NHPD	(If	different from A	Applicant) PHBD GCD
Commercial/Ot	her Residenti e scheduled to e Secretary to Please see pag ption:	the Board. You	ll req will n	uired materioneed to includ	

that no refund of these understand that I must	fees will be m	nade. I have revie	wed	the applicab	es not entitle me to approval and le zoning requirements and ew Board meeting. 3/23/2023
Applica	nt Signature				Date

Planning Services
222 W. Main Street * Pensacola, Florida 32502
(850) 435-1670
Mail to: P.O. Box 12910 * Pensacola, Florida 32521

Addition of the Casita 29 S DeVilliers Street



Aerial view of 29 S DeVilliers showing Architects office to the left and office building to the right. Pink shows approximate location of the addition.



Existing street view from DeVilliers.



Photo to the left shows the existing 2002 addition to the original Railroad Flat. The recessed entry divides the old and new.



Photo to the left shows the existing condition and the rendering below shows the new addition to the 2002 addition. All the materials and details of the 2023 addition will match the 2002 materials. Two existing windows will be relocated and one new window will be installed.













12 ft. Corrugated Galvanized Steel 29-Gauge Roof Panel

New window to be Marvin wood true divided lite with impact glass, single hung. Wood shutters to match existing.

New roof to be galvanized, corrugated metal matching the existing roof.

New siding to be 30" exposure cedar shakes, painted to match existing.

Multiple design options and woods available to match historical aesthetics and design requirements

Hung

accuracy.

 Fits openings up to 4 feet wide by 8 feet high

Ultimate Wood Single

The Ultimate Wood Single Hung window is a classic style with an operating bottom sash and stationary top sash. Flexible design options like wood species and stains assist with historical

 Also available as a round top, single hung, stationary transom, or picture window

Find Marvin products in your area and request a price quote. Connect with a dealer near you to get started.






36" Images © 2006-2023 Custom Shingles

36" Handsplit Shakes

Shakes are a more rustic alternative to shingles that are notable for having one hand-split face. This gives them the rough outer appearance characteristic of traditional ranch homes, but suitable for luxury cottages and a wide range of other applications. Unlike shingles, their irregular sizing requires the use of a felt interlay for weather and moisture resistance.


Custom Shingles manufactures a 36" Cedar shake for use on heritage properties and other specialized projects. Longer than our standard shake, it offers a wide range of possibilities for customization while still delivering the quality you expect from our products.


Addition to The Casita 29 S DeVilliers

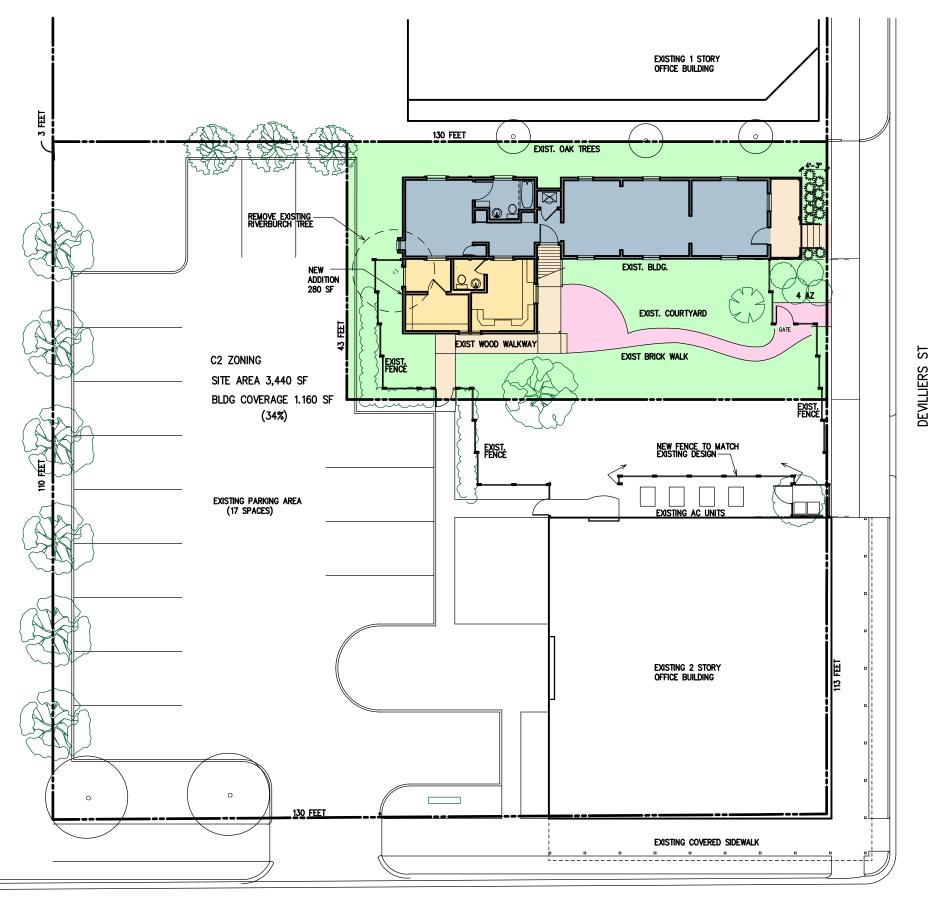

W ROMANA ST.



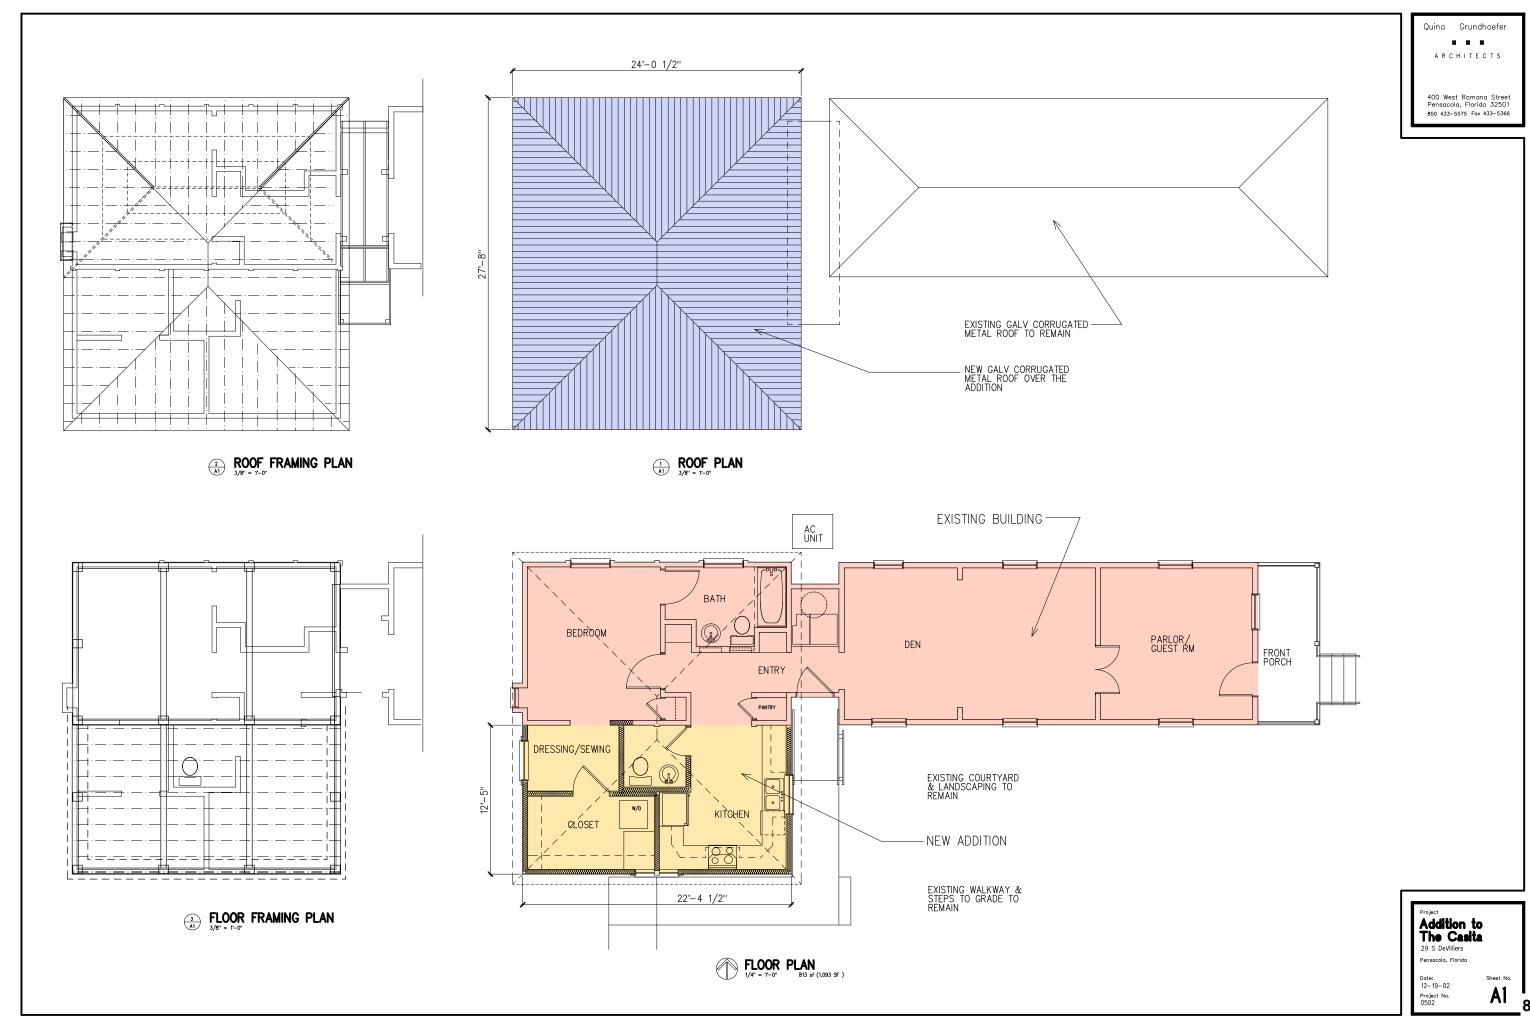

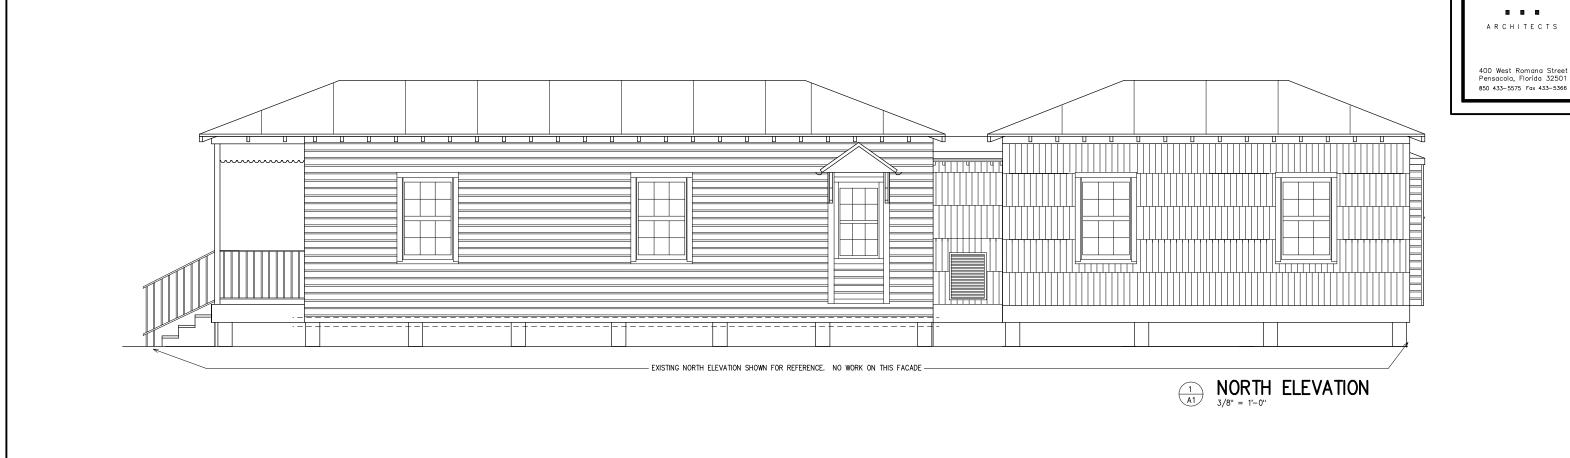



SOUTH ELEVATION

3/8" = 1'-0"

1 2-17-03 GENERAL




Pensacola, Floric

Date: 12—19—02 Project No. 0502

Sheet No.

Quina Grundhoefer

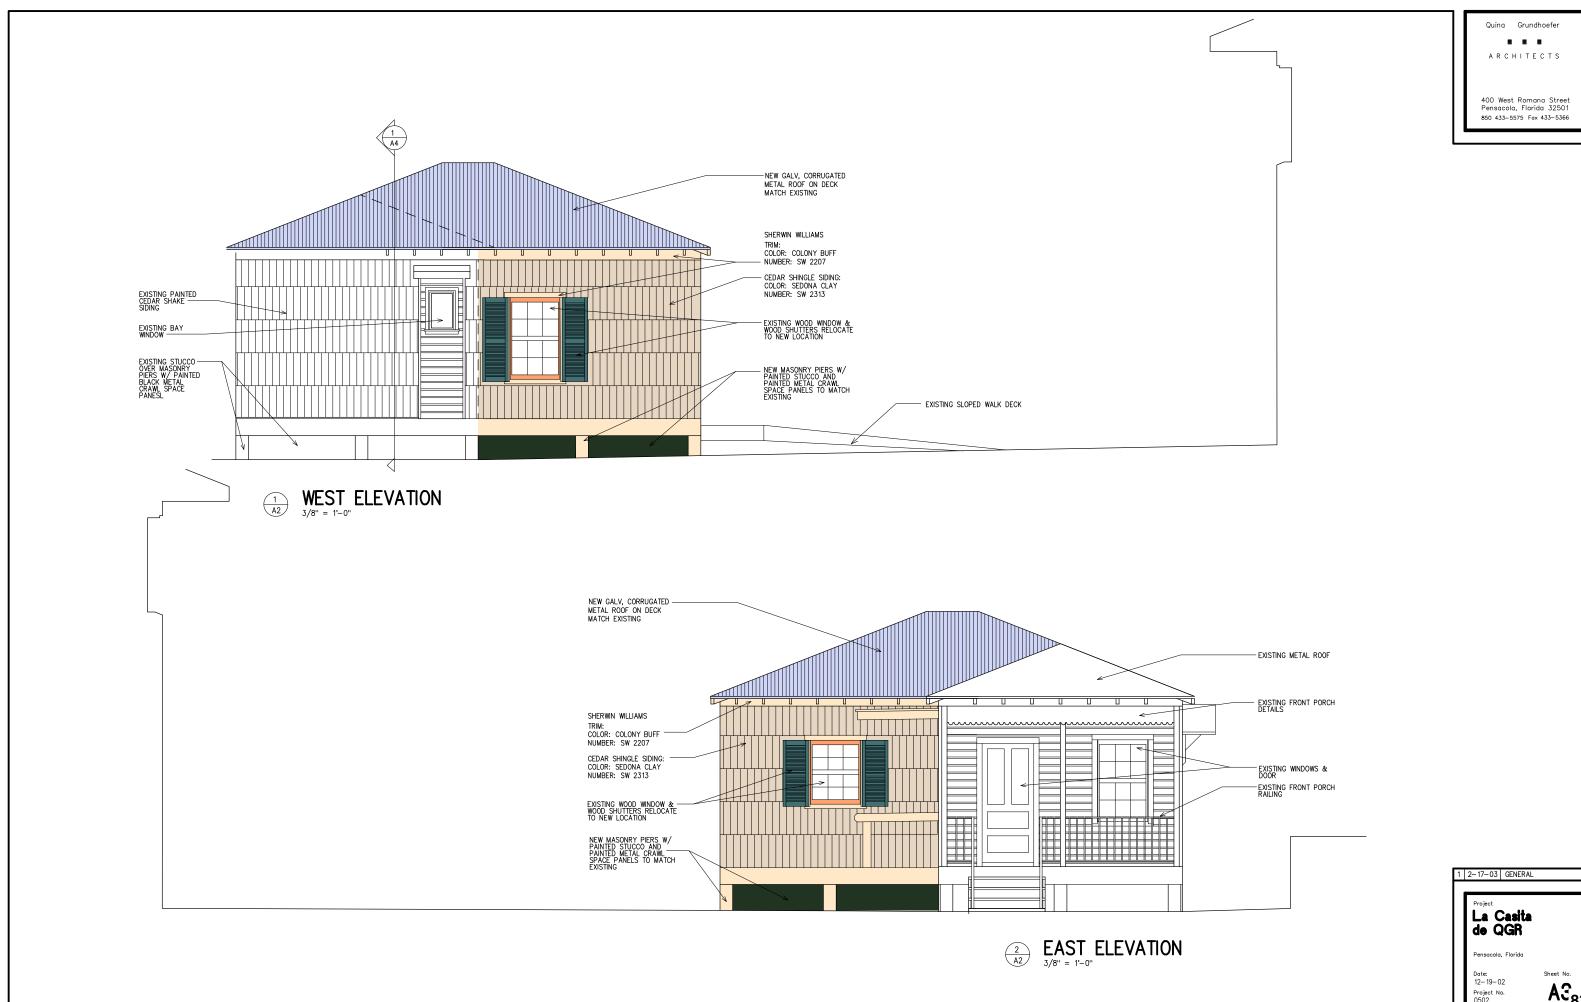

A383



City of Pensacola

Memorandum

File #: 23-00472 Architectural Review Board 6/15/2023

TO: Architectural Review Board Members

FROM: Adrianne Walker, Cultural Resources Coordinator

DATE: 6/9/2023

SUBJECT:

101 E. Romana Street
Palafox Historic Business District / Zone C-2 & C-2A / City Council District 6
Change of Paint at a Non-Contributing Structure

BACKGROUND:

David Hunt is requesting approval to change the exterior paint colors at 101 E. Romana Street. The scope includes using Sherwin Williams products to paint the upper body of the structure in Whitetail, the lower body in Keystone Grey, the wall cap and corbels in Enduring Bronze, and the railings in Tricorn Black. An abbreviated review application for this project was referred to the full board in June 2023.

Please find attached all relevant documentation for your review.

RECOMMENDED CODE SECTIONS

Sec. 12-3-27(e)(3) PHBD, Procedure for review and submission of development plan, Review and approval by the architectural review board.

Sec. 12-3-27(f)(1) PHBD, Architectural review of proposed exterior development, General considerations.

101 E. Romana Street







Architectural Review Board Application Abbreviated Review

				Applic.	ation C	_{late:} <u>5/3</u>	30/23	<u> </u>	
Project Address:	101 E Romana St. Pensacola, Fl. 32502								
Applicant:	David Hunt as agent for the Owner								
Applicant's Address	101 E Romana St, Pensacola, FL 32502								
Email:	david.hunt@LiveBH.com Phone: 678.859.5501			501					
Property Owner:	Pensacola Southtowne Owner LLC 67% Int Beaumont Pensacola Southtowne Owner LLC 30% Int				LLC 30% Int				
District:	PHO	Z NHF		OEHPD	Apskai]	PHBD]	GCD 🔲	
There is a \$25 Applicatio	on Fee for th	e following pr	oject type:	35					
Change of Paint Color(s) New/Replacement Sign(s) Minor Deviation to an Approved Project / Change of Roofing Material / Fence Solar Panels		Body: Trim: Accent:	Doors:	Whitetai Enduring ne Grey				e Grey orn Black	
		Sign Type: All Sherwin Williams Dimensions: Doors and railings will be Tricom Black to match existing							
		Colors: Descriptions:	3						
		(0	Office Use)						
This request was reviewed ARB Secretory Sig	n) when	he criteria for a	n Abbrevia	ed Review.	_	5/31/20	023		
This request was reviewe	d and appro	ved by the follo	wing memb	ers of the Ard	chitecti	ıral Review	Board:		
Jd y	6/7/23		Co	mments:	New (colors ar	ге арр	roved	
Architect Signatu	ire / Date		7	A Send	+0 F	FU11-B	ward		
Kn 6-7-23				comments. <u>Need more intermation for all</u> elevations a Scale of project should]/	
UWFH1 Representative Signature / Date				have tell Board Review					

Pianning Services 222 W. Main Street * Pensacolo, Florida 32502 (850) 435-1670 Mail to: P.O. Box 12910 * Pensacolo, Florida 32521



- 1: Wall cap-Enduring Bronze
- 2: Upper Body-Whitetail
- 3: Corbels-Enduring Bronze
- 4: Lower Body-Keystone

Q

Paints & Supplies


Find Color


Project Center


For Pros

Special Offers

SW 7103 Whitetail

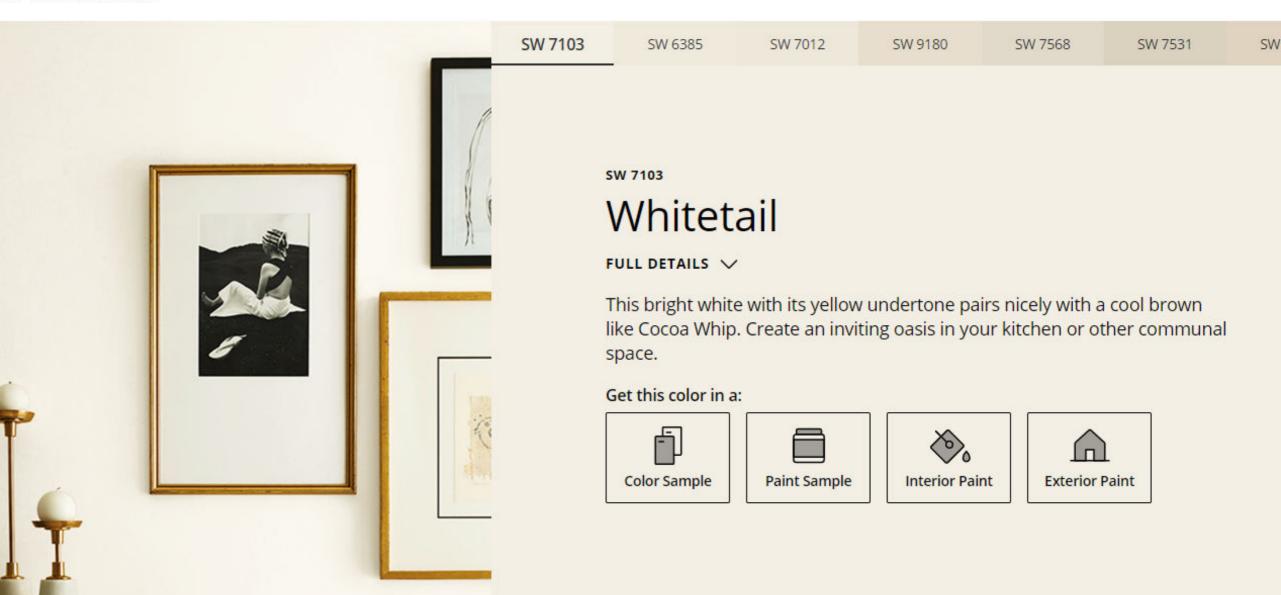

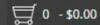

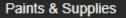

Find Color

SHERWIN-WILLIAMS.

Project Center

For Pros

Special Offers

04 Keystone Gray



SW 7029

SW 7030

SW 7031

SW 7504

Q

SW 7032

SW 7033

SW 7034

SW 7504

Keystone Gray

FULL DETAILS V

This warm stone gray welcomes you into its snug embrace. Consider this warm neutral as a solid, inviting choice for living rooms and bathrooms.

Get this color in a:












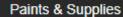

Find Color

SHERWIN-WILLIAMS.

Project Center

For Pros

Special Offers

SW 7055 Enduring Bronze



SW 7050

SW 7051

SW 7052

SW 9172

Q

SW 7053

SW 7054

SW 7055

SW 7055

Enduring Bronze

FULL DETAILS 🗸

Get this color in a:



Color Sample



Paint Sample



Interior Paint







Paints & Supplies

Find Color

Project Center

For Pros

Special Offers

SW 6258 Tricorn Black



SW 6258

SW 6990

SW 6991

SW 6992

SW 6993

SW 6994

SW 7069

Expert Pick

SW 6258

Tricorn Black

FULL DETAILS V

Smarten up your space with this trendy, never-boring black. Pair it with white for a classic contrast. Since it's a true black, it works with any undertone.

Get this color in a:



Color Sample



Paint Sample




Interior Paint



Exterior Paint

SHERWIN-WILLIAMS.

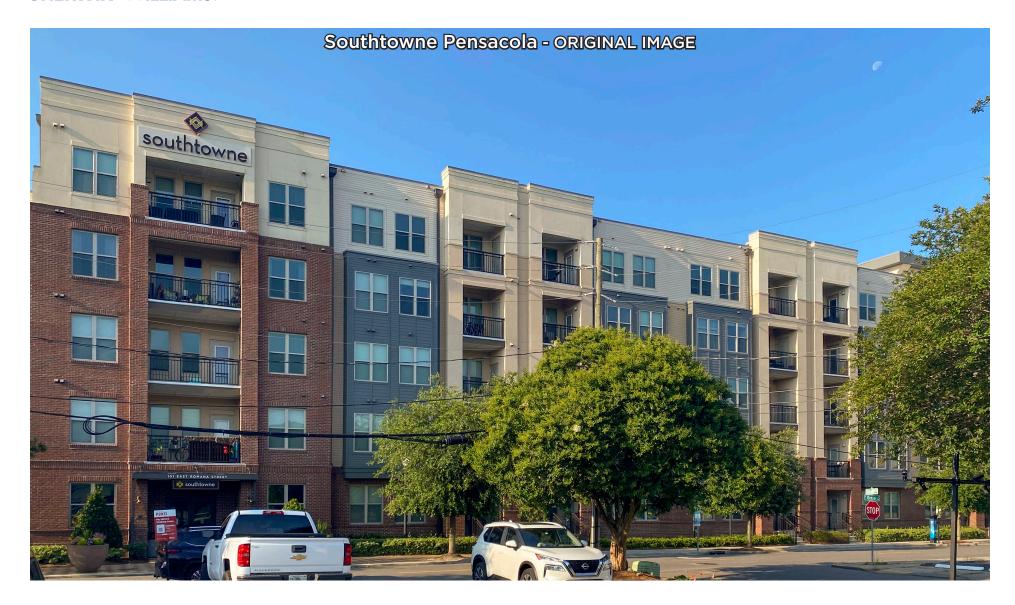

Madison Woods

(850) 530-7307 • Madison.M.Woods@sherwin.com



SW 7103 White Tail

Upper Body 1

SW 7504 Keystone Grray SW 7055 Enduring Bronze

SW 6258 Tricorn Black

Lower Body 2

Doors, Top Trim Metal Railing, Fence

SHERWIN-WILLIAMS.



Madison Woods

(850) 530-7307 • Madison.M.Woods@sherwin.com



SW 7103 White Tail

Upper Body 1, Stucco Lower Body 2

SW 7504 Keystone Grray

SW 7055
Enduring Bronze
Doors, Top Trim

SW 6258 Tricorn Black

Metal Railing, Fence, Corbel

SHERWIN-WILLIAMS.



Madison Woods

(850) 530-7307 • Madison.M.Woods@sherwin.com



SW 7103 White Tail

Upper Body 1

SW 7504 Keystone Grray SW 7055 Enduring Bronze


Doors, Top Trim

SW 6258 Tricorn Black

Lower Body 2


Metal Railing, Fence

SHERWIN-WILLIAMS.

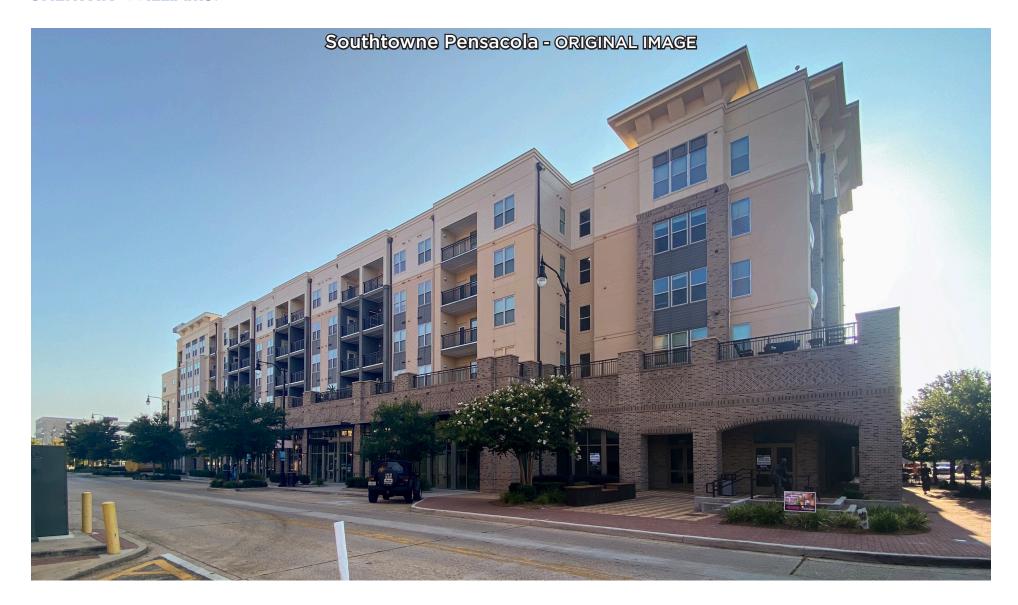

Madison Woods

(850) 530-7307 • Madison.M.Woods@sherwin.com

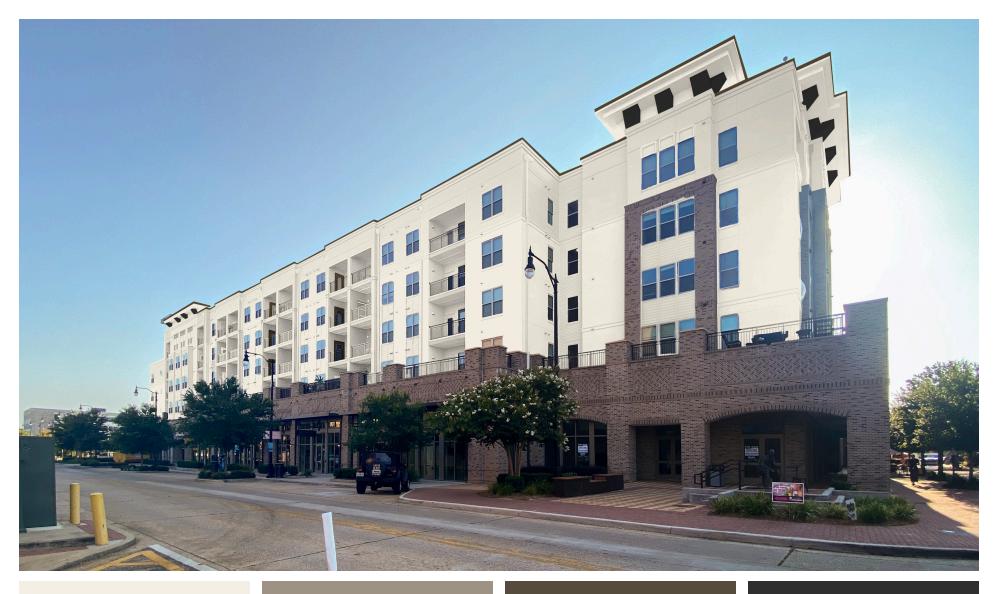

SW 7103 White Tail

Upper Body 1, Stucco Lower Body 2

SW 7504

Keystone Grray

SW 7055
Enduring Bronze
Doors, Top Trim

SW 6258 Tricorn Black

im Metal Railing, Fence, Corbel



City of Pensacola

Memorandum

File #: 23-00464 Architectural Review Board 6/15/2023

TO: Architectural Review Board Members

FROM: Adrianne Walker, Cultural Resources Coordinator

DATE: 6/8/2023

SUBJECT:

811 E. Belmont Street Old East Hill Preservation District / Zone OEHC-2 / City Council District 6 Exterior Renovation on a Contributing Structure

BACKGROUND:

Jordan Yee is seeking approval to renovate a vacant duplex that is a contributing structure in Old East Hill. The project includes painting the exterior, removing and replacing an addition on the rear, replacing the existing asbestos tile siding with wood lap siding, addition of four new window openings, a new front door opening, a smooth 5v-crimp metal roof, and all new windows and doors. The proposed front windows are aluminum clad single hung, the side windows are vinyl single hung, the proposed front door is wood, and the rear doors are vinyl.

Please find attached all relevant documentation for your review.

RECOMMENDED CODE SECTIONS

Sec. 12-3-10(3)e.3. OEHPD; Procedure for review of plans; Decisions.

Sec. 12-3-10(3)g. OEHPD; Restoration, rehabilitation, alterations or additions to existing contributing structures in the Old East Hill preservation district.

HISTORICAL STRUCTURE FORM


Page 1 X original update HISTORICAL STRUCTURE FORM Site 8 ES 02160 Version 1.1: 3/89 Recorder #
Page 1 HISTORICAL STRUCTURE FILE
x original FLURIDA WASTER STEEL Recorder #
update
SITE NAME Alexander Roulhac, House
SITE NAME Alexander Roulhac, House HISTORIC CONTEXTS Spanish American War NAT. REGISTER CATEGORY district
NAT. REGISTER CATEGORY district
NAT. REGISTER CATEGORY OTHER NAMES OR MSF NOS NONE OWNERSHIP TYPE PROJECT NAME West-East Hill Survey: S&R LOCATION (Attach copy of USGS map, sketch-map of immediate area) CITY Pensacola
OTHER NAMES OR MSF NOS NONE OWNERSHIP TYPE private-individual
COUNTY Escambia DHR NO 3225
PROJECT NAME west-mast mill survey map, sketch-map of immediate area)
ADDRESS 811 East Belmont St. CITY Pensacola VICINITY OF / ROUTE TO West-East Hill neighborhood; S. side of E. Belmont
WICINITY OF / ROUTE TO West-East Hill neighborhood; S. side of E. Belmont
St. between N. 8th Ave. and N. 9th Ave. SUBDIVISION New City Tract PLAT OR OTHER MAP county appraisers at las sheet #68 TOWNSHIP 2S RANGE 30W SECTION 22 1/4 1/4-1/4
SUBDIVISION New City Tract BLOCK NO 60 LOT NO 4
PLAT OR OTHER MAP county appraisers atlas sheet #68
TOWNSHIP 2S RANGE 30W SECTION 22 1/4 1/4-1/4
USGS 7.5' MAP
UTM: ZONE EASTING NORTHING D M S
USGS 7.5' MAP UTM: ZONE EASTING NORTHING COORDINATES: LATITUDE D M S LONGITUDE D M S
HISTORY
ARCHITECT: F M L Unknown
HISTORY ARCHITECT: F BUILDER: F CONST DATE 1903 CIRCA C RESTORATION DATE(S):
CONST DATE 1903 CIRCA C RESTORATION DATE(S).
MODIFICATION DATE(S):
ORIGINAL USE(S)
PRESENT USES(S)
DESCRIPTION
STYLE frame vernacular PLAN: EXTERIOR rectangular
NO.: STORIES 1 OUTBLDGS 0 PORCHES 2 DORMERS 0
STRUCTURAL SYSTEM(S) ballon wood framing
TARRESTOR EXPRICACE ashestos sningles
FOUNDATION: TYPE _ pier MATLS _brick
$\frac{1}{1}$ 1/2 $\frac{1}{1}$ 20 $\frac{1}$ 20 $\frac{1}{1}$ 20 $\frac{1}{1}$ 20 $\frac{1}{1}$ 20 $\frac{1}{1}$ 20 $\frac{1}{$
PORCHES n/porch/3 s x4 coldmas 3/4 4 composition shingles POOF: TYPE gable SURFACING composition shingles
ROOF: TYPE gable SURFACING composition sningles SECONDARY STRUCS. shed, gable, porch SECONDARY STRUCS. shed, gable, porch
SECONDARY STRUCS. shed, gable, porch CHIMNEY: NO 2 MTLS brick, brick/plaster LOCNS N:center, ridge; S:center, ridge
WINDOWS dhs, 1/1 wood
EXTERIOR ORNAMENT wood jigsaw cut trim in columns on porch & in porch column cor CONDITION fair SURROUNDINGS residential [decorative corni
EXTERIOR ORNAMENT wood jigsaw cut trim in columns on poten a in poten corni
CONDITION fair SURROUNDINGS residential (decoration)
CONDITION fair SURROUNDINGS TESTGER 1 lines only) NARRATIVE (general, interior, landscape, context; 3 lines only)
NARRATIVE (general, interior, landscape, composition of typical house in size & scale w/surroundings; oaks, pecans
THE PROPERTY OF THE STATE
ARCHAEOLOGICAL REMAINS AT THE SITE FMSF ARCHAEOLOGICAL FORM COMPLETED? _ Y _x n (IF Y, ATTACH)
FMSF ARCHAEOLOGICAL FORM COMPLETED: _ 1 ARTIFACTS OR OTHER REMAINS

RECORDER'S EVALUATION OF SITE AREAS OF SIGNIFICANCE local So	cial History
ELIGIBLE FOR NAT. REGISTER? y n 1 SIGNIF. AS PART OF DISTRICT? xy n 1 SIGNIFICANT AT LOCAL LEVEL? xy n 1 SUMMARY ON SIGNIFICANCE (Limit to three	- THE THE
* * *DHR USE ONLY* * * * * * * * * * * * * * * * * * *	-YES -NO * -YES -NO * * * * * * * * * * * * *
Attach a B/W photographic print here with plastic clip. Label the print itself with at least: the FMSF site number (survey number or site name if not available), direction and date of photograph. Prints larger than contact size are preferable.	I M A P I street/plat map, not USGS I I I I I I I I I I I I I I I I I I

REQUIRED: USGS MAP OR COPY WITH SITE LOCATION MARKED

I



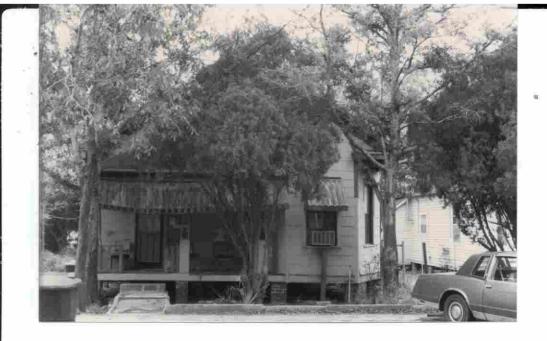

811 E. Belmont Street







Architectural Review Board Application Full Board Review


		Applica	tion Date:	
			Phone:	
operty Owner:				
PHD	NHPD	OEHPD	PHBD	GCD
nestead — \$50.0 ner Residential scheduled to be e Secretary to te lease see page otion: cant, understan fees will be ma	nd that payment that I have review	ng fee I required materia vill need to include polication for furth of these fees doe wed the applicable	e eight (8) copies ner instruction and s not entitle me to e zoning requirem	of the d o approval and nents and
nt Signature			Date	<u> </u>
	PHD ade for the properties of	PHD NHPD ade for the project as described nestead — \$50.00 hearing fee her Residential — \$250.00 hearing scheduled to be heard once all expectatory to the Board. You will lease see pages 3 — 4 of this apportion: Seant, understand that payment fees will be made. I have review the present on the date of the A	(If different from A) PHD NHPD OEHPD adde for the project as described herein: bestead – \$50.00 hearing fee been Residential – \$250.00 hearing fee been scheduled to be heard once all required material effects are pages 3 – 4 of this application for further pation: April 1. Secretary to the Board. You will need to include the see pages 3 – 4 of this application for further pation: April 2. Secretary to the Board once all required material that payment of these fees does the see pages 3 – 4 of this application for further pation: April 2. Secretary to the Board once all required material that payment of these fees does the payment of the see fees does the present on the date of the Architectural Review of the Architec	(If different from Applicant) PHD NHPD OEHPD PHBD ade for the project as described herein: bestead — \$50.00 hearing fee ther Residential — \$250.00 hearing fee be scheduled to be heard once all required materials have been substicted to see a see pages 3 — 4 of this application for further instruction and pation: action: Cant, understand that payment of these fees does not entitle me to be present on the date of the Architectural Review Board meeting and the second meeting a

RENOVATION TO 811 E BELMONT


INDEX OF	INDEX OF DRAWINGS				
SHEET#	DESCRIPTION				
A-1	COVER SHEET				
A-2	FLOOR PLANS				
A-3	EXTERIOR ELEVATIONS				
D-1	DEMOLITION SCOPE				
D-2	EXISTING PHOTOS				




PLACES FOR PEOPLE DESIGN, LLC 1904 E. LEONARD ST PENSACOLA, FL 32503 (850) 380-8020 | AR#96913

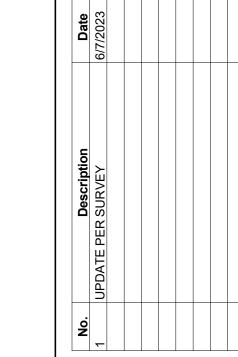

NOT FOR CONSTRUCTION

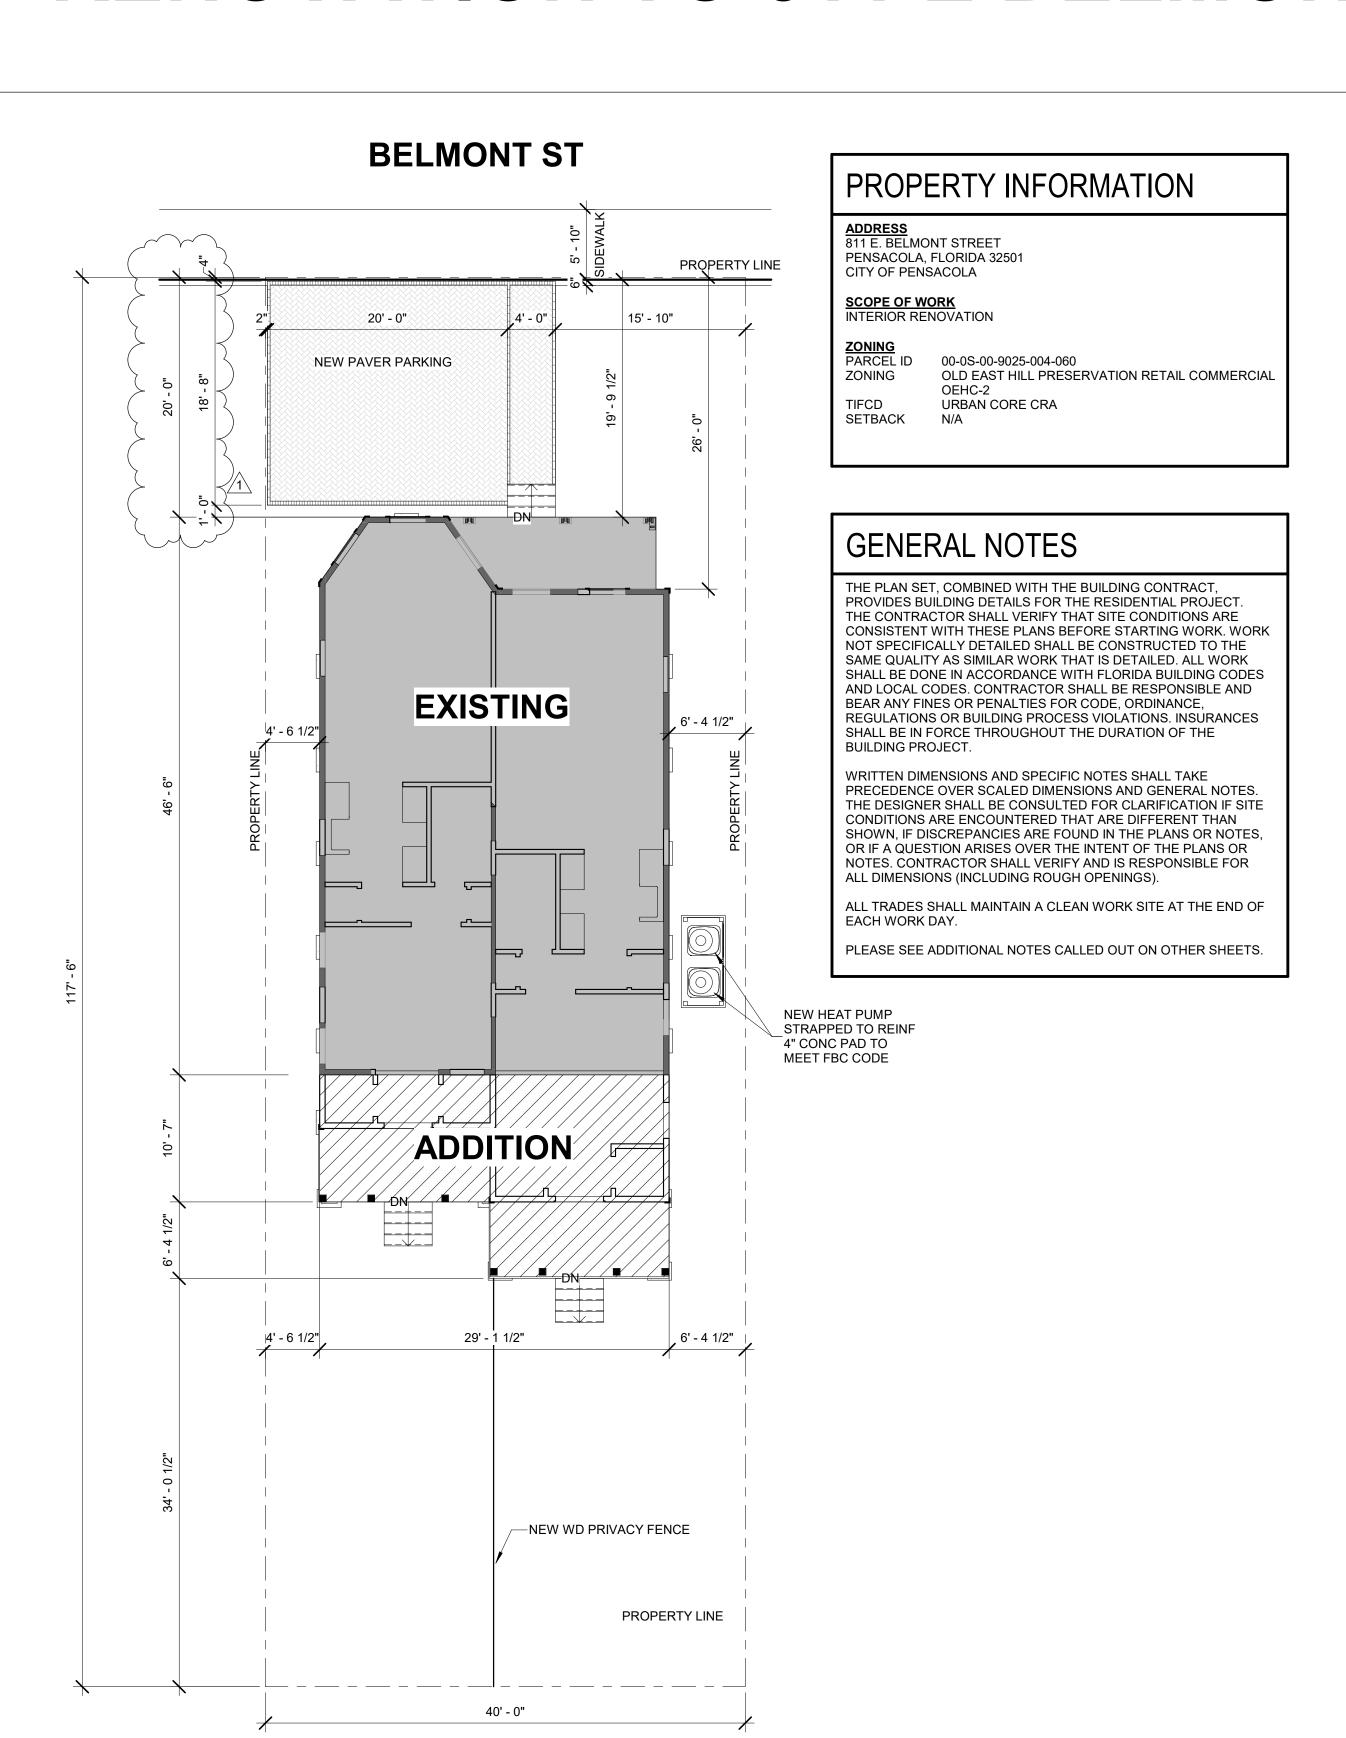

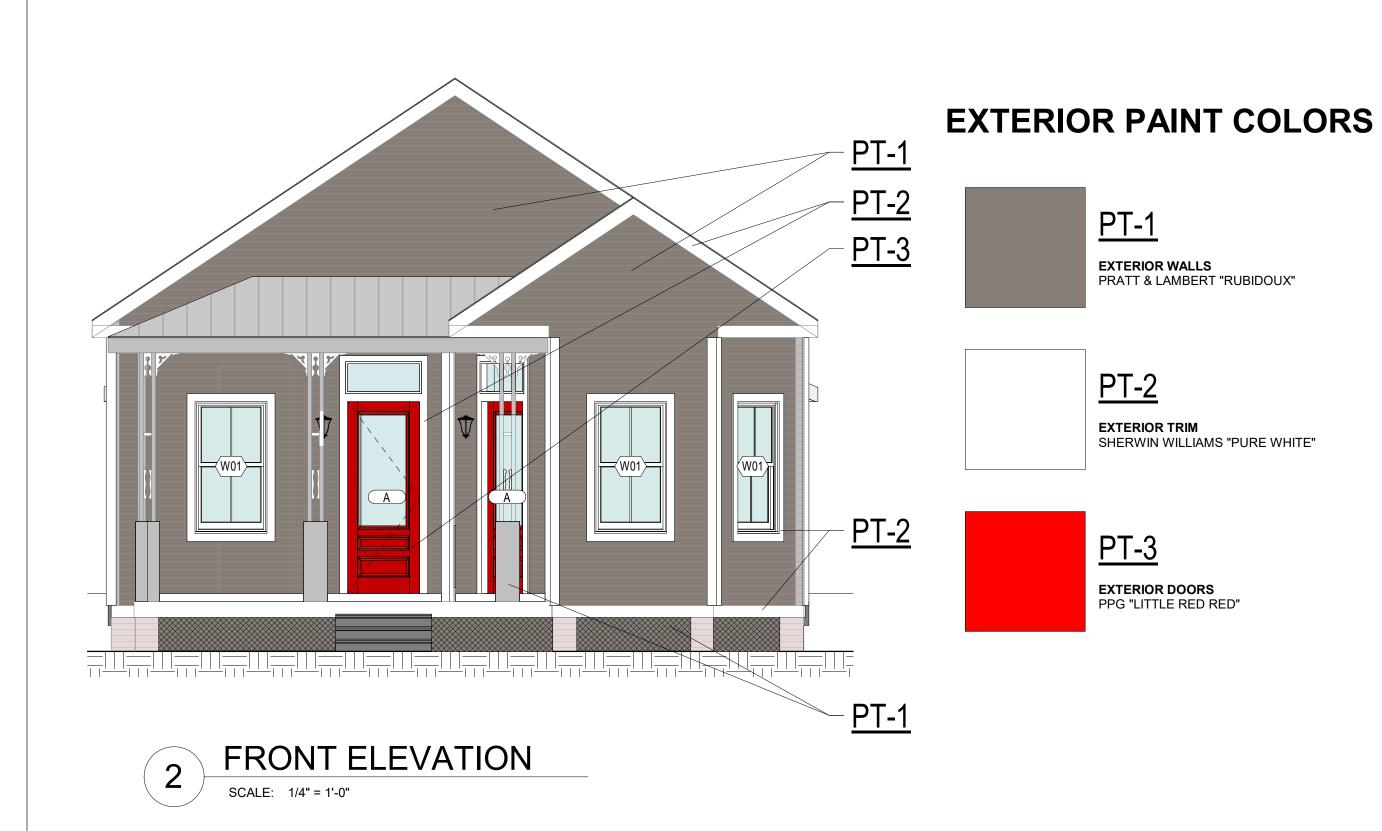

ROOFING


METAL ROOF PANELS

BAKER METAL WORKS 5V PANEL 26 GA GALVALUME MODEL FL PRODUCT # 10094


EXTERIOR LIGHTING


"PERRYWOOD" LED CAST ALUMINUM 12" BLACK


WINDOW AND DOOR ELEVATIONS

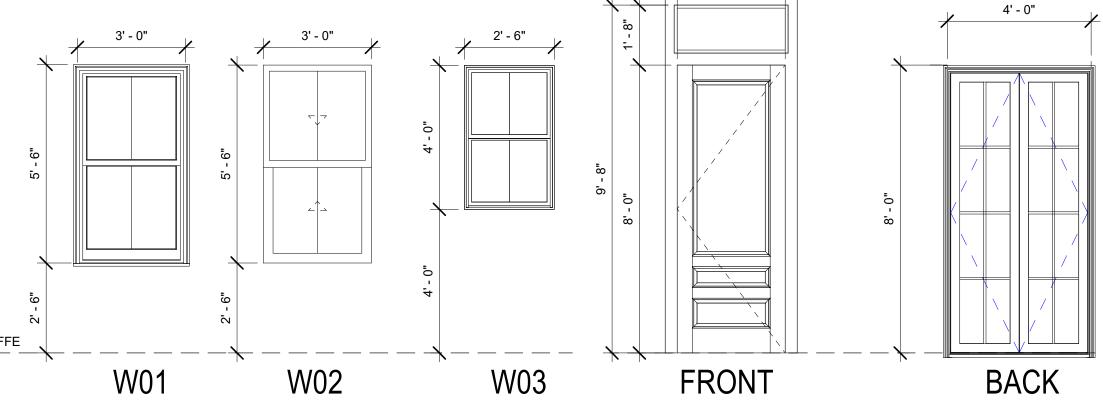



SITE PLAN

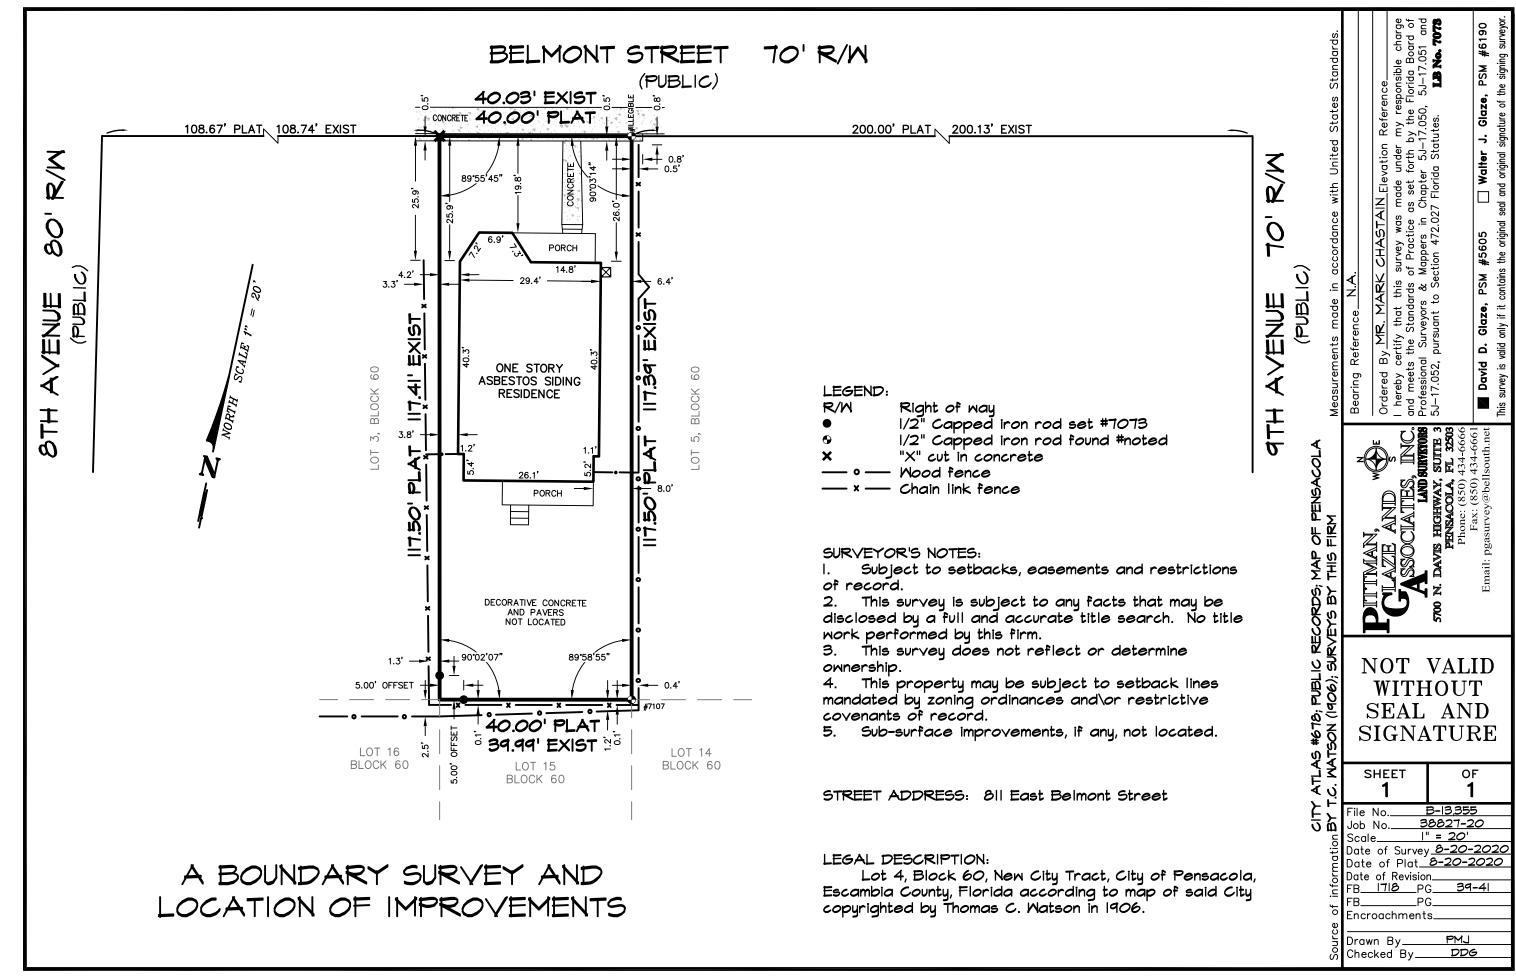

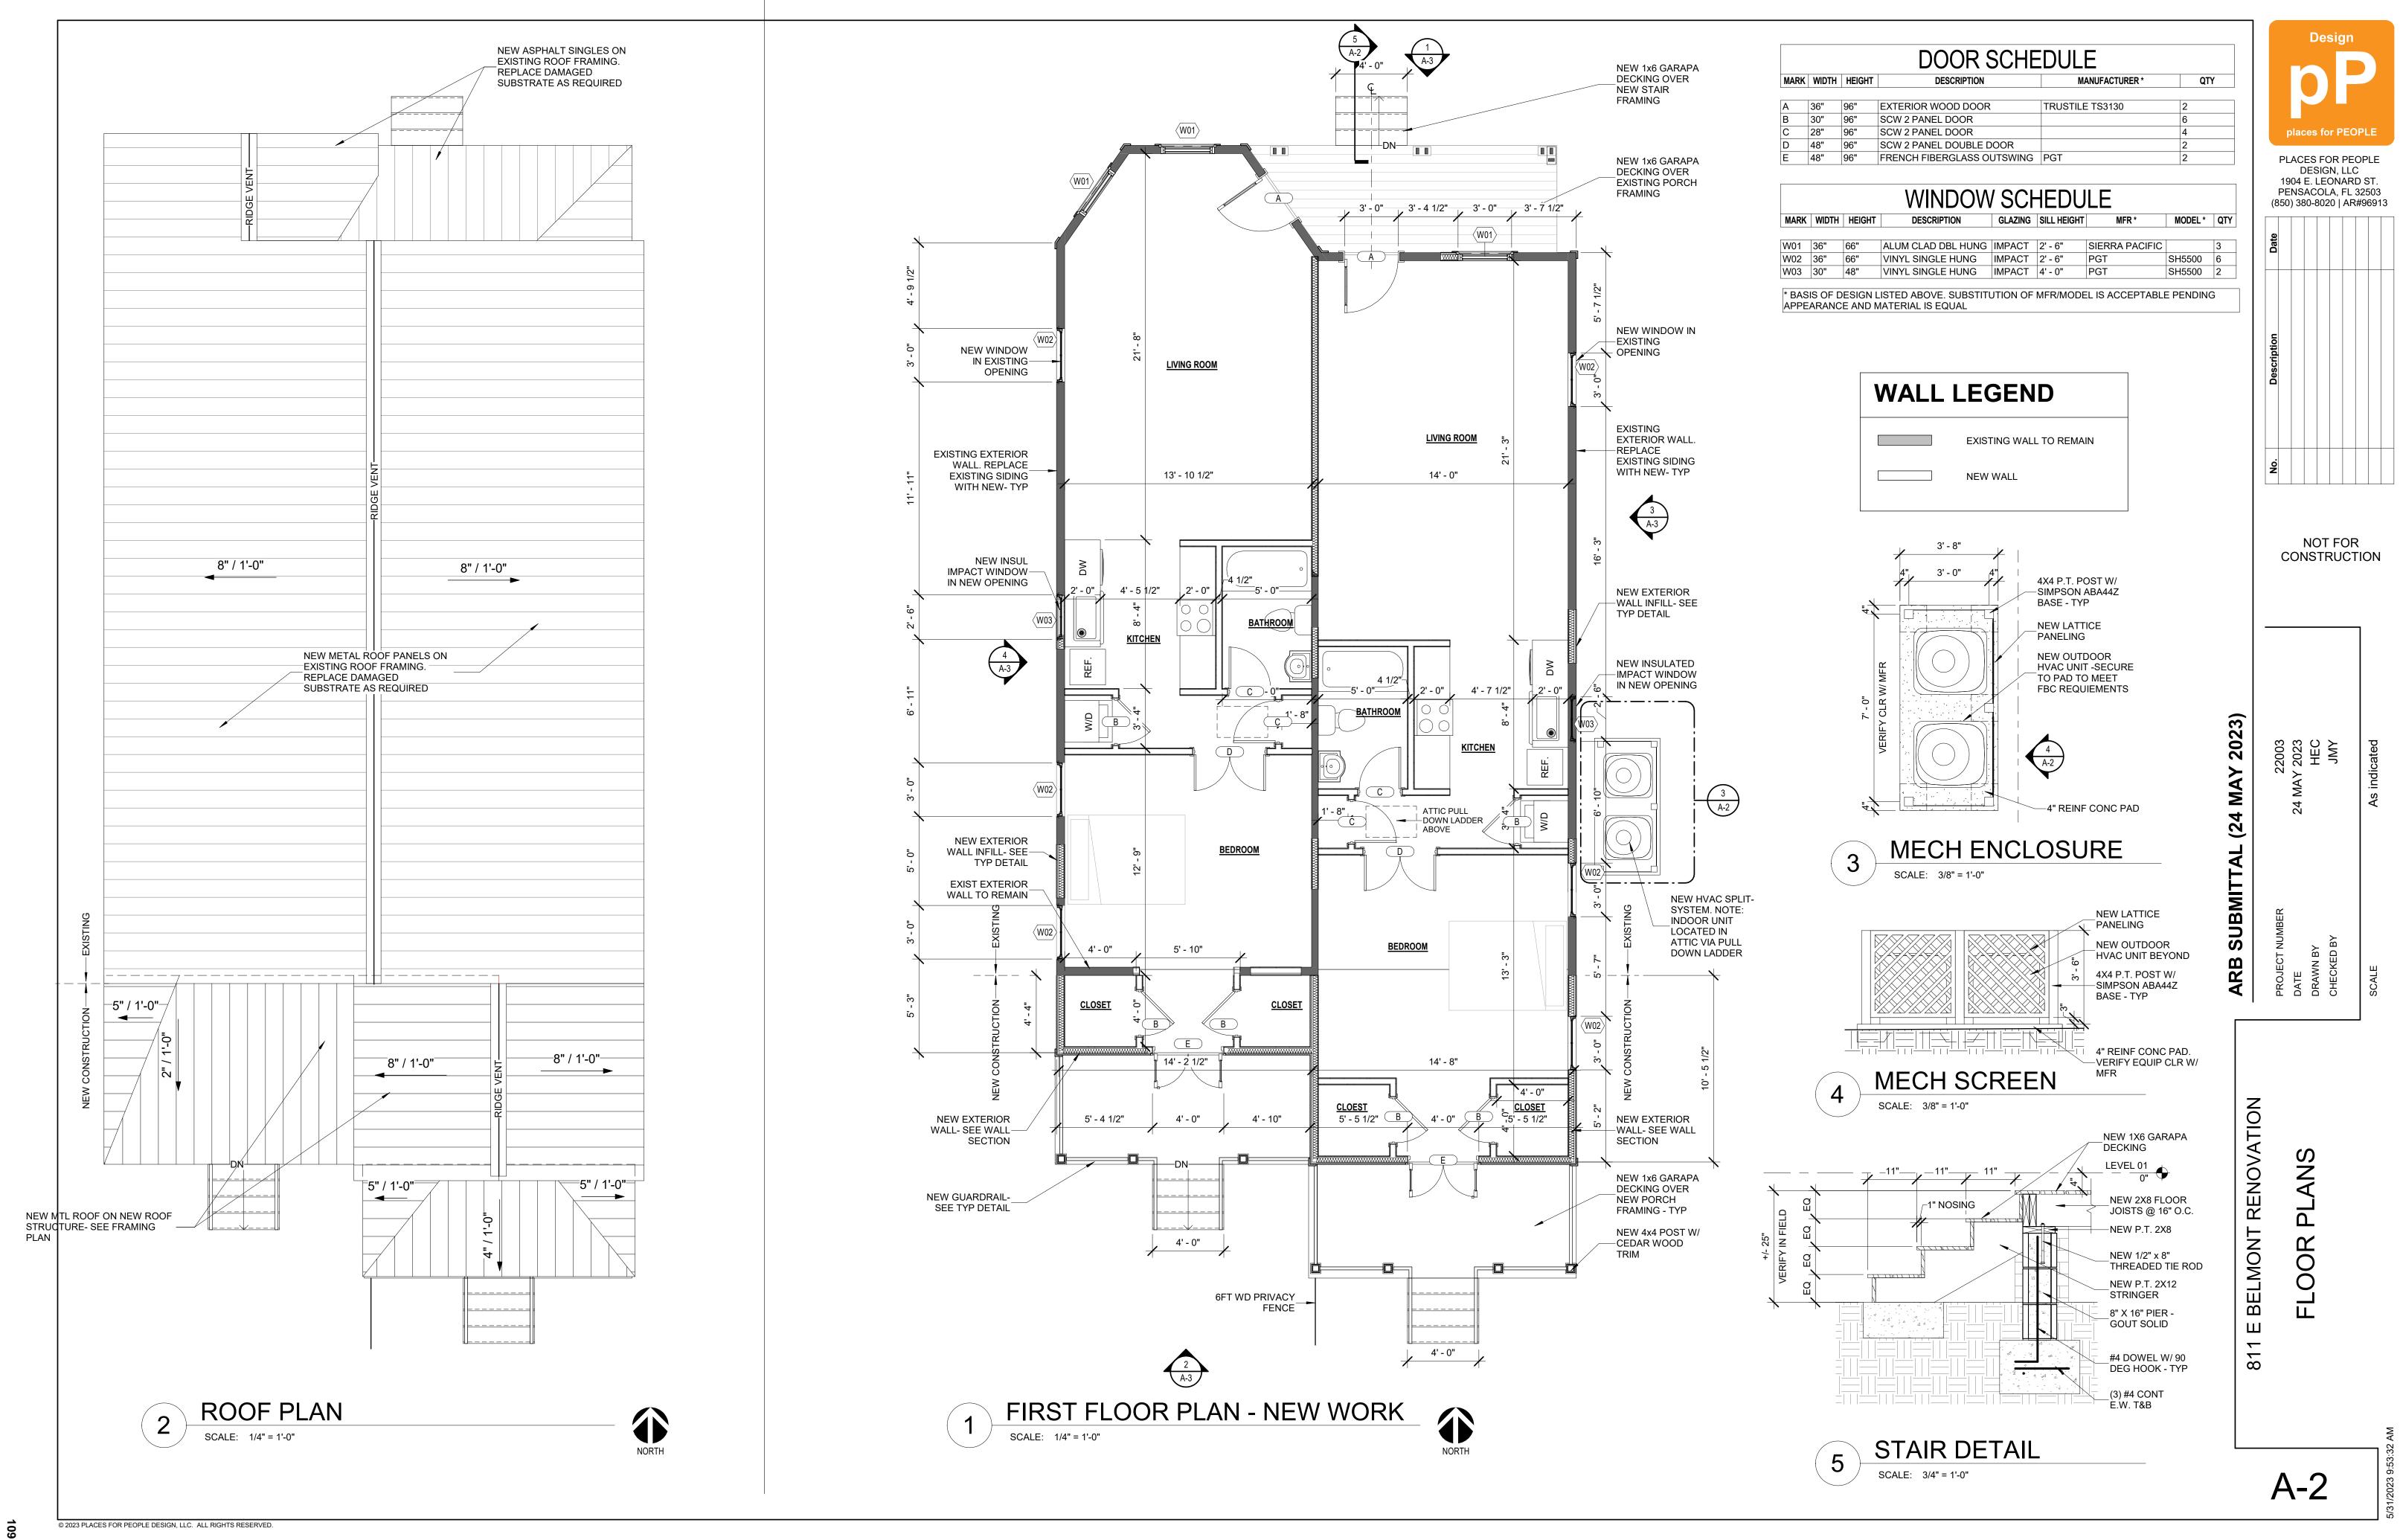

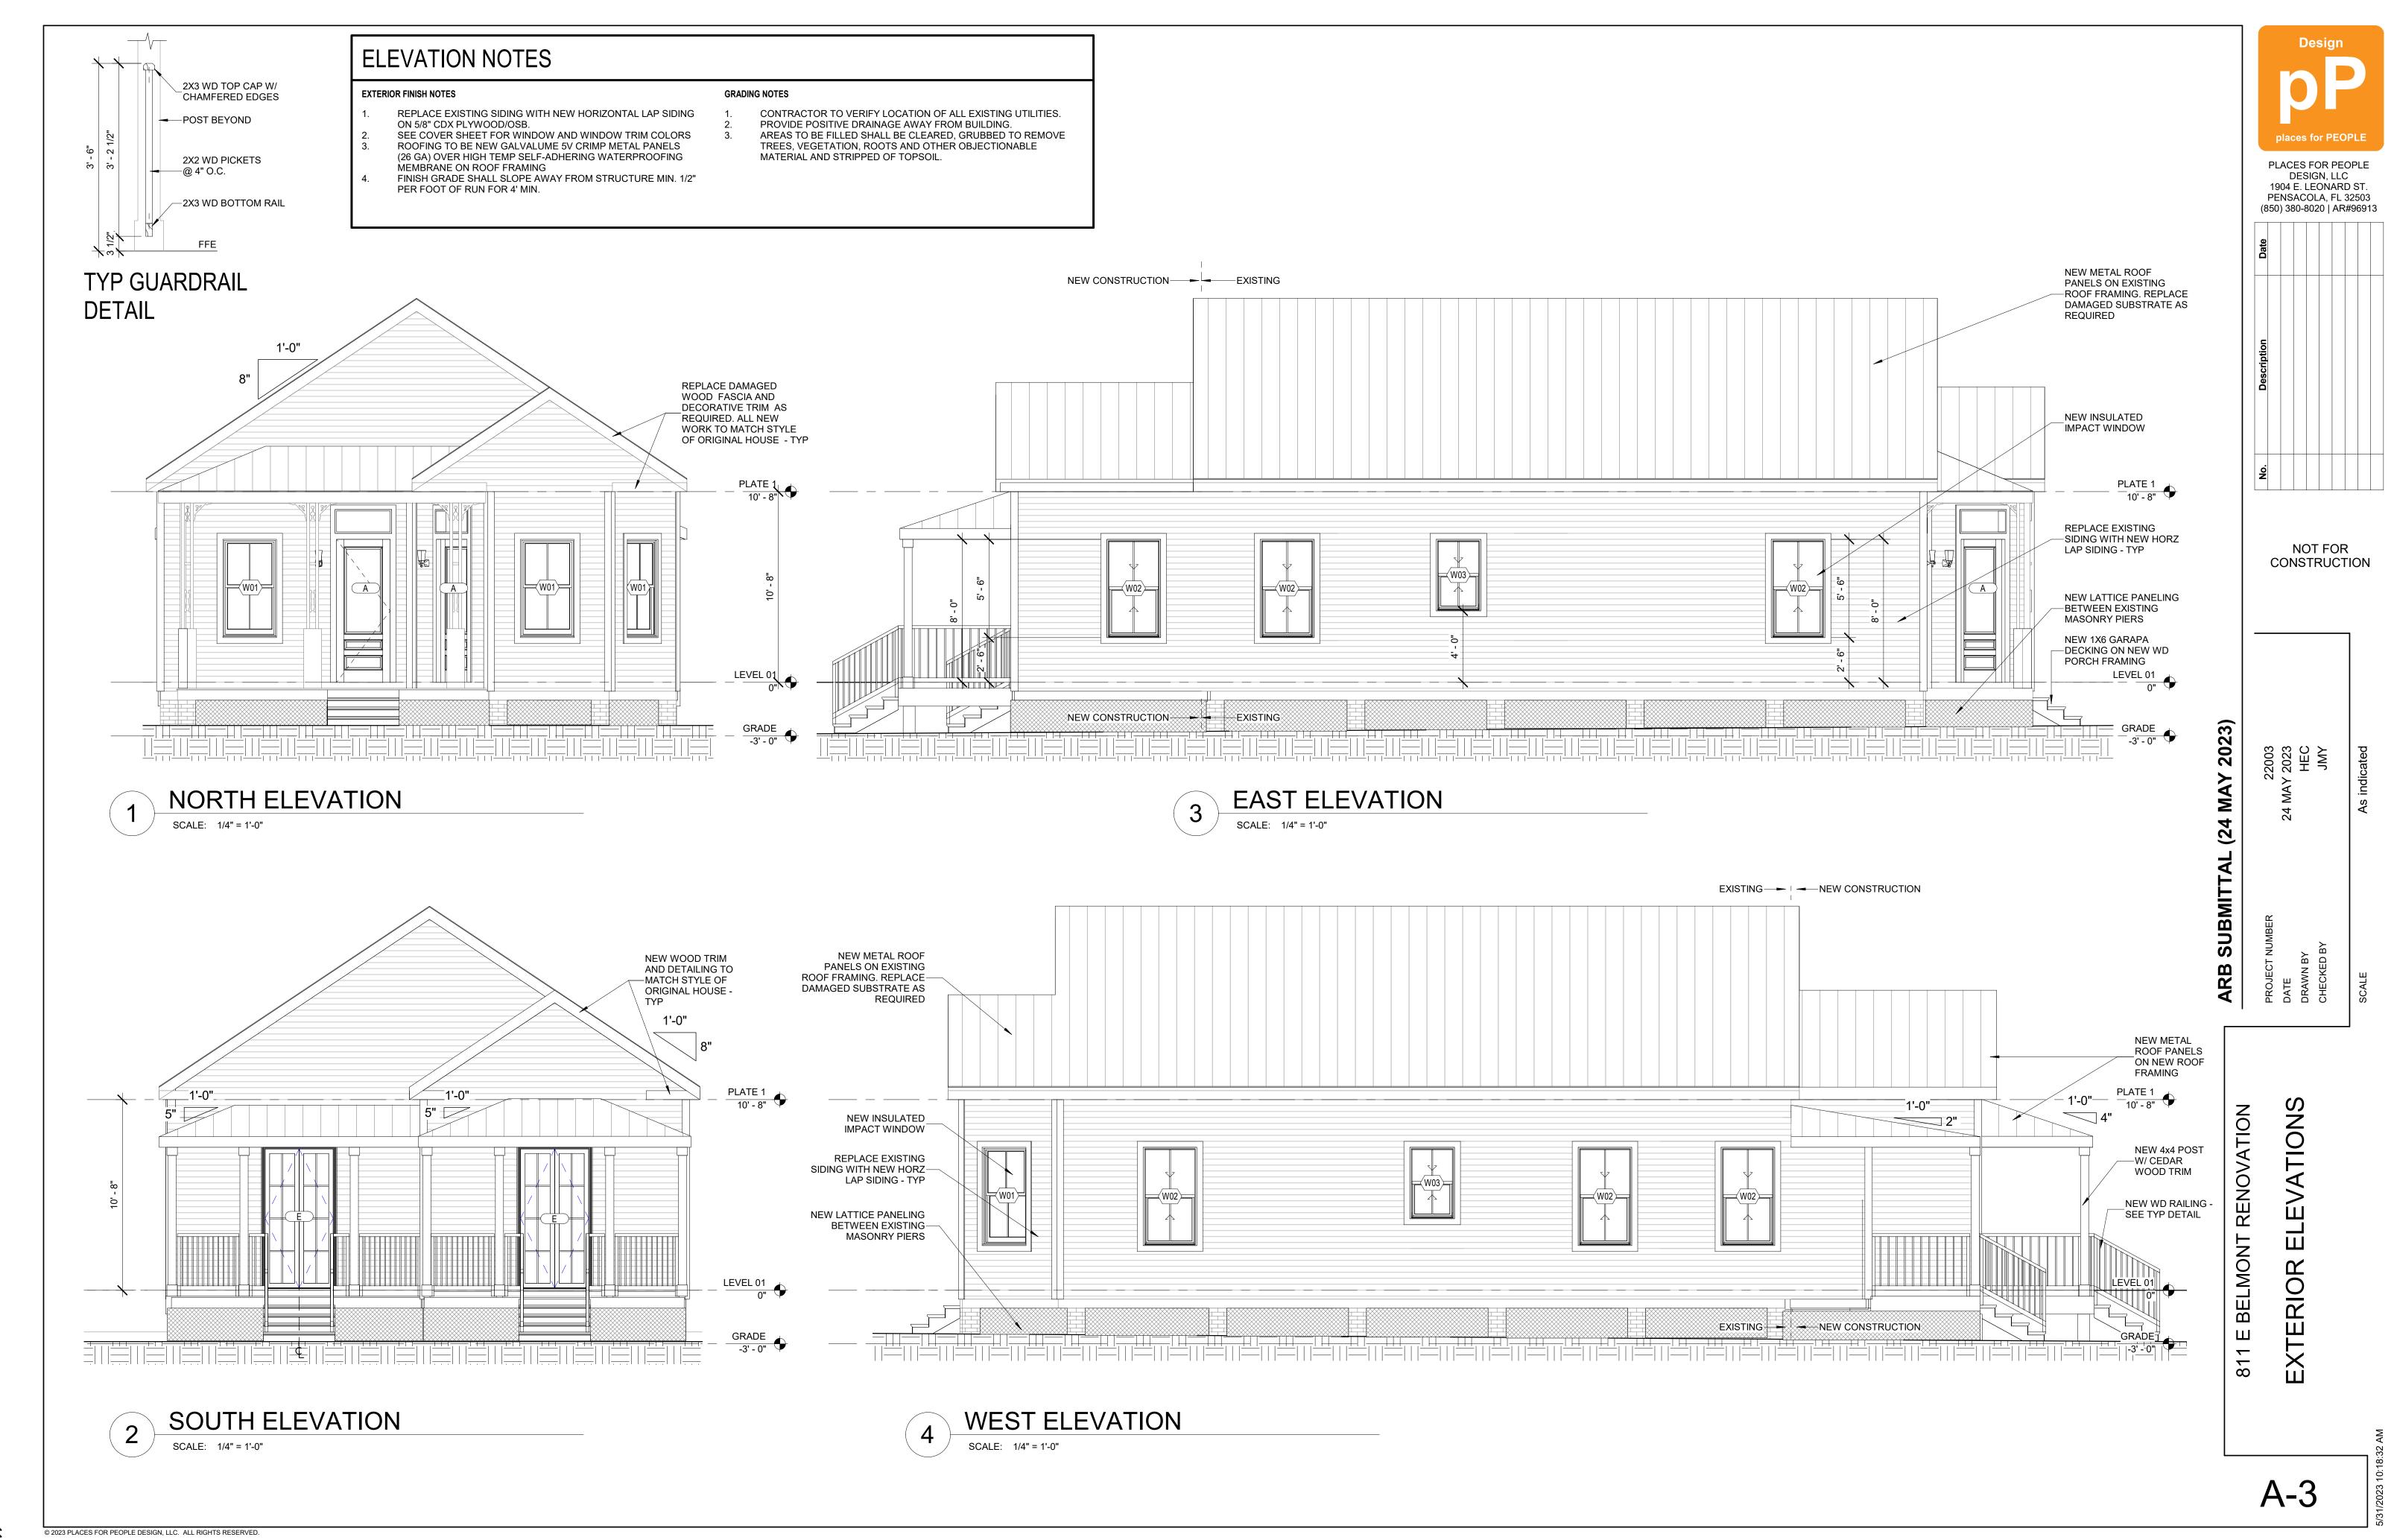


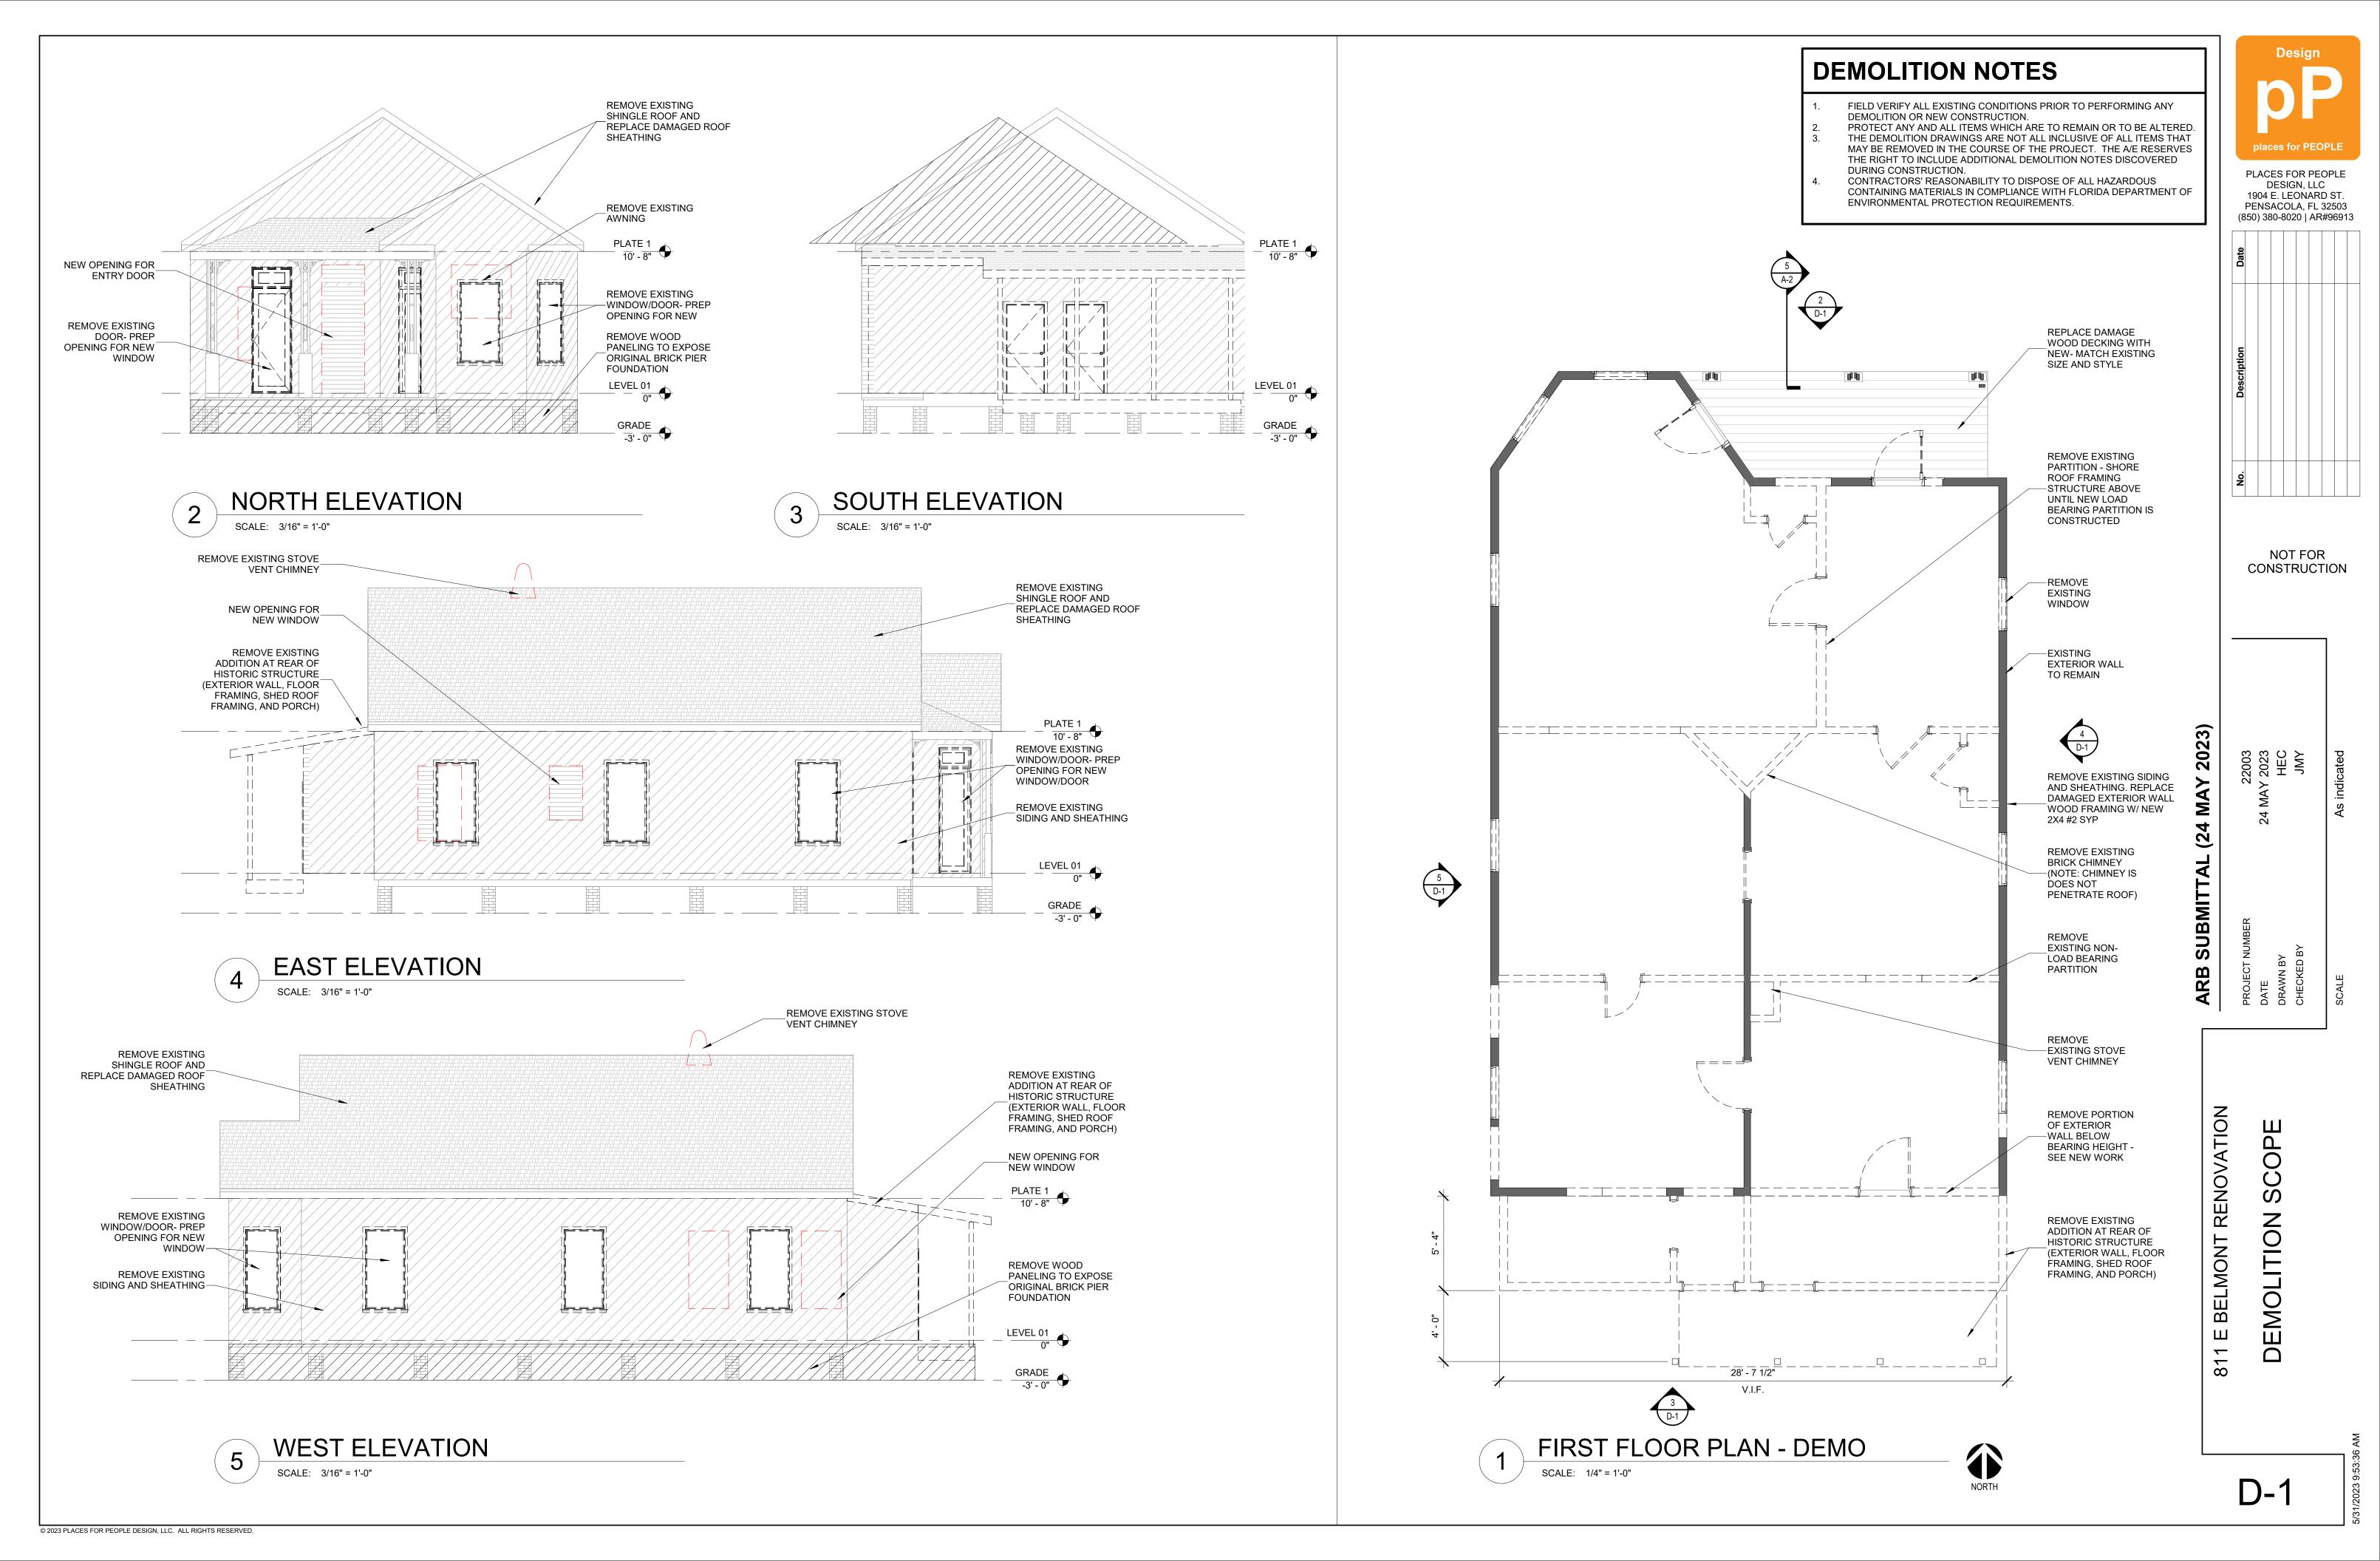

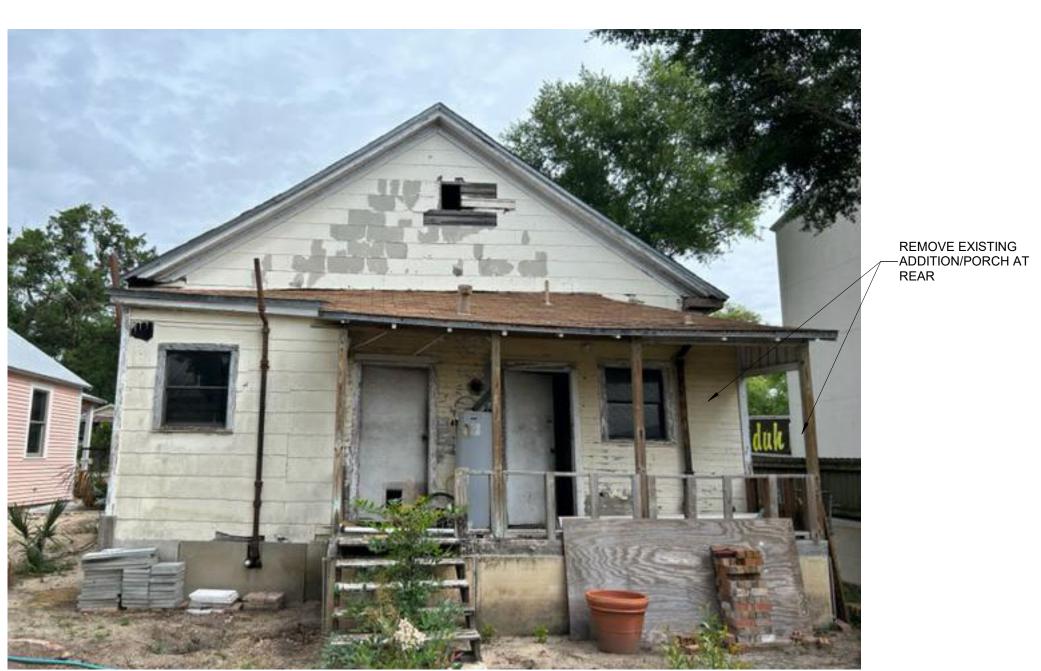

SOUTH ELEVATION



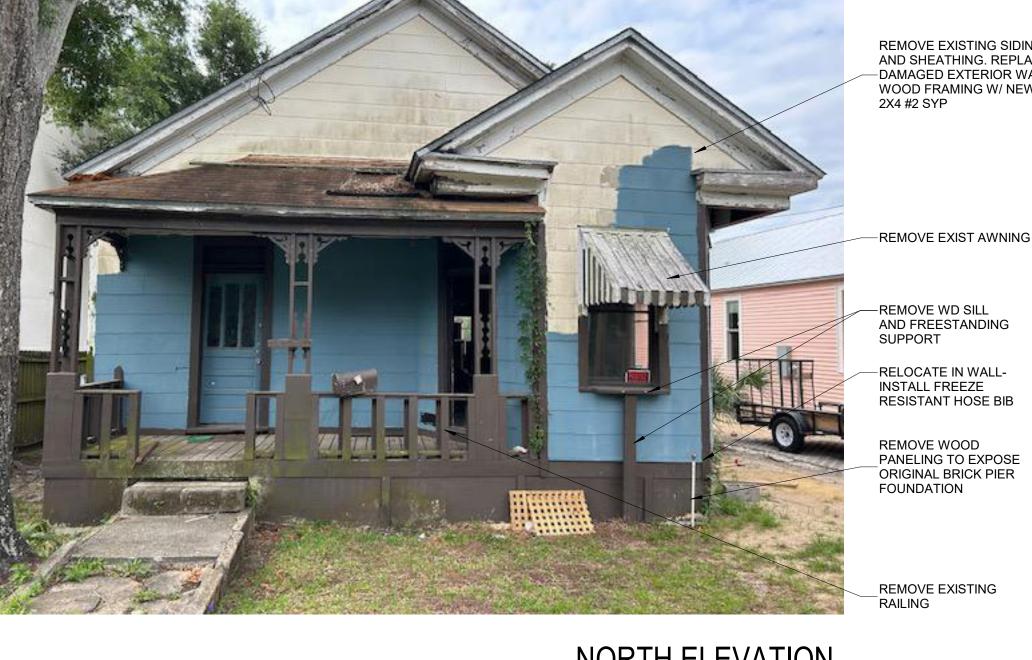

NORTH ELEVATION



EAST ELEVATION

REMOVE EXISTING
—ADDITION/PORCH AT
REAR


REMOVE EXISTING SIDING AND SHEATHING. REPLACE DAMAGED EXTERIOR WALL WOOD FRAMING W/ NEW 2X4 #2 SYP



EAST ELEVATION



WEST ELEVATION

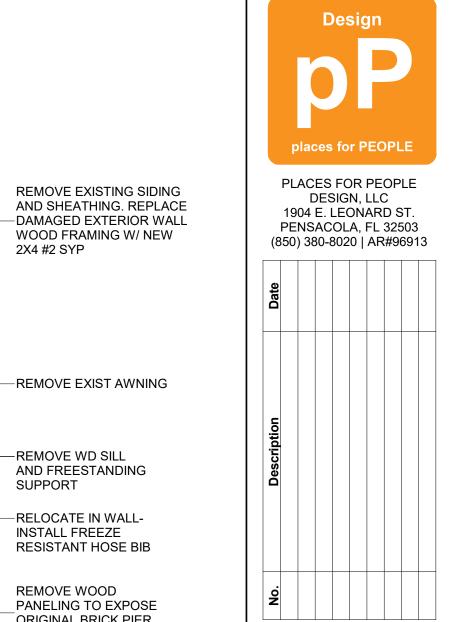


NOT FOR CONSTRUCTION

REMOVE EXISTING SIDING AND SHEATHING. REPLACE —DAMAGED EXTERIOR WALL WOOD FRAMING W/ NEW 2X4 #2 SYP

_REMOVE EXISTING WINDOW REMOVE EXISTING —ADDITION/PORCH AT REAR


_REMOVE EXISTING STOVE VENT CHIMNEY


REMOVE WOOD
PANELING TO
EXPOSE ORIGINAL
BRICK PIER
FOUNDATION

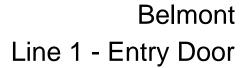



Entry Door Details

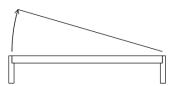

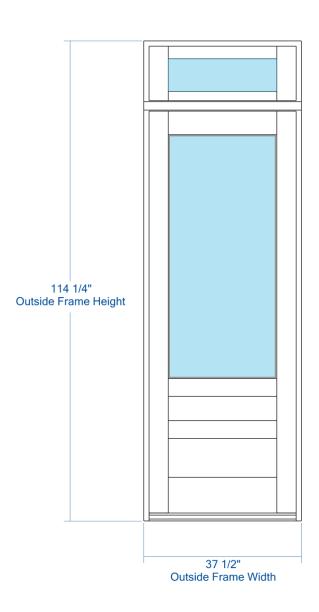

Door Style	Sticking	Panel	Material	Glass / Insert	Product Type
TS3130	SS	С	Resilient Engineered Wood		Entry System




Coastal


French Country

Craftsman

Cape Cod

Traditional

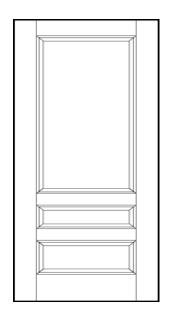

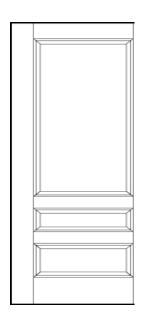

TS3130

Modern Farmhouse

Mediterranean


Application:	Exterior
Available Type:	RESERVE RESILIENT
Series:	TruStile (TS) Series
Thickness:	1-3/4", 2-1/4"

Design Your Door

View Interior Door Where to Buy

Chat

TruStile Resilient™ Exterior Wood Door Construction

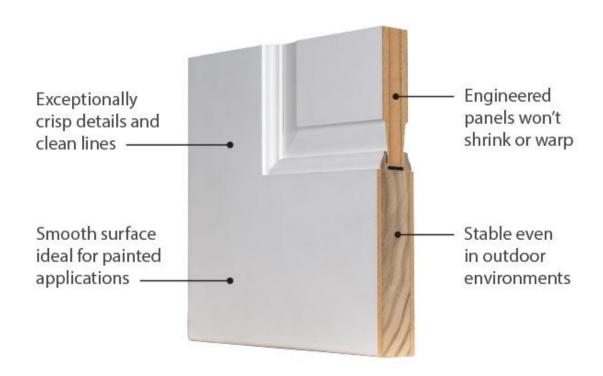

The Resilient Wood Entry System sets the tone of quality for the whole home using the most durable painted construction without sacrificing any design options.

- Engineered with resilient Accoya®, an acetylated wood product, which brings unprecedented reliability and durability to wood.
- Tricoya® top layers provide exceptional stability, durability and paintability, for outdoor applications.
- Most configurations delivered pre-hung with a prem finish, ready to paint to match your design.

Chat



BILL TO: SHIP TO:

Phone Phone Email Fax

QUOTE#	PO #	QUOTE NAME	PROJECT	JOB NAME	CUSTOMER PO #
1690205		Mark Chastain	811 E Belmont		

LINE #	LINE TYPE	DESCRIPTION	QTY	U/M	NET PRICE	EXTENDED

100-1 WindowAndDoor PK- 356

MARCH 2ND, 2023 PRICEBOOK

H3 FeelSafe Double Hung Windows Double Hung Operating 35.5 x 65.5

Custom: Frame Width = 35.5, Frame Height = 65.5, Sash Split = 50/50, Screen Width = 33.1875,

Screen Height = 63.4375

Complete Unit, CoreGuard Plus

Frame = White 001, Clad Finish = AAMA 2604, Primed Interior, White, Pine Interior, Frame

Jamb Flush, Visible Interior Vinyl Profile:Beige

Sash = White 001, Sash-Panel Clad Finish = AAMA 2604, Primed Interior, White

FeelSafe Insulated Low-E, Type LL, Argon Gas, Black Cardinal IG Spacer

Full Screen Applied, Standard Screen, White 001, AAMA 2604, Fiberglass Mesh

Applied Hdwe, Standard Lock, Hdwe = White, Concealed Jambliner, 2-Locks

SDL, Equal, Putty, 7/8", Exterior = White 001, Primed Interior, White, Pine Interior, w/ Shadow

Bar, Shadow Bar Color = Dark Bronze Anodized, 2W1H, Grille Type Custom

Jamb = 4-9/16"

Integral Rigid Vinyl Nailing Fin, Aluminum Drip Cap No/Leg Shipped Separately


U-Factor = 0.29, SHGC = 0.32, CR = 54, VT = 0.47, AI = <0.30/<1.5, CPD =

SIE-N-135-05081-00004, Energy Star Region = NC, GapFill1 = ARG, Can ER = 21, W m 2k = 1.65

PG50, Wind Zone = WZ-3, FBC = FL21907, TDI = WIN-2300

Unit 1: Glass Width = 30.375, Glass Height = 29.8125, Sash Width = 32.125, Sash Height = 31.8125

Rough Opening:36" X 66"Overall Unit Size:35.5" X 65.5"Room Location:Living Room

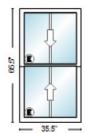

W01



Eastburn Customer Quote

ShipTo: EASTBURN WINDOW & DOOR

Account#: A30381

2620 HOLLYWOOD AVE PENSACOLA, FL 32505 Phone# Fax#

013415-1

Customer Mark Chastain				
Account #				
•				
Phone#	Fax#			

Last Modified Date: 05/31/2023 07:44:26

Job Name:811 E Belmont

Sales Person: Todd Snowden

PO#:

Job Address:

Quote # 7526151

Line #	Item Description	Quantity	Line P	ricing	
0001 (1.00)	SH5500 VINYL SINGLE HUNG 5500	Ordered: 2.00		Sell Price	Ext Price
	Configuration: 29 5X47 5X 2640 STD 1-3/8" NAIL FIN	W FOLIAL 7/	8 LIG CL ES 7/8" TDL 1\/0H/1\/0H	I DRI SWEED 1	816K

onfiguration: 29.5X47.5X.,2640,STD,1-3/8" NAIL FIN,W,EQUAL,7/8 LIG,CL,ES,7/8" TDL,1V0H/1V0H,DBL,SWEEP,1816K-BOXED, CMFRT LFT HNDL



W03

Certification Type: FPA Vent Configuration: EQUAL Size Selection: NOMINAL Size Ref: ACTUAL Rough Masonry: 31 1/4 X 48 1/2

Egress Opening: 25 1/4 X 19 1/8 (3.3482 SQFT) Balance Type: CONSTANT

Interlayer Type: PVB090

Glass: 7/8" LIG (1/8 AN - 7/16 AIR -5/16 AN/AN

Glass Color: CL - CLEAR

Argon Gas: NONE

Grid Type: SDLT0875 - 7/8" Traditional SDL

Grid Location: UNIT

Summary Bottom: 2A1D LITES (1V0H BARS)

Screen Type: 1816K - 1816 Charcoal

Vent Latch: N

Lock Type: SWEEP - Sweep Latch

Comfort Lift: Y

Lock Quantity: 2.0000 Acc Glass Breakage: N

Vent Ht: 23.3930

CAR#: EVAL REPORT

NegativeDesignPressure: 50.0000

EnergyStar: NONE UF: 0.3300 VT: 0.4800

Frame Type: 1.375FIN Window Style: STD Size Code: 2640.0000 Actual Size: 29 1/2 X 47 1/2

Wood Frame Opening: 29 3/4 X 47 3/4

Frame Color: W - White Glass Family: LI - Laminated Insulating

Glass Makeup: LIA207AA5

Does unit need to meet Turtle Code: NO

Low E: ENERGY SHIELD Privacy Glass: NONE - NONE Grid Style: U.COL.LITES

Summary Top: 2A1D LITES (1V0H BARS)

Reinf. Upgrade: NONE - None Screen Frame Type: ROLLFORM

WOCD: N

Upgrade Hardware Finish: N

Lift Rail: N

Boxing Options: BS - Box Screen

Decralite: N

Prep for Mull: N PositiveDesignPressure: 50.0000

PANumber: FL1435

CondensationResistance: 55.0000 SolarHeatGainCoeff: 0.2800

VTCOG: 0.7100

Location: Kitchen Notes: W3

0002 (2.00)	SH5500 VINYL SINGLE HUNG 5500	Ordered: 4.00		Sell Price	Ext Price
	Configuration: 35.5X65.5X.,3056,STD,1-3/8" NAIL FIN	,W,EQUAL,7/	8 LIG,CL,ES,7/8" TDL,1V0H/1V0I	H,DBL,SWEEP,1	816K-



Certification Type: FPA Vent Configuration: EQUAL Size Selection: NOMINAL Size Ref: ACTUAL

Rough Masonry: 37 1/4 X 66 1/2

Egress Opening: 31 1/4 X 28 1/8 (6.097 SQFT)
Balance Type: CONSTANT

Interlayer Type: PVB090

Glass: 7/8" LIG (1/8 AN - 7/16 AIR -5/16 AN/AN

Glass Color: CL - CLEAR

Argon Gas: NONE

Grid Type: SDLT0875 - 7/8" Traditional SDL

Grid Location: UNIT

Summary Bottom: 2A1D LITES (1V0H BARS) Screen Type: 1816K - 1816 Charcoal

Vent Latch: N

Lock Type: SWEEP - Sweep Latch

Comfort Lift: Y

Lock Quantity: 2.0000 Acc Glass Breakage: N Vent Ht: 32.3930 CAR#: EVAL REPORT

NegativeDesignPressure: 50.0000

EnergyStar: NONE UF: 0.3300 VT: 0.4800

Frame Type: 1.375FIN Window Style: STD Size Code: 3056.0000 Actual Size: 35 1/2 X 65 1/2

Wood Frame Opening: 35 3/4 X 65 3/4

Frame Color: W - White
Glass Family: LI - Laminated Insulating

Glass Makeup: LIA207AA5

Does unit need to meet Turtle Code: NO

Low E: ENERGY SHIELD Privacy Glass: NONE - NONE Grid Style: U.COL.LITES

Summary Top: 2A1D LITES (1V0H BARS)
Reinf. Upgrade: NONE - None

Screen Frame Type: ROLLFORM

WOCD: N

Upgrade Hardware Finish: N

Lift Rail: N

Boxing Options: BS - Box Screen

Decralite: N Prep for Mull: N

PositiveDesignPressure: 50.0000

PANumber: FL1435

CondensationResistance: 55.0000 SolarHeatGainCoeff: 0.2800

VTCOG: 0.7100

Notes: W2 Location: Bedrooms

PANEL/II

0003

(3.00)

Ε

Configuration: 47.75X95.75,4080,W,CL,L6,1-3/16 TLIG,NONE,7/8" TDL,1V3H/1V3H,OUTSWING,1.375EXTERIOR,XX,ACT R NACT L.DUMMY.N.KD FRM.LIT211AA5

FD5555 FRENCH DOOR SERIES 5555

Certification Type: FPA Size Selection: NOMINAL Actual Size: 47 3/4 X 95 3/4 Opening Size: 48 X 96 Door Swing: OUTSWING

Primary Panel: RIGHT

Door Glass: 1 3/16" IG (1/8TMP-11/16 AIR-5/16 Glass Color: CL - CLEAR Low E: ENERGY SHIELD

Privacy Glass: NONE - NONE Grid Style: U.COL.LITES

Inactive Hardware Prep: DUMMY Send Inactive Lock: Y

Hardware Style: 800LVR

Hinge Color: BSS - Brushed Stainless Steel

5/8 Add-on Flange: N Acc Glass Breakage: N

Decralite: N

PositiveDesignPressure: 50.0000

PANumber: FL-331

CondensationResistance: 60.0000

SolarHeatGainCoeff: 0.2100

VTCOG: 0.7100

Ordered:

Assembly Type: XX Size Code: 4080.0000

Assembly Sz: 47 3/4 x 95 3/4 Frame Color: W - White

Threshold Type: 1.375EXTERIOR Glass Family: LI - Laminated Insulating Does unit need to meet Turtle Code: NO

Door Glass Color: CLEAR Argon Gas: NONE

Grid Type: SDLT0875 - 7/8" Traditional SDL Grid Summary Door: 2A4D LITES (1V3H BARS)

Sell Price

Ext Price

Send Primary Lock: Y

Hardware Color: SNKPVD - Satin Nickel PVD

Keyed Hardware Alike: N Anchor Group: A.FD5555 Boxing Options: N - None

KD: Y

CAR#: EVAL REPORT

NegativeDesignPressure: 50.0000

EnergyStar: NONE

UF: 0.3300 VT: 0.3500

Location: Doors E

Notes:



ROOFING




5-V

METAL ROOF PANELS

MRF BAKER METAL WORKS

MODEL 5V PANEL GA 26 GA FINISH GALVALUME FL PRODUCT # 10094

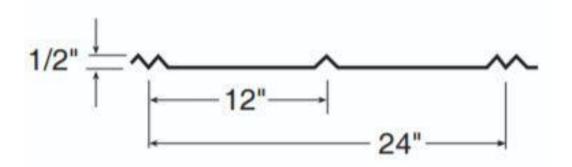

5-V PANEL

The 5-V Panel has a beautiful and simple design. It's no wonder it's been a popular panel choice for many generations. The aesthetic value of this panel design has given rise to its popularity, especially in coastal homes. Many customers have

used it as accent
panels in nonstructural designs as
well. This panel
provides 2' of
coverage per panel
width & can be



custom cut to any length. 5-V panels are only available in 26 gauge Galvalume.

INSTALLATION SPECIFICATIONS

Click here to download installation specifications.

THE SOUTH'S METAL ROOFING HEADQUARTERS.

CONTACT US

3 Day Delivery or get \$50 | Free Shipping & Returns | See All Promos



Search (

1-800-695-2677



Outdoor g Lighting

LED

Lamps

Ceiling Fans Home Decor Shop Styles

Up to 30% OFF the entire site! Use Coupon Code: SPRING23-DEALS

<u>Home</u> / <u>Lighting Manufacturers</u> / <u>Generation Lighting Studio Collection</u> / <u>Visual Comfort Studio</u> / <u>Visual Comfort Studio Outdoor Wall Lighting</u> / Visual Comfort Studio 8414201EN3-12 Perrywood Black LED Exterior Extra Small Lamp Sconce



Visual Comfort Studio 8414201EN3-12 Perrywood Black LED Exterior Extra Small Lamp Sconce


by Visual Comfort Studio Item# VCS-8414201EN3-12

Product Specification

- Black Finish
- · Water Shade
- Measures 6.5 inches wide, 12 inches tall,
 7.875 inches deep
- · Wet rated
- Uses 1 9.5w Replaceable LED bulb(s) (included)
- 800 Lumens
- Color Temperature: 3000K
- CRI: 90
- Title 24 Compliant
- ENERGY STAR Certified
- A product of Generation Lighting
- · A Sea Gull Lighting product




LATTICE PANELING SQUARE WOOD PRIVACY LATTICE

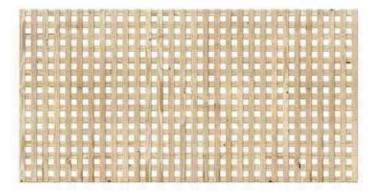





WOOD SIDING 1X6 WOOD LAP SIDING W/ 4" EXPOSURE

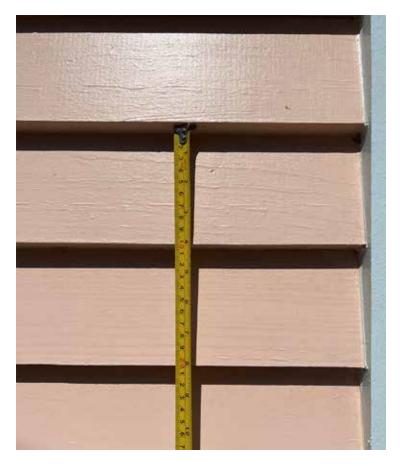





PARKING PAVER
BELGARD CATALINE GRANA, SLATE COLOR





PORCH DECKING 1X6 GARAPA



