

City of Pensacola

Zoning Board of Adjustments

Agenda - Final

Wednesday, September 15, 2021, 3:00 PM

Hagler/Mason Conference Room, 2nd Floor

QUORUM / CALL TO ORDER

1. 21-00790 SWEARING IN NEW APPOINTMENT (WILLIAM WEEKS) AND

REAPPOINTMENT (STEVEN SEBOLD)

APPROVAL OF MINUTES

2. 21-00775 ZONING BOARD OF ADJUSTMENTS MEETING MINUTES FROM

APRIL 21, 2021

Attachments: ZBA Minutes Approved 4.21.21.pdf

REQUESTS

3. 21-00776 ZBA 2021-004

3471 OAKMONT DRIVE

R-1AAA

Attachments: Application Complete.pdf

Screen Addition Site Plan.pdf

Photo Exisitng Patio.jpg

Photo Exisitng Patio (2).jpg

Photo Rear Yard.jpg

Photo Rear Yard 2.jpg

4. 21-00777 ZBA 2021-05

1602 E. BRAINERD STREET

R-1AA

Attachments: Application Complete.pdf

Comerford Reno PERMIT SET 8-20-21.pdf

5. 21-00778 1818 E. STRONG STREET - THIS ITEM HAS BEEN POSTPONED

UNTIL FURTHER NOTICE

R-1AAA

ADJOURNMENT

ADDITIONAL INFORMATION:

SUBSEQUENT APPLICATION(S): If denied a variance by the Board, that request for a variance cannot be heard again for a period of one (1) year.

JUDICIAL REVIEW OF DECISION OF BOARD OF ADJUSTMENT:

Per section 12-12-2 (D) of the City of Pensacola Land Development Code, any person or persons, jointly or severally, aggrieved by any decision of the board, or the city, upon approval by the city council, may apply to the circuit court of the First Judicial Circuit of Florida within thirty {30} days after rendition of the decision by the board. Review in the circuit court shall be by petition for writ of certiorari or such other procedure as may be authorized by law.

If any person decides to appeal any decision made with respect to any matter considered at this meeting or public hearing, such person may need to ensure that a verbatim record of the proceedings is made, which record includes the testimony and any evidence upon which the appeal is to be based.

If a Notice of Appeal has not been received within thirty-five {35) days of the date of the meeting the variance was denied, the petitioner shall be notified by the Building Official that they have ten {10} days to remove or correct the violation.

ADA Statement:

The City of Pensacola adheres to the Americans with Disabilities Act and will make reasonable accommodations for access to City services, programs and activities. Please call 850-435-1670 (or TDD 435-1666) for further information. Requests must be made at least 48 hours in advance of the event in order to allow the City time to provide the requested services.

If any person decides to appeal any decision made with respect to any matter considered at such meeting, he will need a record of the proceedings, and that for such purpose he may need to ensure that a verbatim record of the proceedings is made, which record includes the testimony and evidence upon which the appeal is to be based.

The City of Pensacola adheres to the Americans with Disabilities Act and will make reasonable accommodations for access to City services, programs and activities. Please call 435-1606 (or TDD 435-1666) for further information. Request must be made at least 48 hours in advance of the event in order to allow the City time to provide the requested services.



City of Pensacola

Memorandum

File #: 21-00790 Zoning Board of Adjustments 9/15/2021

TO: Zoning Board of Adjustments Members

FROM: Leslie Statler, Senior City Planner

DATE: 9/8/2021

SUBJECT:

Swearing in new appointment (William Weeks) and reappointment (Steven Sebold)

BACKGROUND:

Mr. Weeks has been appointed by City Council and Mr. Sebold has been reappointed.



City of Pensacola

Memorandum

File #: 21-00775 Zoning Board of Adjustments 9/15/2021

TO: Zoning Board of Adjustments Members

FROM: Leslie Statler, Senior City Planner

DATE: 9/8/2021

SUBJECT:

Zoning Board of Adjustments Meeting Minutes from April 21, 2021

BACKGROUND:

Click or tap here to enter text.



Zoning Board of Adjustment

MINUTES OF THE ZONING BOARD OF ADJUSTMENT

April 21, 2021

MEMBERS PRESENT:

Chairperson White, Vice Chairperson Del Gallo,

Board Member Lonergan, Board Member Shelley, Board Member Stepherson, Board

Member Wiggins, Board Member Williams

MEMBERS VIRTUAL:

None

MEMBERS ABSENT:

Board Member Sebold, Board Member Taylor

STAFF PRESENT:

Planner Hargett, Historic Preservation Planner Harding, Senior Planner Statler (virtual), Planning Director Morris (virtual), Assistant Planning Director Cannon (virtual), Assistant City Attorney

Lindsay, Help Desk Technician Russo

OTHERS VIRTUAL:

Joseph McNair, Greg Bricking, Chris Bosso

1) CALL TO ORDER/QUORUM PRESENT

The Zoning Board of Adjustment (ZBA) was called to order at 3:00 p.m. by Chairperson White with a quorum present. Chairperson White then read the ZBA rules and instructions and explained the procedures of the in-house/virtual Board meeting.

2) APPROVAL OF MINUTES January 20, 2021

The ZBA January 20, 2021 minutes were approved without objection by the Board.

3) ZBA 2021-002

1203 W. Gimble Street

R-1A

Property owners Terrence & Peggie Bosso are requesting a variance to rebuild an accessory dwelling unit in place of an existing wood building. The existing nonconforming structure is located on the south west corner of the property. The depth of the parcel makes it challenging to comply with rear and side setbacks. The parcel is 52' X 55'.

The owners are proposing to remove the existing nonconforming structure of 18'.2" X 13'.5' which currently sits within half of a foot on the property lines. They propose to construct a 16' X 11.5' accessory dwelling unit which will be less nonconforming.

The request is for a 3 FT setback on the west and south boundary lines.

Mr. Bosso presented to the Board and stated he had owned the property since 1989; the property dimensions were 52'x 55' and the existing accessory building was built on the lot line of the southern and western sides. Accessing these sides for typical maintenance had never been an issue, but the property recently sold. There will be a structure 3' or 4' off his western line and probably a fence; he will have no more access to the building and was requesting to move it 3' off the southern property line and 3' off the western line and reduce the size by 25%. It would overlap the existing footprint and would allow future maintenance of both the property and the accessory building. The building would be less nonconforming and would occupy the same footprint minus 25%. It would be visually more aesthetic and appealing and be less problematic for future interactions with adjacent neighbors.

Board Member Del Gallo addressed the lot to the west; Mr. Bosso stated the lot was one piece (60') but assumed there would be two 30' wide lots.

Board Member Del Gallo made a motion to approve the variance, seconded by Board Member Lonergan. Board Member Del Gallo advised the applicant was making a bad situation better while maintaining the outbuilding and helping the neighbor buying the property with his west fence. Board Member Lonergan stated this was ensuring adequate space and a reduction in what was already there. The motion then carried unanimously.

4) ZBA 2021-003 1

1709 E. Fisher Street R-1AAA

Mr. Tim Daniel of Reflections Home Design & CAD Services is requesting two variances:

- 1) Setback reduction from the required 15 FT to 9 FT 9 1/2 INCHES on the side yard (east) to accommodate an addition. The proposed addition is for a bedroom and bath as well as laundry space.
- 2) Setback reduction from the required 30 FT to 25 FT 7 INCHES on the rear yard to accommodate attaching an existing detached garage. By attaching the existing garage, this would allow for direct access to the proposed bedroom/laundry room addition.

Chairperson White verified both variances would be considered together per the applicant.

Mr. McNair presented to the Board and stated the existing home had been there for 71 years, and the house currently sits 9' off the setback on the eastern side of the yard along 18th Street. They proposed to extend the existing wall to the garage. The plan was to extend along the existing house and connect to the existing detached garage which would then make it an attached garage with an entrance. They were not asking to encroach any further from where the existing buildings were located but desired to attach them and make them more cohesive and aesthetically pleasing. He pointed out there was so much right-of-way in the yard that you could not build a home of a reasonable size, and this would maintain the integrity of the home and the neighborhood.

Chairperson White asked how far the gap between the garage and the house needed to be in order to be classified detached; staff determined the gap would be 4' eave to eave. Board Member Del Gallo as if there was input from any of the neighbors, and there was none.

Board Member Wiggins made a motion to approve the variances, seconded by Board Member Del Gallo. Board Member Wiggins stated the 100' right-of-way on 18th Street had been an issue for other homeowners, and the Planning Board had addressed this issue as well. A right-of-way vacation could be an option, but

this proposal seemed to be the path of least resistance. Chairperson White struggled with the request being self-created but understood the applicant wanted the best use of his corner lot property. **The motion then carried 6 to 1 with Chairperson White dissenting.**

DISCUSSION - None

ADJOURNMENT -

There being no further business, the meeting adjourned at 3:19 p.m.

Respectfully Submitted,

Planner Amy Hargett Secretary to the Board



City of Pensacola

Memorandum

File #: 21-00776 Zoning Board of Adjustments 9/15/2021

TO: Zoning Board of Adjustments Members

FROM: Leslie Statler, Senior City Planner

DATE: 9/8/2021

SUBJECT:

ZBA 2021-004 3471 Oakmont Drive R-1AAA

BACKGROUND:

Mr. James Rogers is requesting a variance to reduce the rear yard setback from 30 FT to 25 FT to accommodate a screen room addition.

The applicant has provided a copy of the HOA approval. Although a waiver was granted by the neighborhood's HOA, the Lenox Architectural Control Committee is not a governing body, board or commission of the city and does not have the authority to grant variances to the Land Development Code.

ZBA2021-004



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	VARIANCE APPLICATION
	A COMPLETE APPLICATION SHALL INCLUDE THE FOLLOWING:
	 A. One (1) copy of this completed application form (Please type or print in ink.) B. Site plan and/or survey showing the following details:* Abutting street(s) Lot dimensions and yard requirements (setbacks) Location and dimensions of all existing structures Location and dimensions of all proposed structures and/or additions Dimension(s) of requested variance(s) C. Other supporting documentation (drawings, photographs, etc) to support request(s).* A non-refundable application fee of \$500.00.
	The Applicant must provide fourteen (14) copies of any documents larger than 8½ x 11 or in color.
	Maximum page size for all submitted material should be $11'' \times 17''$ to allow for processing and distribution.
	(To be Completed by Staff)
Provi	ision(s) of Zoning Ordinance from which the variance(s) is/are being requested:
Secti	on(s)/ Tables(s) $\frac{12-3-3}{T_0}$ $\frac{12-3-3}{T_0}$ Zoning $\frac{R-1AAA}{T_0}$
	(To be Completed by Applicant)
The A	Applicant requests consideration of the following variance request(s):
Prop	erty Address: 347/ OAKMONT Deive PENSACOLA FL 32503
Curre	ent use of property: Residence
1 0	Describe the requested variance(s): Reduction of Rear Setback
-	JIII SOFT IO AS FI
f. 6	

re Patrio feernature presently in storage from a
Planning Services

M Sababata 222 W. Main Street * Pensacola, Florida 32502

The Subdivision (850) 435-1670 Live

For Similar Canais e

	equested variance(s) is/are necessary to permit the property owner to obtain the ed by other property owners in the same district:
Homeowne	desires to construct a screened Room Assition
for mosquito	Control. Proposed Dimercians 14'x 36', Other
Proporties curr	untly contain screened Enclosures for similar purposer.
4. Explain why the re rights of others in the	quested variance(s) is/are not detrimental to the general welfare or to property vicinity:
A scrues	Room Addition will not be detrimental to others
in vicinity See Attackee	just as screen Enclosures Currently in place are not. I Aerial.
5. Explain what other	condition(s) may justify the proposed variance(s):
	has approved the proposed Placement as down
	survey Letter is Attached
	and the state of t
	Application Date: 8-19-21
Applicant:	Application Date: 8-19-21 Jim Rogera
Applicant: Applicant's Address:	Jim Rogera 3471 OAKmont Drive Pensacola, Fr 3250)
	Jim Rogera 3471 OAKmont Drive Pensacola, fr 3250) 153838 a Verizon, net Phone: 305-812-2600
Applicant's Address:	Jim Rogera 3471 OAKmont Drive Pensacola, Fr 3250)
Applicant's Address: Email:	Jim Rogera 3471 OAKmont Drive Pensacola, fr 3250) 153838 a Verizon, net Phone: 305-812-2600
Applicant's Address: Email: Applicant's Signature:	Jim Rogera 3471 OAKmont Drive Pensacola for 3250) 153838 C Verizon, net Phone: 305-812-2600 Glamer C. Roggis
Applicant's Address: Email: Applicant's Signature: Property Owner: Property Owner's	Jim Rogera 3471 OAKmont Drive Pensacola, fr 3250) ir3838 c Verizon, net Phone: 305-812-2600 Jim Rogers Jim Rogers

The City of Pensacola adheres to the Americans with Disabilities Act and will make reasonable modifications for access to City Services, programs, and activities. Please call 435-1600 for further information. Requests must be made at least 48 hours in advance of the event in order to allow the City time to provide the requested services.


Variance Application



VARIANCE GRANTED BY THE BOARD OF ADJUSTMENT: The petitioner must secure a building permit and commence work within one hundred-eighty (180) days of the date of the granting of the variance, unless additional time is granted by the Board at that particular meeting.

JUDICIAL REVIEW OF DECISION OF THE BOARD OF ADJUSTMENT: If denied a variance by the Board, that request for a variance cannot be heard again for one year. The petitioner has thirty (30) days form the date of the meeting to appeal the decision according to Section 12-12-2 of the Land Development Code. Any person or persons, jointly or severally aggrieved by a decision of the Board may apply to the Circuit Court of the First Judicial Court of Florida. The Board, Building Inspector, or Attorney of the City of Pensacola must be notified of an appeal within five (5) days of the application being made to the Circuit Court. If a Notice of Appeal has not been received within thirty-five (35) days of the date of the meeting the variance was denied, the petitioner shall be notified by the Building Inspector that they have ten (10) days to remove or correct the violation.

ELLE NO LITT ON BLIE

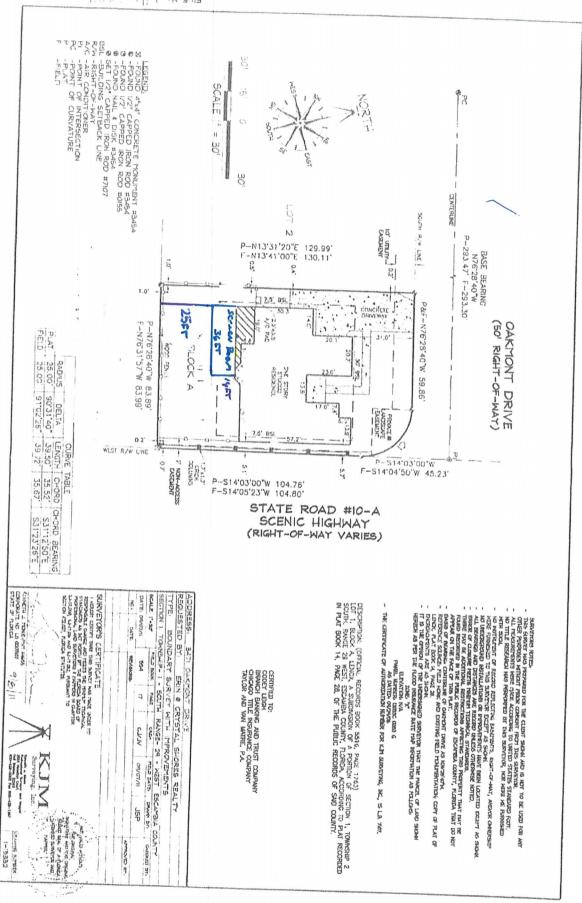





FW: Approval of Jimbo Rogeers sunroom addition setback lines.

jr3838 <jr3838@verizon.net>

Mon, May 24, 1:13 PM

To: Leon Locklear < leon@titansunrooms.com>

Fyi

Sent from my Verizon, Samsung Galaxy smartphone

----- Original message -----

From: mayesde@gmail.com

Date: 5/24/21 12:05 PM (GMT-06:00)
To: Jimbo Rogers < jr3838@verizon.net>

Cc: David Mayes <mayesde@bellsouth.net>, David Mayes <mayesde@gmail.com>

Subject: Approval of Jimbo Rogeers sunroom addition setback lines.

Jimbo Rogers,

The Lenox Architectural Control Committee has approved your waiver for a 24 foot setback from the rear lot line for your sunroom addition per the attached drawing.

Consider this your official notice in writing of the approval.

David Mayes, President


Lenox Homeowner's Association

Rogers HOA surevy_000056.pdf


#4





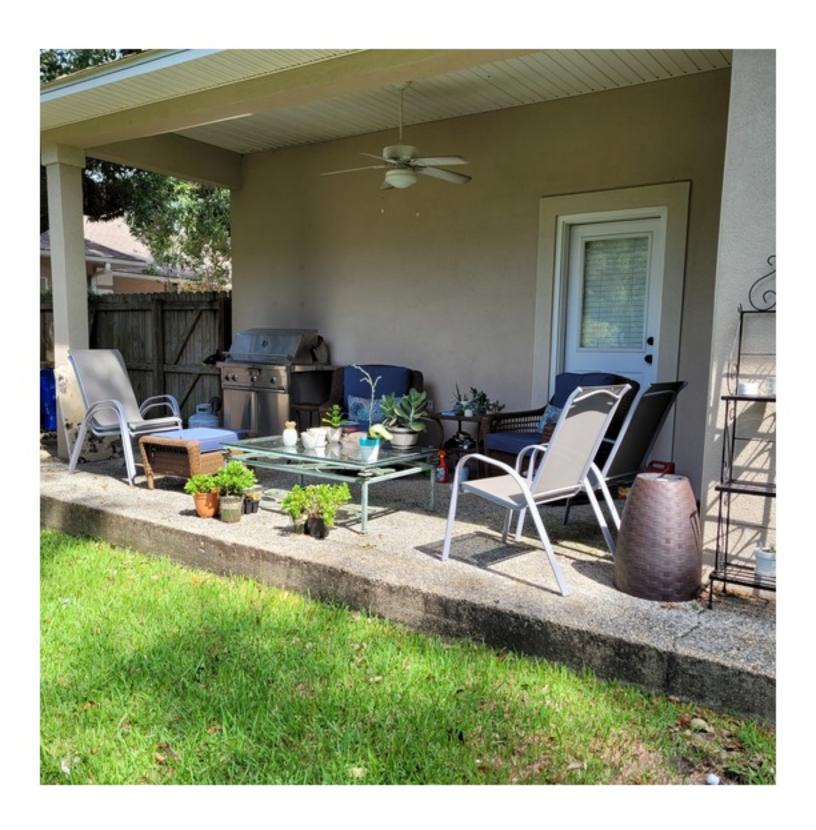



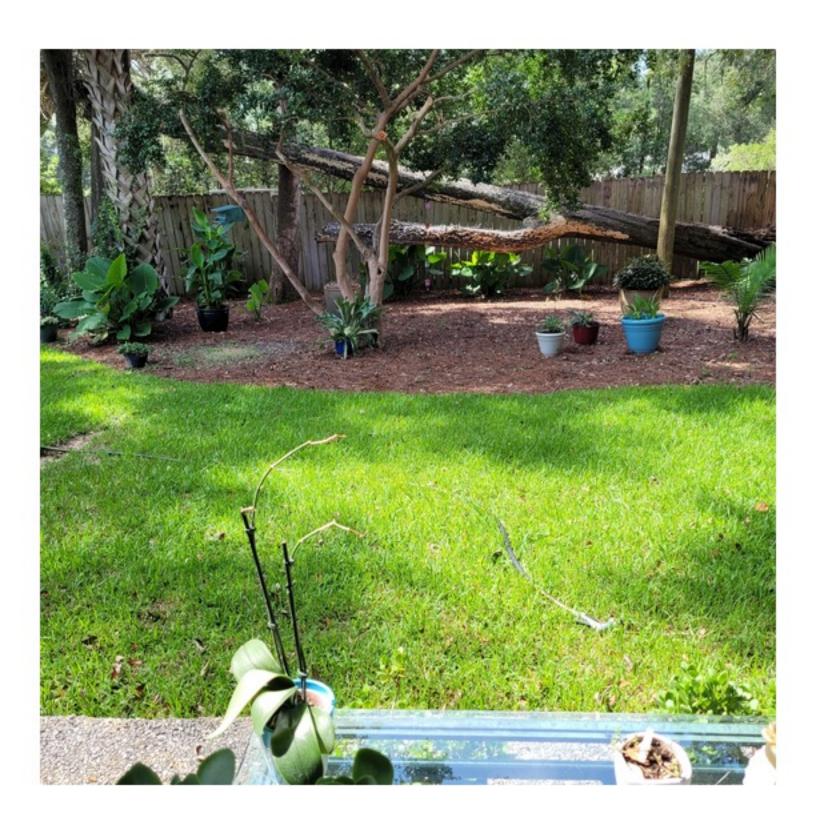





City of Pensacola

Memorandum

File #: 21-00777 Zoning Board of Adjustments 9/15/2021

TO: Zoning Board of Adjustments Members

FROM: Leslie Statler, Senior City Planner

DATE: 9/8/2021

SUBJECT:

ZBA 2021-05 1602 E. Brainerd Street R-1AA

BACKGROUND:

Mr. Dean Dalrymple of Dalrymple Sallis Architecture is requesting two variances: (1) To reduce the west side yard setback from the required 6 FT to 4 FT 2 INCHES to accommodate a master bedroom addition. This addition would continue the exiting plane of the home.

(2) To reduce the east side setback from the required 6 FT to 2 FT 2 INCHES to accommodate an open uncovered deck.



A	Zoning Board of Adjustment
	Architectural Review Board
	Planning Board
	Gateway Review Board

VARIANCE APPLICATION

A COMPLETE APPLICATION SHALL INCLUDE THE FOLLOWING:

A.	One (1) cop	y of this completed	application form.	(Please type or	print in ink.)
----	-------------	---------------------	-------------------	-----------------	----------------

B. Site plan and/or survey showing the following details:*

- Abutting street(s)
- 2. Lot dimensions and yard requirements (setbacks)
- 3. Location and dimensions of all existing structures
- 4. Location and dimensions of all proposed structures and/or additions
- 5. Dimension(s) of requested variance(s)
- C. Other supporting documentation (drawings, photographs, etc) to support request(s).*
- D. A non-refundable application fee of \$500.00.

2. Describe the special condition(s) existing on this property which create(s) the need for the variance(s), but which are not applicable to other properties in the same district and which are not the results of the applicant's actions:

The existing home is placed on the lot long before the LDC requirements and thus, the front and side

^{*} The Applicant must provide fourteen (14) copies of any documents larger than 8½ x 11 or in color.

Maximum page size for all submitted material should be 11" x 17" to allow for processing and distribution.

yard setbacks are exce	eeded by the existing home.	
right commonly enjoyed By continuing the line of	quested variance(s) is/are necessary to ed by other property owners in the same of the existing residence, we are respection be building a unified whole	
rights of others in the	vicinity: w addition to the structure will align with o	other side yards on the block, and
As City makers, we see	condition(s) may justify the proposed veit important to create pleasant rear yard ce allows our design to accomplish this v	spaces that compliment existing
		Application Date: 8/25/2021
Applicant:	E. Dean Dalrymple	
Applicant's Address:	503 E. Government St Pensacola, FL 3	2502
Email:	dean@datect.com	Phone: (850) 470-6399
Applicant's Signature:	work	
Property Owner:	Matt Comerford	
Property Owner's Address:	1602 E. Brainerd St Pensacola, FL	
Email:	mcomerford@moretteco.com	Phone: (850) 393-5119
Property Owner's Signature:		-

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Variance Application




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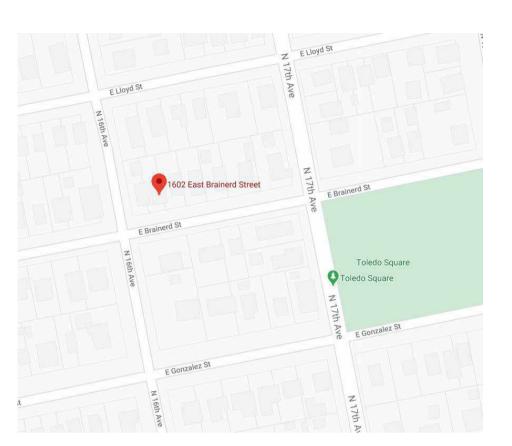
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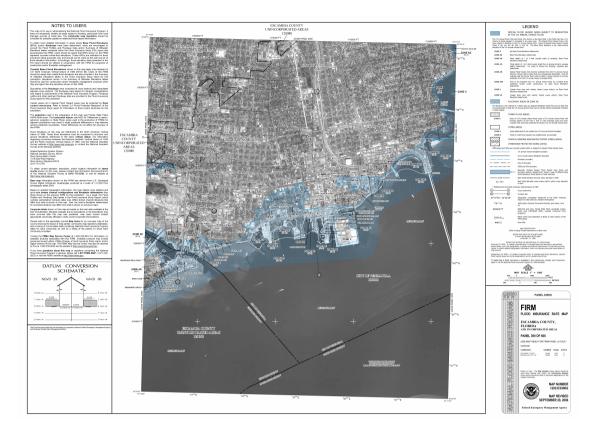
COMERFORD RENOVATION

RENOVATION OF RESIDENCE

1602 E. BRAINERD ST.






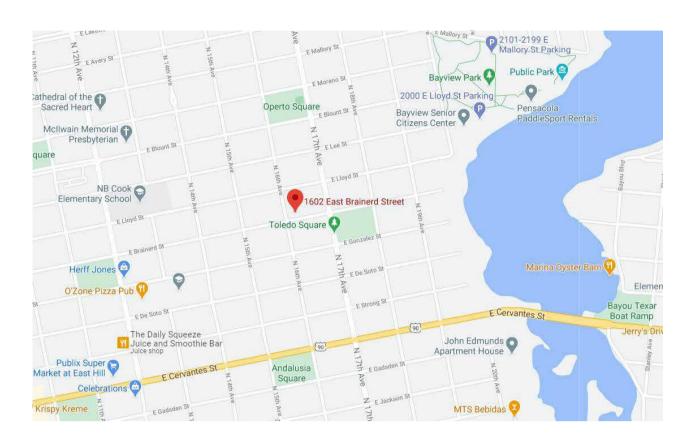

VICINITY MAP SITE MAP

FEMA FLOOD MAP

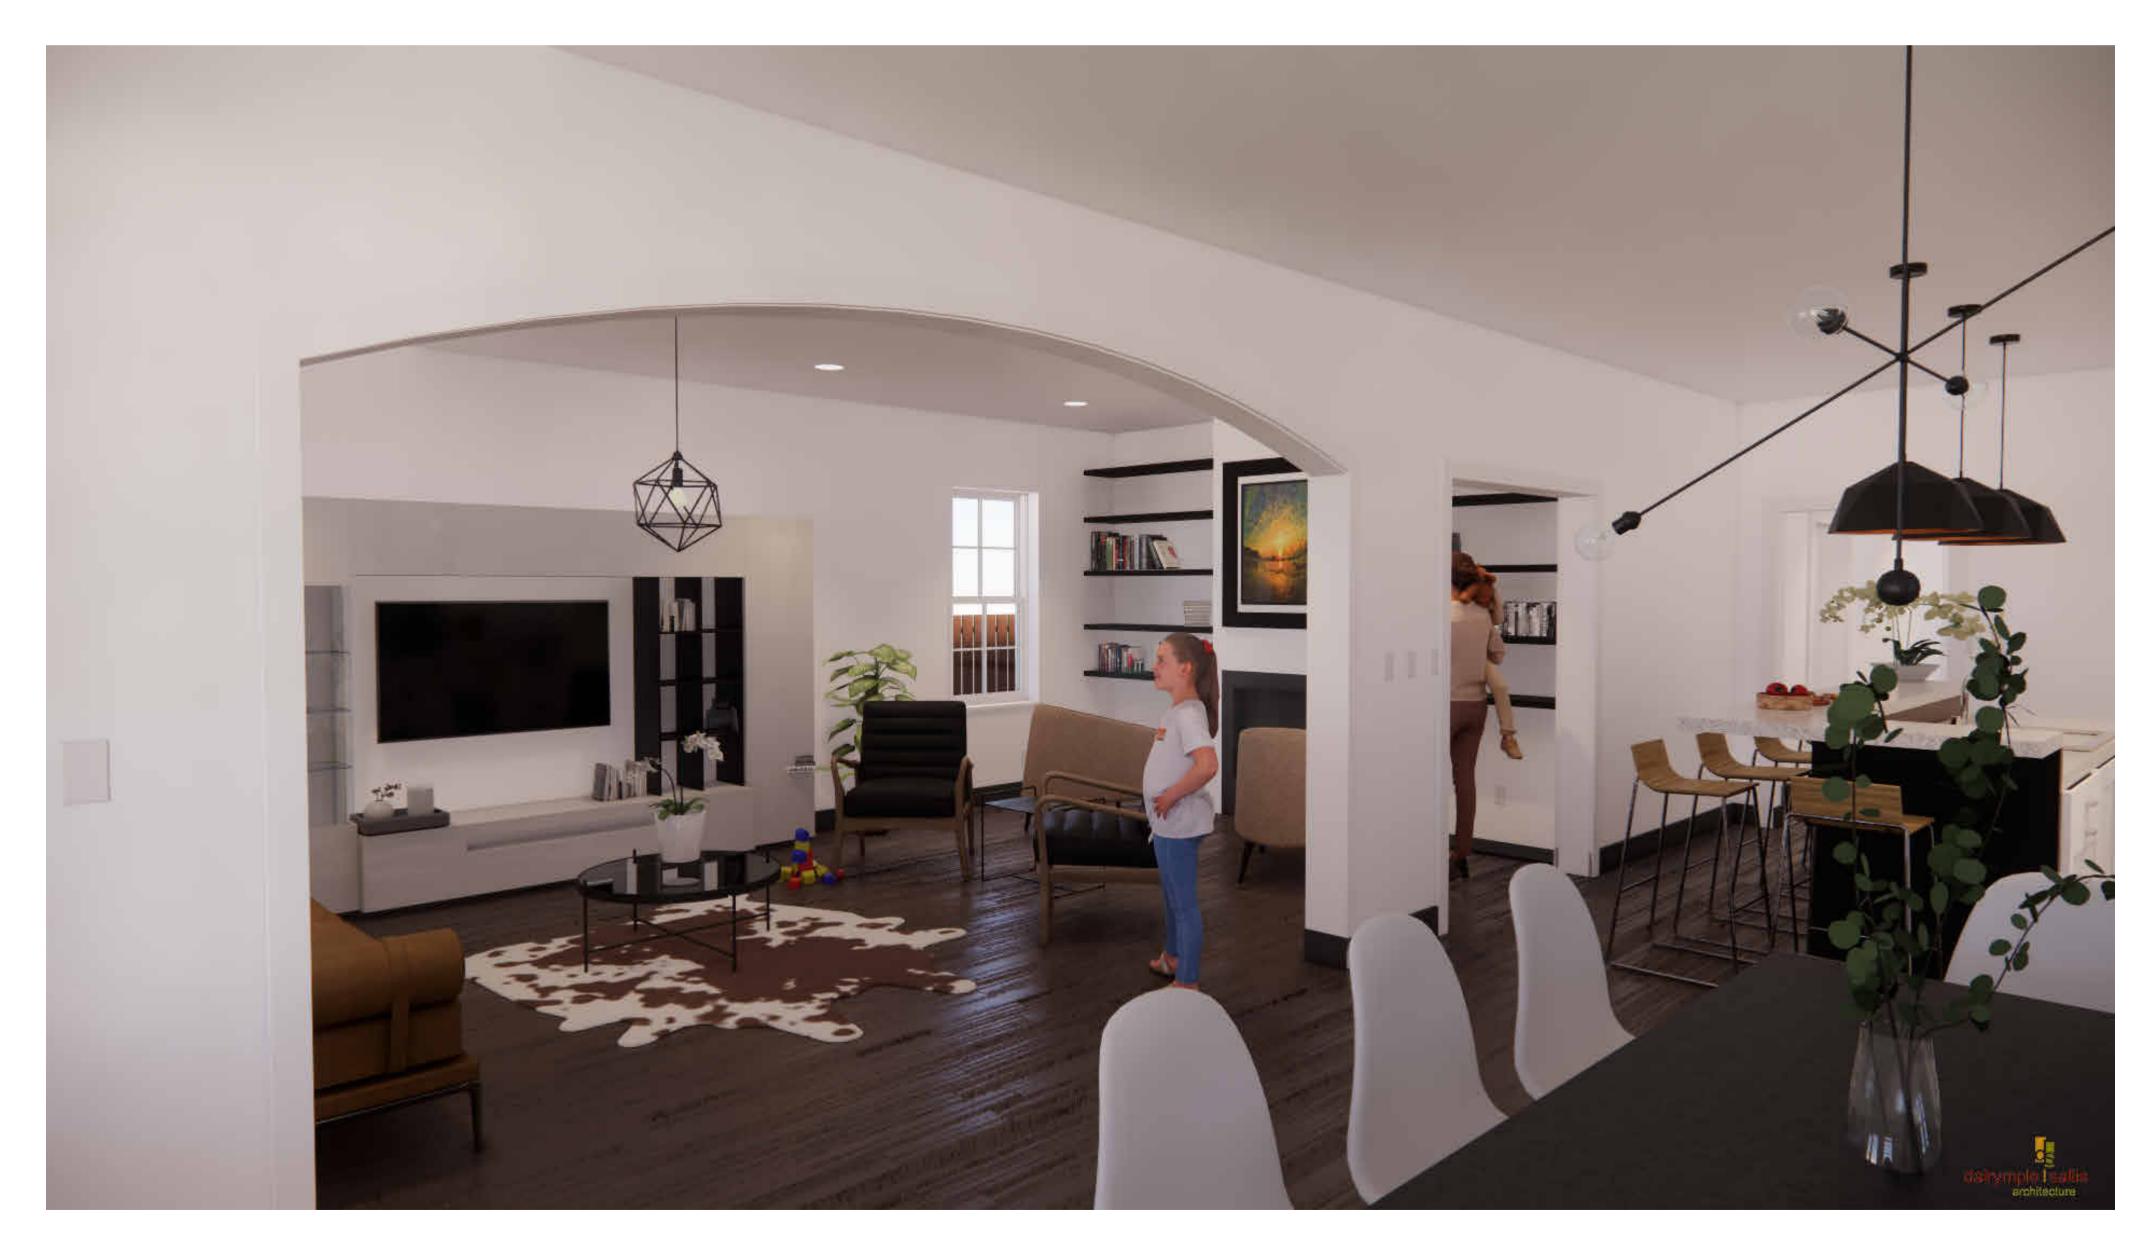

NOTE: ALL 3D VIEWS ARE CONCEPTUAL

BUILDING DATA

APPLICABLE CODES:
2020 FLORIDA BUILDING CODE, RESIDENTIAL FLORIDA FIRE PREVENTION CODE, 7th EDITION

TYPE VB: UNPROTECTED, UNSPRINKLERED

OCCUPANCY CLASSIFICATION: RESIDENTIAL (R-3) - SINGLE FAMILY DWELLING UNIT

ZONED: R-1AA

FLOOD ZONE: X

PHYSICAL PROPERTIES: BUILDING HEIGHT:

NO. OF STORIES:

22'-9"

PROJECT TEAM:

ARCHITECT OF RECORD :
J. SCOTT SALLIS, AIA scott@dalsal.com
DALRYMPLE | SALLIS ARCHITECTURE 503 E. GOVERNMENT ST. PENSACOLA, FL 32502 (850) 470-6399


BU	ILDING AR	EA TO	TALS
Name	LEVEL	AREA	COMMENTS
GROUND LEVE	ïL		
EXISTING GROUND FLOOR	GROUND LEVEL	1,589 SF	
ADDITION GROUND FLOOR	GROUND LEVEL	401 SF	
SECOND LEVE	L		
EXISTING SECOND FLOOR	SECOND LEVEL	291 SF	
TOTAL BUILDIN	IG AREA (CONDITIONED)	2,280 SF	


	NDEX OF DRAWINGS	
Sheet Number	Sheet Title	Rev.#
General		
G001	TITLE SHEET	
Structural		
S001	STRUCTURAL NOTES AND DIAGRAMS	
S101	FOUNDATION & FLOOR FRAMING PLAN	
S102	ROOF FRAMING PLAN & DETAILS	
Architectural		
A001	SITE AND ROOF PLAN	1
A010	FIRST AND SECOND FLOOR DEMO PLANS	
A101	NEW WORK FIRST AND SECOND FLOOR PLANS	
A102	FIRST AND SECOND FLOOR RCP/LIGHTING	
A201	EXTERIOR ELEVATIONS	
A202	EXTERIOR ELEVATIONS	
A301	BUILDING SECTIONS	
A302	WALL SECTIONS	
A401	INTERIOR ELEVATIONS	
A601	SCHEDULES AND DIAGRAMS	
A701	3D RENDERED PLAN VIEWS	
A702	3D INTERIOR PERSPECTIVE VIEWS	


GENERAL NOTES


- TO THE BEST OF OUR KNOWLEDGE, THESE DRAWINGS COMPLY WITH THE
- APPLICABLE REQUIREMENTS OF THE FLORIDA BUILDING CODE, 2020 EDITION CONTRACTOR TO COMPLY WITH REQUIREMENTS OF THE FLORIDA BUILDING CODE AND ALL OTHER APPLICABLE FEDERAL, STATE AND LOCAL CODES, STANDARDS,
- REGULATIONS AND LAWS.
- CONTRACTOR TO REVIEW ALL CONTRACT DOCUMENTS, DIMENSIONS AND SITE CONDITIONS AND COORDINATE WITH FIELD DIMENSIONS AND PROJECT SHOP DRAWINGS PRIOR TO CONSTRUCTION. REPORT ANY DISCREPANCIES IN WRITING TO ARCHITECT, DO NOT CHANGE SIZE OR DIMENSIONS OF STRUCTURAL MEMBERS
- WITHOUT WRITTEN INSTRUCTIONS FROM THE ARCHITECT OF RECORD. ANY DISCREPANCIES. OMISSIONS OR VARIATIONS NOTED IN THE CONSTRUCTION DOCUMENTS OR DISCOVERED DURING CONSTRUCTION SHALL BE IMMEDIATELY SHALL BE RESPONSIBLE FOR ALL ASSUMPTIONS OF CONSTRUCTION DOCUMENTS
- NOT VERIFIED IN WRITING BY THE ARCHITECT OF RECORD. PROTECT EXISTING FACILITIES. STRUCTURES AND UTILITY LINES FROM ALL DAMAGE. EACH CONTRACTOR SHALL PROTECT HIS WORK, ADJACENT PROPERTY AND THE PUBLIC. EACH CONTRACTOR IS SOLELY RESPONSIBLE FOR DAMAGE OR
- INJURY DUE TO HIS ACT OR NEGLECT. THE CONTRACTOR IS SOLELY RESPONSIBLE FOR JOB SAFETY AND CONSTRUCTION
 - PROCEDURES. DO NOT SCALE DRAWINGS; USE DIMENSIONS.
- DETAILS LABELED "TYPICAL DETAILS" ON THE DRAWINGS APPLY TO ALL SITUATIONS THAT ARE THE SAME OR SIMILAR TO THOSE SPECIFICALLY DETAILED. SUCH DETAILS APPLY WHETHER OR NOT THEY ARE KEYED IN AT EACH LOCATION. QUESTIONS REGARDING APPLICABILITY OF TYPICAL DETAILS SHALL BE RESOLVED BY THE
- PRODUCT SUBSTITUTION SHALL BE MADE SUBJECT TO FULL COMPLIANCE WITH THE CRITERIA NOTED HEREON, ANY SUCH SUBSTITUTION SHALL BE SUBJECT TO PRIOR APPROVAL BY THE DESIGN PROFESSIONAL AND THE LOCAL BUILDING AUTHORITY
- HAVING JURISDICTION. PRIOR TO COMMENCEMENT OF THE WORK, PROVIDE THE ARCHITECT WITH A PROPOSED SUBMITTAL SCHEDULE. ALLOW, AT MINIMUM, (12) BUSINESS DAYS FOR EACH SUBMITTAL REVIEW. NO EXTENSION OF THE CONTRACT TIME OR INCREASE IN THE CONTRACT SUM WILL BE AUTHORIZED BECAUSE OF FAILURE TO TRANSMIT SUBMITTALS ENOUGH IN ADVANCE OF THE WORK TO PERMIT PROCESSING, INCLUDING RESUBMITTALS.
- COMPLY WITH 2021 FBC, RESIDENTIAL EDITION R301.2.1.2 FOR RESIDENTIAL WORK OR 2021 FBC 1609.1.2 FOR COMMERCIAL WORK REGARDING OPENING PROTECTION. FOR R-3 OCCUPANCIES ONLY, OPTION TO PROVIDE FLORIDA PRODUCT APPROVED IMPACT RESISTANT GLAZING PRODUCT, OR WIND LOAD APPROVED WINDOWS PROTECTED WITH FLORIDA PRODUCT APPROVED OPENING PROTECTION SYSTEM. IF LATTER OPTION IS USED, PROVIDE (2) COPIES OF MARKED INSTALLATION INSTRUCTIONS FOR ANCHOR SIZE, SPACING, MOUNTING TYPE, ETC.




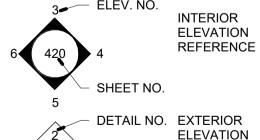

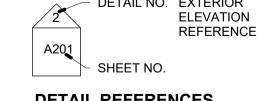

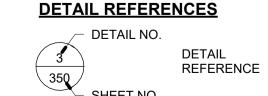

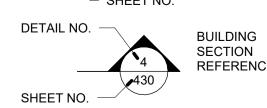

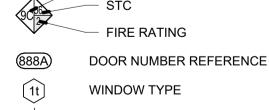


DATUM ELEVATION CENTERLINE COLUMN GRID NUMBER

Room name ROOM TAG

(11'-8") CEILING HEIGHT - ABOVE FIN. FLOOR **REVISION NUMBER REFERENCE**

/1\ REVISION NO.

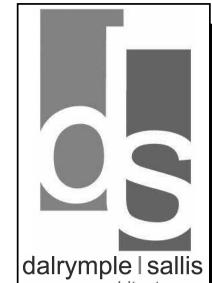

503 E. Government St

v: 850-470-6399 f: 850-470-6397 www.dalsal.com AR 0016385

Pensacola, FL 32502

THIS DOCUMENT SHOWS ORIGINAL AN UN-PUBLISHED WORK OF THE ARCHITEC AND MAY NOT BE DUPLICATED IN ANY



PERMIT SET

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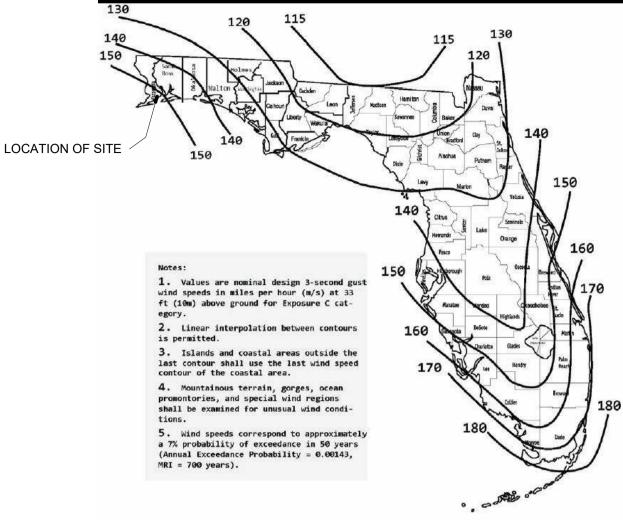
DRAWN BY: CHECKED BY SRJ JSS ISSUE DATE: 06-22-21

REVISIONS: No. Desc.


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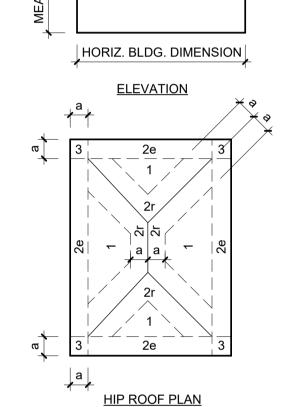
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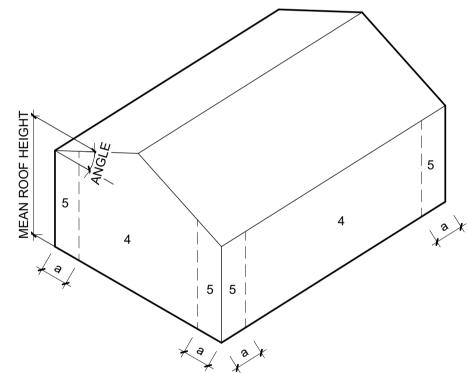
FLORIDA WIND SPEED MAP; RISK CATEGORY II



COMPONENTS AND CLADDING WIND LOADS





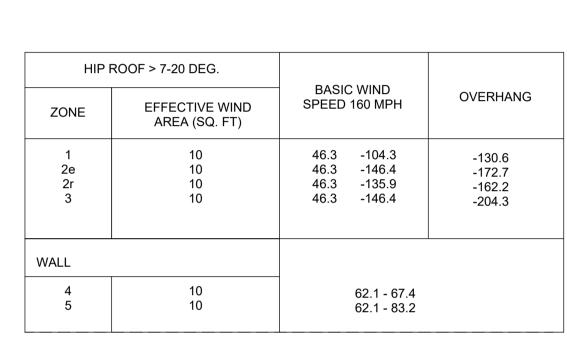

COMPONENTS AND CLADDING WALLS

NOTE: VALUES IN TABLE SHALL BE MULTIPLIED BY 0.6 TO <u>ACHIEVE ALLOWABLE STRESS DESIGN (ASD) PRESSURES</u>

ULTIMATE WIND PRESSURE TABLE NOTES: LINEAR INTERPOLATION FOR INTERMEDIATE VALUES OF EFFECTIVE AREAS IS ACCEPTABLE. OTHERWISE: USE THE LOAD ASSOCIATED WITH THE LOWER EFFECTIVE AREA.

ULTIMATE WIND LOAD PRESSURES ARE FOR USE IN LOAD COMBINATIONS LISTED IN FBC 2020 AND ASCE 7-16. THESE COMBINATIONS ARE LISTED IN FBC SECTION 1605 AND INCLUDE A WIND LOAD FACTOR OF 0.6 USING ALLOWABLE STRESS DESIGN. THEREFORE, ULTIMATE PRESSURES LISTED IN THE LOAD TABLE MAY BE REDUCED 40% WHEN USING ALLOWABLE STRESS DESIGN. REDUCED LOADS ARE THE "WORKING LOADS."

ALL EDGES OF WALL SHEATHING ARE BLOCKED. ALL EDGES OF ROOF SHEATHING ARE BLOCKED IN ZONES 2 AND 3 ONLY ORIENT WALL SHEATHING HORIZONTALLY. ROOF SHEATHING SHALL BE FASTENED W/ 8d COMMON RINGSHANK 0.131" X 2 1/2" OR 10d COMMON RINGSHANK 0.12" X 3".

SHEATHING NAILING REQUIREMENTS				
ZONE	NAIL SIZE	SPACING	LOCATION	
1	8d	3"	PERIMETER	
'	8d	6"	FIELD	
2	8d	3"	PERIMETER	
2	8d	6"	FIELD	
3	8d	3"	FIELD & PERIMETER	
4	8d	4"	PERIMETER	
4	8d	8"	FIELD	
5	8d	4"	PERIMETER	
5	8d	8"	FIELD	
OVERHANG	8d	4"	FIELD & PERIMETER	

GENERAL NOTES

- TO THE BEST OF OUR KNOWLEDGE, THE STRUCTURAL PLANS AND SPECIFICATIONS COMPLY WITH THE APPLICABLE REQUIREMENTS OF THE FLORIDA BUILDING CODE, 2020 EDITION.
- THE STRUCTURAL DOCUMENTS ARE TO BE USED IN CONJUNCTION WITH THE ARCHITECTURAL DOCUMENTS. USE THESE NOTES IN CONJUNCTION WITH THE SPECIFICATIONS. IF A CONFLICT EXISTS, THE MORE STRINGENT GOVERNS. SEE ARCHITECTURAL AND MECHANICAL DRAWINGS FOR SIZE AND LOCATION OF
- OPENINGS IN STRUCTURE NOT SHOWN ON STRUCTURAL DRAWINGS. REVISIONS ARE IDENTIFIED BY A REVISION NUMBER WITHIN A TRIANGLE. ALL REVISIONS ISSUED ON A SINGLE DATE WILL BE IDENTIFIED BY THE SAME REVISION NUMBER ISSUED CONSEQUENTLY
- DESIGN LOADS AND CRITERIA: FLOOR LIVE LOAD FLOOR DEAD LOAD 10 PSF PARTITION LOAD **20 PSF** ROOF LIVE LOAD 20 PSF 10 PSF ROOF DEAD LOAD
- 60 PSF DECK LIVE LOAD WIND CRITERIA FBC 2020 ASCE 7-16 RISK CATEGORY BASIC WIND SPEED 160 MPH (3-SECOND GUST)
- **ENCLOSED** STRUCTURE TYPE INTERNAL PRESSURE COEFF. +/- 0.18 MEAN ROOF HEIGHT

ROOF SLOPE: 4/12 **WOOD FRAMING AND SHEATHING**

EXPOSURE CATEGORY

- OSB IS NOT CONSIDERED AN ACCEPTABLE SUBSTITUTE FOR PLYWOOD SHEATHING
- ALL WOOD IN CONTACT WITH CONCRETE, CONCRETE BLOCK, OR EXPOSED TO EXTERIOR ELEMENTS AND LEFT UNFINISHED SHALL BE PRESSURE
- DO NOT PAINT PRESSURE TREATED WOOD WHEN MOISTURE CONTENT IS
- ALL STRUCTURAL GRADE LUMBER SHALL BE SOUTHERN YELLOW PINE, No. 2
- NOTCHES ON THE END OF JOISTS SHOULD NOT EXCEED ONE FOURTH OF THE JOIST DEPTH. HOLES BORED IN JOISTS SHALL NOT BE WITHIN 2" OF THE TOP OR BOTTOM OF THE JOIST, AND THE DIAMETER OF ANY SUCH HOLE SHALL NOT EXCEED ONE THIRD THE DEPTH OF THE JOIST. NOTCHES IN THE TOP OR BOTTOM OF THE JOIST SHALL NOT EXCEED ONE SIXTH THE DEPTH AND SHALL NOT BE LOCATED IN THE MIDDLE THIRD OF THE SPAN.
- JOISTS SHALL BE SUPPORTED LATERALLY AT THE ENDS AND AT EACH SUPPORT BY SOLID BLOCKING EXCEPT WHERE THE ENDS OF A JOIST ARE NAILED TO A HEADER, BAND OR RIM JOIST OR TO AN ADJOINING STUD OR BY OTHER MEANS. BLOCKING SHALL NOT BE LESS THAN 2" IN THICKNESS AND THE FULL DEPTH OF THE JOIST.
- WALL SHEATHING: 15/32" (SPAN RATING 32/16) APA RATED PLYWOOD. SHEATHING SHALL BE NAILED TO WALL STUDS WITH 8d COMMON RINGSHANK 0.131" X 2 1/2" OR 10d COMMON RINGSHANK 0.12" X 3": SPACING 4" EDGE AND 8" FIELD, UNLESS NOTED OTHERWISE ON THE
- 2x BLOCKING SHALL BE ADDED AT PANEL JOINTS, AT CEILING BEARING AND AT MIDSPAN MINIMUM
- WHERE SPECIFIED, SHEATHING SHALL BE INSTALLED ON BOTH SIDES OF WALL PANELS. SHEATHING JOINTS SHALL BE STAGGERED EACH SIDE OF WALL.
- PLYWOOD SHEATHING SHALL BE MINIMUM 4-PLY WHILE MEETING THE SPECIFICATIONS ABOVE.
- ROOF SHEATHING: 19/32" (SPAN RATING 40/20) APA RATED PLYWOOD. SHEATHING SHALL BE NAILED TO ROOF MEMBERS WITH 8d COMMON RINGSHANK NAILS (0.131" x 2-1/2") OR 10d RINGSHANK NAILS (0.12" x 3"); SPACING 3" EDGE AND 6" FIELD.
 - PLYWOOD SHEATHING SHALL BE MINIMUM 4-PLY WHILE MEETINGS

PRE-ENGINEERED WOOD TRUSSES

- WOOD STUD TRUSSES AND REQUIRED BRACING SHALL BE DESIGNED BY A PROFESSIONAL ENGINEER REGISTERED IN THE STATE OF FLORIDA AND EXPERIENCED IN THE DESIGN OF PRE-ENGINEERED WOOD STRUCTURES. THE ENGINEER SHALL SEAL, SIGN, AND DATE THE SHOP DRAWINGS AND
- DESIGN SHALL BE IN ACCORDANCE WITH ANSI/TPI 1-2002 "National Design Standard for Metal Plate Connected Wood Truss Construction"
- TOP AND BOTTOM CHORDS SHALL BE PROVIDED WITH THE SHAPES AND CONFIGURATIONS INDICATED ON THE DRAWINGS. ARRANGEMENT OF WEB MEMBERS TO BE AT THE DISCRETION OF THE SPECIALTY DESIGN ENGINEER. AT TRUSS JOINTS, CENTERLINES OF MEMBERS SHALL INTERSECT AT A COMMON POINT OR ECCENTRICITIES SHALL BE CONSIDERED IN THE
- THE WOOD JOIST & TRUSS FABRICATORS SHALL SUBMIT CERTIFIED LETTERS TO THE ARCHITECT STATING THAT HE HAS RECEIVED SPRINKLER DRAWINGS. THE WOOD JOIST & TRUSS FABRICATORS SHALL DESIGN THEIR PRODUCTS FOR LOADING IMPOSED BY SPRINKLER MAIN SUPPLY LINES AND BRANCHES. THE WOOD JOIST & TRUSS FABRICATORS SHALL BE SOLELY RESPONSIBLE FOR THE ADEQUACY OF THE JOIST & TRUSS DESIGNS RESPECTFULLY. IF SPRINKLER DRAWINGS ARE NOT AVAILABLE. THE JOIST & TRUSS FABRICATORS SHALL USE A DESIGN LOAD OF 3 PSF APPLIES AS UNIFORM OR CONCENTRATED LOADS WHICH CAN BE SUPPORTED BY THEIR
- **SYSTEMS** TRUSSES SHALL BE DESIGNED FOR THE DEAD WEIGHT OF THE TRUSSES AND BRACING PLUS THE LOADS GIVEN IN NOTE 4 OF THE GENERAL NOTES. TRUSS STORAGE HANDLING RESTRAINING AND BRACING SHALL BE PER

ENGINEERED WOOD PRODUCTS

LVL BEAMS SHALL BE MANUFACTURED BY APA MEMBER MANUFACTURER TO APA

BUILDING COMPONENT SAFETY INFORMATION GUIDELINES AS PRODUCED

- USE LVLS CONFORMING TO ASTM D 5456 AND ABLE TO WITHSTAND THE DESIGN LOADS INDICATED. REFER TO STRUCTURAL PLANS FOR SIZING. LENGTH AS REQUIRED FOR SPAN AND BEARING. DO NOT STORE ENGINEERED WOOD PRODUCTS IN DIRECT CONTACT WITH THE
- GROUND. STACK FLATWISE
- MINIMUM BEARING LENGTH: 3", ENDS; 3", INTERMEDIATE LVL BEAMS SHALL HAVE MINIMUM MATERIAL PROPERTIES:

BY THE TRUSS PLATE INSTITUTE.

HORIZONTAL SHËAR:

MODULUS OF ELASTICITY

- ALLOWABLE BENDING STRESS: Fb = 2,900 PSICOMPRESSION [⊥] TO GRAIN: $Fc^{\perp} = 750 PSI$ COMPRESSION TO GRAIN: Fc = 3,200 PSI
- GLUE LAM BEAMS (PRESSURE TREATED) SHALL HAVE THE MINIMUM MATERIAL

PROPERTIES: **ALLOWABLE BENDING STRESS:** Fb = 2,400 PSICOMPRESSION [⊥] TO GRAIN: $Fc^{\perp} = 740 \, PSI$ COMPRESSION TO GRAIN: Fc = 1,650 PSI HORIZONTAL SHËAR: Fv = 300 PSI

MODULUS OF ELASTICITY: E = 1.8x10^6 PSI DESIGN MATERIAL: 24F-V8-24F-1.8E SOUTHERN PINE 24F-V5M1 (PRESSURE TREATED)

Fv = 285 PSI

 $E = 2x10^{6} PSI$

HARDWARE REQUIREMENTS:

- ALL NAILS SHALL BE COMMON.
- ALL HARDWARE SHALL BE INSTALLED PER ALL MANUFACTURERS SPECIFICATIONS.
- ALL HARDWARE AND NAILS SHALL BE HOT-DIPPED GALVANIZED OR STAINLESS STEEL (A304/A316) WHEN EXPOSED TO WEATHER AND WATER. THREADED RODS SHALL MEET ASTM A307 GRADE A SPECIFICATION
- REQUIREMENTS OR BETTER STAINLESS STEEL THREADED RODS SHALL MEET A304 OR A316
- SPECIFICATION REQUIREMENTS BOLTS SHALL MEET ASTM A307 SPECIFICATION REQUIREMENTS (UNLESS
- NOTED OTHERWISE) ALL WASHERS WITHIN WALL SYSTEMS SHALL BE 3"x3"x1/4". ALL WASHERS WITHIN HORIZONTAL CONNECTIONS SHALL BE 2"x2"x1/4" OR 3"
- ALL COUPLING NUTS SHALL MEET ASTM A563 GRADE A SPECIFICATION REQUIREMENTS OR BETTER.

SHALLOW FOUNDATIONS

- FOUNDATION DESIGN IS BASED ON AN ASSUMED ALLOWABLE SOIL BEARING CAPACITY OF 1,500 PSF FOR FOOTINGS.
- SOIL COMPACTION SHALL BE FIELD CONTROLLED BY A SOILS ENGINEER OR TESTING LABORATORY.
- THE CONTRACTOR IS RESPONSIBLE FOR THE DISPOSAL OF ALL ACCUMULATED WATER FROM EXCAVATIONS AND DEWATERING OPERATIONS IN SUCH A WAY AS NOT TO CAUSE INCONVENIENCE TO THE
- WORK AND DAMAGE TO THE STRUCTURAL ELEMENTS THE CONTRACTOR IS SOLELY RESPONSIBLE FOR ALL EXCAVATION PROCEDURES INCLUDING LAGGING, SHORING, AND PROTECTION OF ADJACENT PROPERTY, STRUCTURES, STREETS AND UTILITIES IN
- ACCORDANCE WITH THE REQUIREMENTS OF THE LOCAL BUILDING
- COMPACTED FILL UNDER SLABS, CONCRETE APRONS, PATIO PAVERS, AND OTHER NON-PERVIOUS SURFACES TO RECEIVE AN APPROVED TERMITE TREATMENT PER FBC 2304.12.

SLABS ON GRADE

- FOR SLABS ON GRADE, REINFORCE WITH W1.4xW1.4 / 6x6 WWF
- REINFORCEMENT. PLACE IN CENTER OF SLAB THICKNESS. INSTALL VAPOR BARRIER IN ACCORDANCE WITH ASTM E1643. CONTACT VAPOR BARRIER MANUFACTURER FOR WARRANTY INFORMATION AND INSTALLATION REVIEW PRIOR TO CONCRETE PLACEMENT
- 0.01 MAX PERMEANCE RATING. CLASS A STRENGTH. 15-MIL MINIMUM THICKNESS. BASIS OF DESIGN: STEGO WRAP BY STEGO INDUSTRIES, LLC
- WWW.STEGOINDUSTRIES.COM PLACE CRACK CONTROL JOINTS AT 12 FT. MAX. SO AS TO LIMIT CONCRETE PLACEMENT AREAS TO 144 SQ. FT. MAX. IN ALL FLOATING SLABS ON GRADE. DO NOT EXCEED A 2 TO 1 WIDTH TO LENGTH RATIO. CONTRACTOR MAY FLECT TO SUBMIT A CONTROL JOINT LAYOUT FOR ARCHITECT'S REVIEW PRIOR TO CONCRETE PLACEMENT
- SLAB FINISHES: EXTERIOR WALKING SURFACES - MEDIUM BROOM DRIVING SURFACES - MEDIUM BROOM **INTERIOR SURFACES - STEEL TROWEL**

REINFORCED CONCRETE

USE STRUCTURAL CONCRETE AND CONCRETING PRACTICES CONFORMING TO ACI-316 AND 301 AND PROPORTION CONCRETE IN ACCORDANCE WITH ACI-318 CH. 4 AND MEETING A MIN. ULTIMATE COMPRESSIVE STRENGTH IN 28 DAYS AS FOLLOWS:

FOOT	ING	3000 PSI
	GRADE BEAMS	3000 PSI
	POURED WALLS	5000 PSI ***
	COLUMNS	5000 PSI ***
	BEAMS & ELEVATED SLABS	5000 PSI ***
	ALL OTHER CONCRETE	5000 PSI ***
	*** UNLESS NOTED OTHERWIS	SE

WHERE CONCENTRATION OF REINFORCING STEEL HINDERS PROPER CONSOLIDATION OF CONCRETE, USE CONCRETE CONTAINING A SUPERPLASTICIZING (N.R.W.R.) ADMIXTURE, ASTM C494 TYPE F. SLUMP AFTER ADDITION OF SUPERPLASTICIZER SHALL BE 7"±1". IF CONCRETE IS PUMPED, SLUMP MAY BE INCREASED TO 6" AT THE TRUCK, PROVIDED THE SLUMP SPECIFIED IN NOTE 2 IS MAINTAINED AT THE DISCHARGE END. USE A MINIMUM 4-INCH PUMP, UNLESS PRE-

APPROVED BY ARCHITECT. TAKE CONCRETE SAMPLES FOR SLUMP AT

TRUCK AND AT DISCHARGE END. USE ASTM A-615 GR. 40 REINFORCING STEEL IN ALL RESIDENTIAL WORK & GR. 60 REINFORCING STEEL IN ALL COMMERCIAL WORK CONFORM TO ACI-301, ACI-315, ACI-318, AND CRSI "MANUAL OF STANDARD PRACTICE". ALL REINFORCING SHALL BE ACCURATELY PLACED, RIGIDLY SUPPORTED AND FIRMLY TIED IN PLACE WITH BAR SUPPORTS AND SPACERS IN ACCORDANCE WITH THE ABOVE REQUIREMENTS. PROVIDE CLASS 'B' LAP SPLICE FOR CONTINUOUS BARS, UNLESS NOTED OTHERWISE. LAP BOTTOM STEEL OVER SUPPORTS AND TOP STEEL AT MIDSPAN UNLESS OTHERWISE SPECIFIED. HOOK DISCONTINUOUS ENDS OF ALL TOP BARS AND ALL BARS IN WALLS, UNLESS NOTED OTHERWISE. USE 1" COVER OVER

REINFORCING EXCEPT AS

LLO	NS: .				
		BOTTO	<u>M</u>	<u>TOP</u>	SIDES
	FOOTING/PILECAP	3"	2"	3"	
+	BEAMS (U.O.N.)	1 1/2"	1 1/2"	1 1/2"	
	COLUMNS	-	-	1 1/2"	
	SLABS ON GROUND	2"	1"	2"	
	SLABS (OTHER THAN ON GROUND)	1"	1"	1"	
	POURED WALLS RETAINING FILL	-	-	2"	
	POURED WALLS ABOVE GROUND	-	-	1 1/2"	

USE PLAIN, COLD-DRAWN ELECTRICALLY-WELDED STEEL WIRE FABRIC CONFORMING TO ASTM A-185, SUPPLY IN FLAT SHEETS ONLY. LAP SPLICES SHALL BE MEASURED BETWEEN OUTERMOST CROSS WIRES OF EACH FABRIC SHEET AND SHALL BE NOT LESS THAN TWICE THE SPACING OF THE CROSS WIRES PLUS TWO (2) INCHES. SLEEVE ALL PIPES THROUGH SLABS INDIVIDUALLY. UNLESS APPROVED BY ARCHITECT. WHERE PIPES OR DUCTS PENETRATE SLABS, A MAX. OF TWO BARS EACH WAY MAY BE CUT, PROVIDED

SPLICE BARS ARE PLACED ALONGSIDE OPENING WITH EQUIVALENT AREA TO THE CUT BARS, WITH 36-BAR-DIA. LAP. PLACE ALL OPENINGS LARGER THAN 6" NOT SHOWN ON STRUCTURAL DRAWINGS AND ALL CONDUITS IN SLABS IN ACCORDANCE WITH ACI-318 CH. 6.3. PROVIDE 1 #5 X 6' EACH WAY PLACED DIAGONALLY AT MID-DEPTH AROUND ALL OPENINGS LARGE THAN 12", U.O.N.

<u>CONCRETE MASONRY</u>

- ALL MASONRY WORK IS TO CONFORM TO ACI 530 AND 530.1. USE CONCRETE MASONRY UNITS CONFORMING TO ASTM C90. PROVIDE I'm OF 1500 PSI (UNIT STRENGTH 1900 PSI). PERFORM fm AND C90 COMPLIANCE BY UNIT TEST METHOD. USE ONLY MASONRY UNITS THAT ARE A MIN. OF 50%
- OF SOLID USE TYPE "S" MORTAR IN ACCORDANCE WITH ASTM C270. USE 3/8" FULL-BEDDED JOINTS FOR ALL MASONRY UNITS. REMOVE MORTAR PROTRUDING INTO CELL CAVITIES THAT ARE TO BE REINFORCED AND GROUTED. ALLOW A MIN. OF 24 HOURS FOR MORTAR TO CURE BEFORE
- USE ALL GROUT CONFORMING TO ASTM C-476 WITH A MIN. COMPRESSIVE STRENGTH OF 3000 PSI IN 28 DAYS, TESTED IN ACCORDANCE WITH ASTM C1019. AGGREGATE TO CONFORM TO ASTM C404 FOR COARSE GROUT AND SLUMP OF 8" TO 11".
- FOR REINFORCED MASONRY USE STANDARD (9 GAGE CROSS AND SIDE RODS) LADDER TYPE HORIZONTAL JOINT REINFORCING IN EVERY OTHER COURSE UNLESS NOTED OTHERWISE. USE PREFABRICATED CORNERS AND TEES AT WALL INTERSECTIONS. OVERLAP DISCONTINUOUS ENDS A MIN. OF 12". HORIZONTAL REINFORCING SHALL CONFORM TO ASTM A-82. USE ASTM A-615 GRADE 40 REINFORCING STEEL (RESIDENTIAL) GRADE 60
- (COMMERCIAL USE PRESSURE-TREATED WOOD FOR ALL WOOD IN CONTACT WITH **MASONRY**

SHOP DRAWING SUBMITTALS

- THE FOLLOWING REQUIREMENTS IN NO WAY REDUCE OR LIMIT ANY ADDITIONAL REQUIREMENTS OF SPECIFICATIONS.
- REVIEW OF SUBMITTALS BY THE STRUCTURAL ENGINEER IS FOR GENERAL CONFORMANCE WITH THE DESIGN CONCEPT AS PRESENTED BY THE CONTRACT DOCUMENTS. NO DETAILED CHECK OF QUANTITIES OR DIMENSIONS WILL BE MADE. ONLY THOSE SHOP DRAWINGS REQUIRED BY THE CONTRACT DOCUMENTS TO BE SUBMITTED WILL BE REVIEWED. ALL OTHERS WILL BE RETURNED WITHOUT COMMENT.
- IN ACCORDANCE WITH THE SPECIFICATIONS, SUBMIT A COPY OF THE SHOP DRAWING SUBMITTAL REGISTER TO THE STRUCTURAL ENGINEER, SHOWING DATES OF SUBMITTAL FOR EACH SPECIFIC STRUCTURAL SECTION OF THE WORK, CONSISTENT WITH THE FOLLOWING CRITERIA
 - ALLOW ADEQUATE TIME FOR TRANSIT AND PROCESSING BEFORE FABRICATION. THE STRUCTURAL ENGINEER WILL REVIEW AN AVERAGE
 - SUBMITTAL WITHIN 10 WORKING DAYS OF RECEIPT BY THEM. SCHEDULE AND SUBMIT SHOP DRAWINGS FOR SPECIFIC COMPONENTS SUCH AS COLUMNS, FOOTINGS, ETC., IN THEIR ENTIRETY, SHOP DRAWINGS FOR SIMILAR FLOORS SHALL BE SUBMITTED IN THE SAME
 - SUBMIT SHOP DRAWINGS IN A TIMELY MANNER, CONSISTENT WITH THE
- ABOVE REQUIREMENTS ALL CHANGES AND ADDITIONS MADE ON RESUBMITTALS MUST BE CLEARLY FLAGGED AND NOTED. THE PURPOSE OF THE RESUBMITTALS MUST BE CLEARLY NOTED ON THE LETTER OF TRANSMITTAL. ARCHITECT / ENGINEER REVIEW WILL BE LIMITED TO THE ITEMS CAUSING THE RESUBMITTAL.
- DRAWINGS SHOP DRAWINGS NOT MEETING THE ABOVE CRITERIA OR SUBMITTED AFTER FABRICATION WILL NOT BE REVIEWED AND WILL BE RETURNED WITHOUT

DO NOT REPRODUCE THE CONTRACT DOCUMENTS FOR USE AS SHOP

- COMMENT RESPONSIBILITIES OF DETAILERS AND
- **FABRICATORS** GENERAL- SUBMIT SHOP DRAWINGS AND ANY OTHER SPECIAL INFORMATION NECESSARY FOR PROPER FABRICATION, ERECTION, AND
- ELEVATIONS, AND SECTIONS. CLEARLY SHOW ANCHORAGES, CONNECTIONS, AND ACCESSORY ITEMS. THE DETAILER MUST INTERPRET THE CONTRACT DOCUMENTS AND CLEARLY CONVEY THIS INTERPRETATION TO THE FIELD IN THE FORM OF PLACING OR ERECTION

PLACEMENT OF STRUCTURAL FABRICATIONS. INCLUDE PLANS.

- CONCRETE REINFORCING DETAILER- PROVIDE PLACING DRAWINGS FOR FABRICATION AND PLACING OF REINFORCING STEEL. THESE DRAWINGS SHALL INCLUDE, BUT ARE NOT LIMITED TO THE FOLLOWING: BAR LISTS, SCHEDULES, BENDING DETAILS, PLACING DETAILS, PLACING PLANS, AND PLACING FLEVATIONS
- CLEARLY SHOW ELEVATIONS OF ALL BEARING AND SHEAR WALLS. INDICATE CONTROL JOINTS, EXPANSION JOINTS, LINTELS, CONCRETE BOND BEAMS, AND OPENINGS, DETAILS OF ALL REINFORCING WITH LOCATIONS OF SPLICES AND HOOKS,
- CLEARLY SHOW BEAM ELEVATIONS AND SECTIONS, INDICATE BAR LENGTHS, HOOKS, STIRRUP SPACING, LAP SPLICES, OFFSETS, AND LOCATION OF BARS WITH RESPECT TO ALL SUPPORTS. CLEARLY SHOW COLUMN ELEVATIONS AND SECTIONS. INDICATE DOWELS, OFFSETS, LAP SPLICES, AND TIES. PLAN SECTIONS OF ALL COLUMNS MUST CLEARLY BE SHOWN.
- TO COLUMN CONNECTIONS. CLEARLY SHOW FOUNDATION REINFORCING. INDICATE BAR LENGTHS, LOCATION AND SPLICES OF CONTINUOUS BARS, AND

CLEARLY SHOW ELEVATION, SECTIONS, AND DETAILS OF ALL BEAM

CLEARLY SHOW LOCATIONS OF ALL DOWELS ON PLAN. INDICATE

FOOTING STEP LOCATIONS AND PROVIDE DETAILS. FOR ADDITIONAL CRITERIA APPLICABLE TO SHOP DRAWINGS REQUIRING ENGINEERING INPUT BY A SPECIALTY ENGINEER, SEE BELOW.

SHOP DRAWINGS REQUIRING **ENGINEERING INPUT BY SPECIALTY ENGINEER**

SHALL BE:

- A FLORIDA REGISTERED PROFESSIONAL ENGINEER WHO SPECIALIZES IN AND WHO UNDERTAKES THE DESIGN OF STRUCTURAL COMPONENTS OR STRUCTURAL SYSTEMS INCLUDED IN A SPECIFIC SUBMITTAL PREPARED FOR THIS PROJECT.
- AN EMPLOYEE OR OFFICER OF A FABRICATOR.
- AN EMPLOYEE OR OFFICER OF AN ENTITY SUPPLYING COMPONENTS TO A FABRICATOR.
- AN INDEPENDENT CONSULTANT RETAINED BY THE FABRICATOR OR
- THE FOLLOWING SYSTEMS AND COMPONENTS AS A MINIMUM REQUIRE FABRICATION AND ERECTION DRAWINGS WITH INPUT BY A SPECIALTY ENGINEER: PRE-ENGINEERED WOOD ROOF TRUSSES. THE SPECIALTY ENGINEER OR MANUFACTURER SHALL DESIGN, PROVIDE AND INSTALL THEIR COMPONENTS AND THE COMPONENT CONNECTIONS TO THE PRIMARY STRUCTURE PER THE WIND CRITERIA STATED IN THE
- GENERAL NOTES ON THIS SHEET OR THE CURRENT GOVERNING BUILDING CODES. WHICHEVER IS MORE STRINGENT. SUBMITTALS SHALL CLEARLY IDENTIFY THE SPECIFIC PROJECT AND APPLICABLE CODES, LIST THE DESIGN CRITERIA, AND SHOW ALL DETAILS AND PLANS NECESSARY FOR PROPER FABRICATION AND INSTALLATION. CALCULATIONS AND SHOP DRAWINGS SHALL IDENTIFY SPECIFIC PRODUCT
- UTILIZED. GENERIC PRODUCTS WILL NOT BE ACCEPTED. SHOP DRAWINGS AND CALCULATIONS MUST BE PREPARED UNDER THE DIRECT SUPERVISION AND CONTROL OF THE SPECIALTY ENGINEER. SHOP DRAWINGS AND CALCULATIONS REQUIRE THE EMBOSSED SEAL, DATE AND SIGNATURE OF THE SPECIALTY ENGINEER. COMPUTER PRINTOUTS ARE AN ACCEPTABLE SUBSTITUTE FOR MANUAL COMPUTATIONS PROVIDED THEY ARE ACCOMPANIED BY SUFFICIENT DESCRIPTIVE INFORMATION TO PERMIT THEIR PROPER EVALUATION. SUCH DESCRIPTIVE INFORMATION SHALL BEAR THE EMBOSSED SEAL AND SIGNATURE OF THE SPECIALTY ENGINEER AS AN INDICATION THAT HE HAS ACCEPTED RESPONSIBILITY FOR THE RESULTS. SEPIAS DO NOT REQUIRE SIGNATURE AND SEAL. THE

ARCHITECT WILL RETAIN ONE SIGNED AND SEALED BLUELINE PRINT FOR

- CATALOG INFORMATION ON STANDARD PRODUCTS DOES NOT REQUIRE THE SEAL OF A SPECIALTY ENGINEER. REVIEW BY THE ARCHITECT OF SUBMITTALS IS LIMITED TO VERIFYING THE
 - FOLLOWING: THAT THE SPECIFIED STRUCTURAL SUBMITTALS HAVE BEEN FURNISHED.
- THAT THE STRUCTURAL SUBMITTALS HAVE BEEN SIGNED AND SEALED BY THE SPECIALTY ENGINEER. THAT THE SPECIALTY ENGINEER HAS UNDERSTOOD THE DESIGN INTENT AND HAS USED THE SPECIFIED STRUCTURAL CRITERIA. (NO
- DETAILED CHECK OF CALCULATIONS WILL BE MADE.) THAT THE CONFIGURATION SET FORTH IN THE STRUCTURAL SUBMITTALS IS CONSISTENT WITH THE CONTRACT DOCUMENTS. (NO DETAILED CHECK OF DIMENSIONS OR QUANTITIES WILL BE MADE.)
- A LIST SHALL BE PREPARED AND MAINTAINED BY THE CONTRACTOR FOR ALL SHOP DRAWINGS REQUIRING PARTICIPATION OF A SPECIALTY ENGINEER. THE LIST SHALL CONTAIN PROJECT NAME, NAME OF CONTRACTOR, NAME OF SUBCONTRACTOR, NAME OF SPECIALTY ENGINEER, DRAWING NUMBER, DRAWING TITLE AND THE LATEST REVISION NUMBER AND DATE, FOR PARTIAL SUBMITTALS, THE LIST SHALL CONTAIN ALL ANTICIPATED DRAWING NUMBERS AND TITLES REQUIRED TO COMPLETE THE CONTRACT. THE CONTRACTOR IS RESPONSIBLE FOR SUBMITTING THE LATEST UPDATED LIST OF DRAWINGS WITH EACH SUBMITTAL SUBMITTALS NOT MEETING THE ABOVE CRITERIA WILL NOT BE REVIEWED

AND WILL BE RETURNED TO CONTRACTOR MARKED REVISE AND RESUBMIT

THE CONTRACTOR SHALL BE RESPONSIBLE FOR ANY DELAYS WHICH MAY



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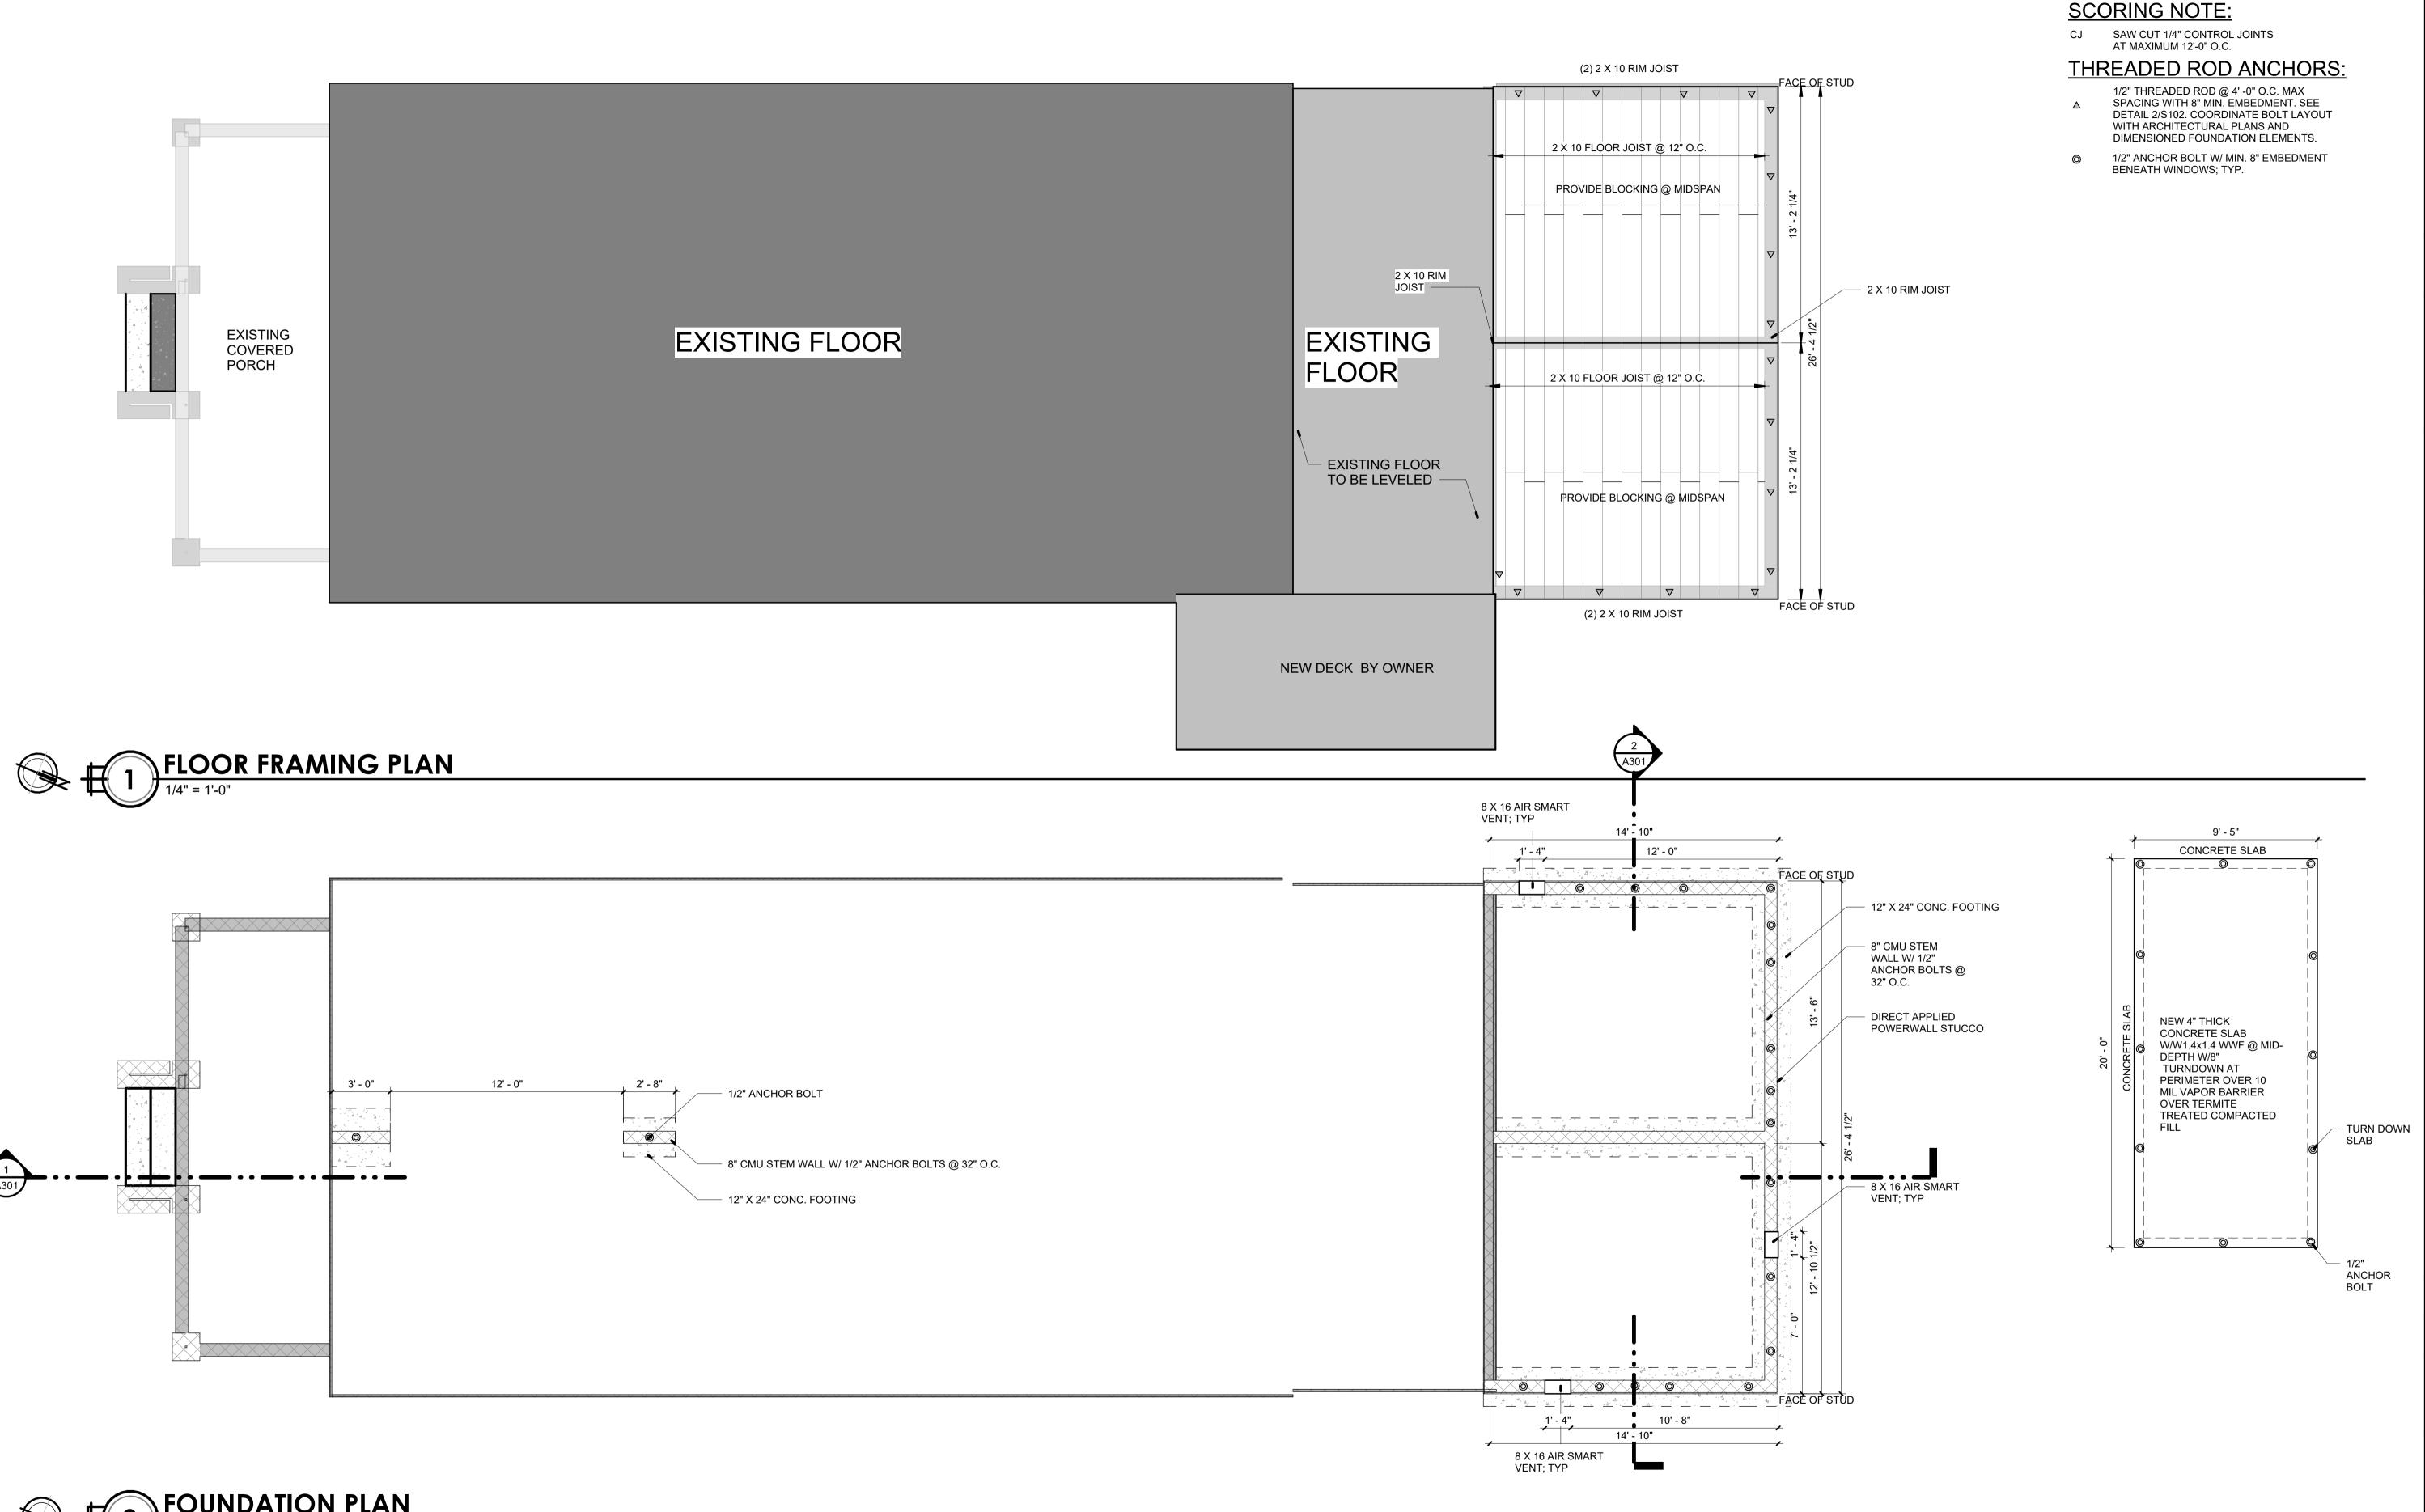
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JSS **ISSUE DATE:** 06-22-21

REVISIONS Date

SHEET TITLE: STRUCTURAL NOTES AND DIAGRAMS

SHEET NO:



TYPICAL SLAB NOTE:

1. 4" 3,000psi CONCRETE SLAB REINFORCED WITH W1.4xW1.4 / 6x6 WWF

REINFORCEMENT. INSTALL OVER VAPOR BARRIER AND COMPACTED FILL WITH APPROVED TERMITE TREATMENT.

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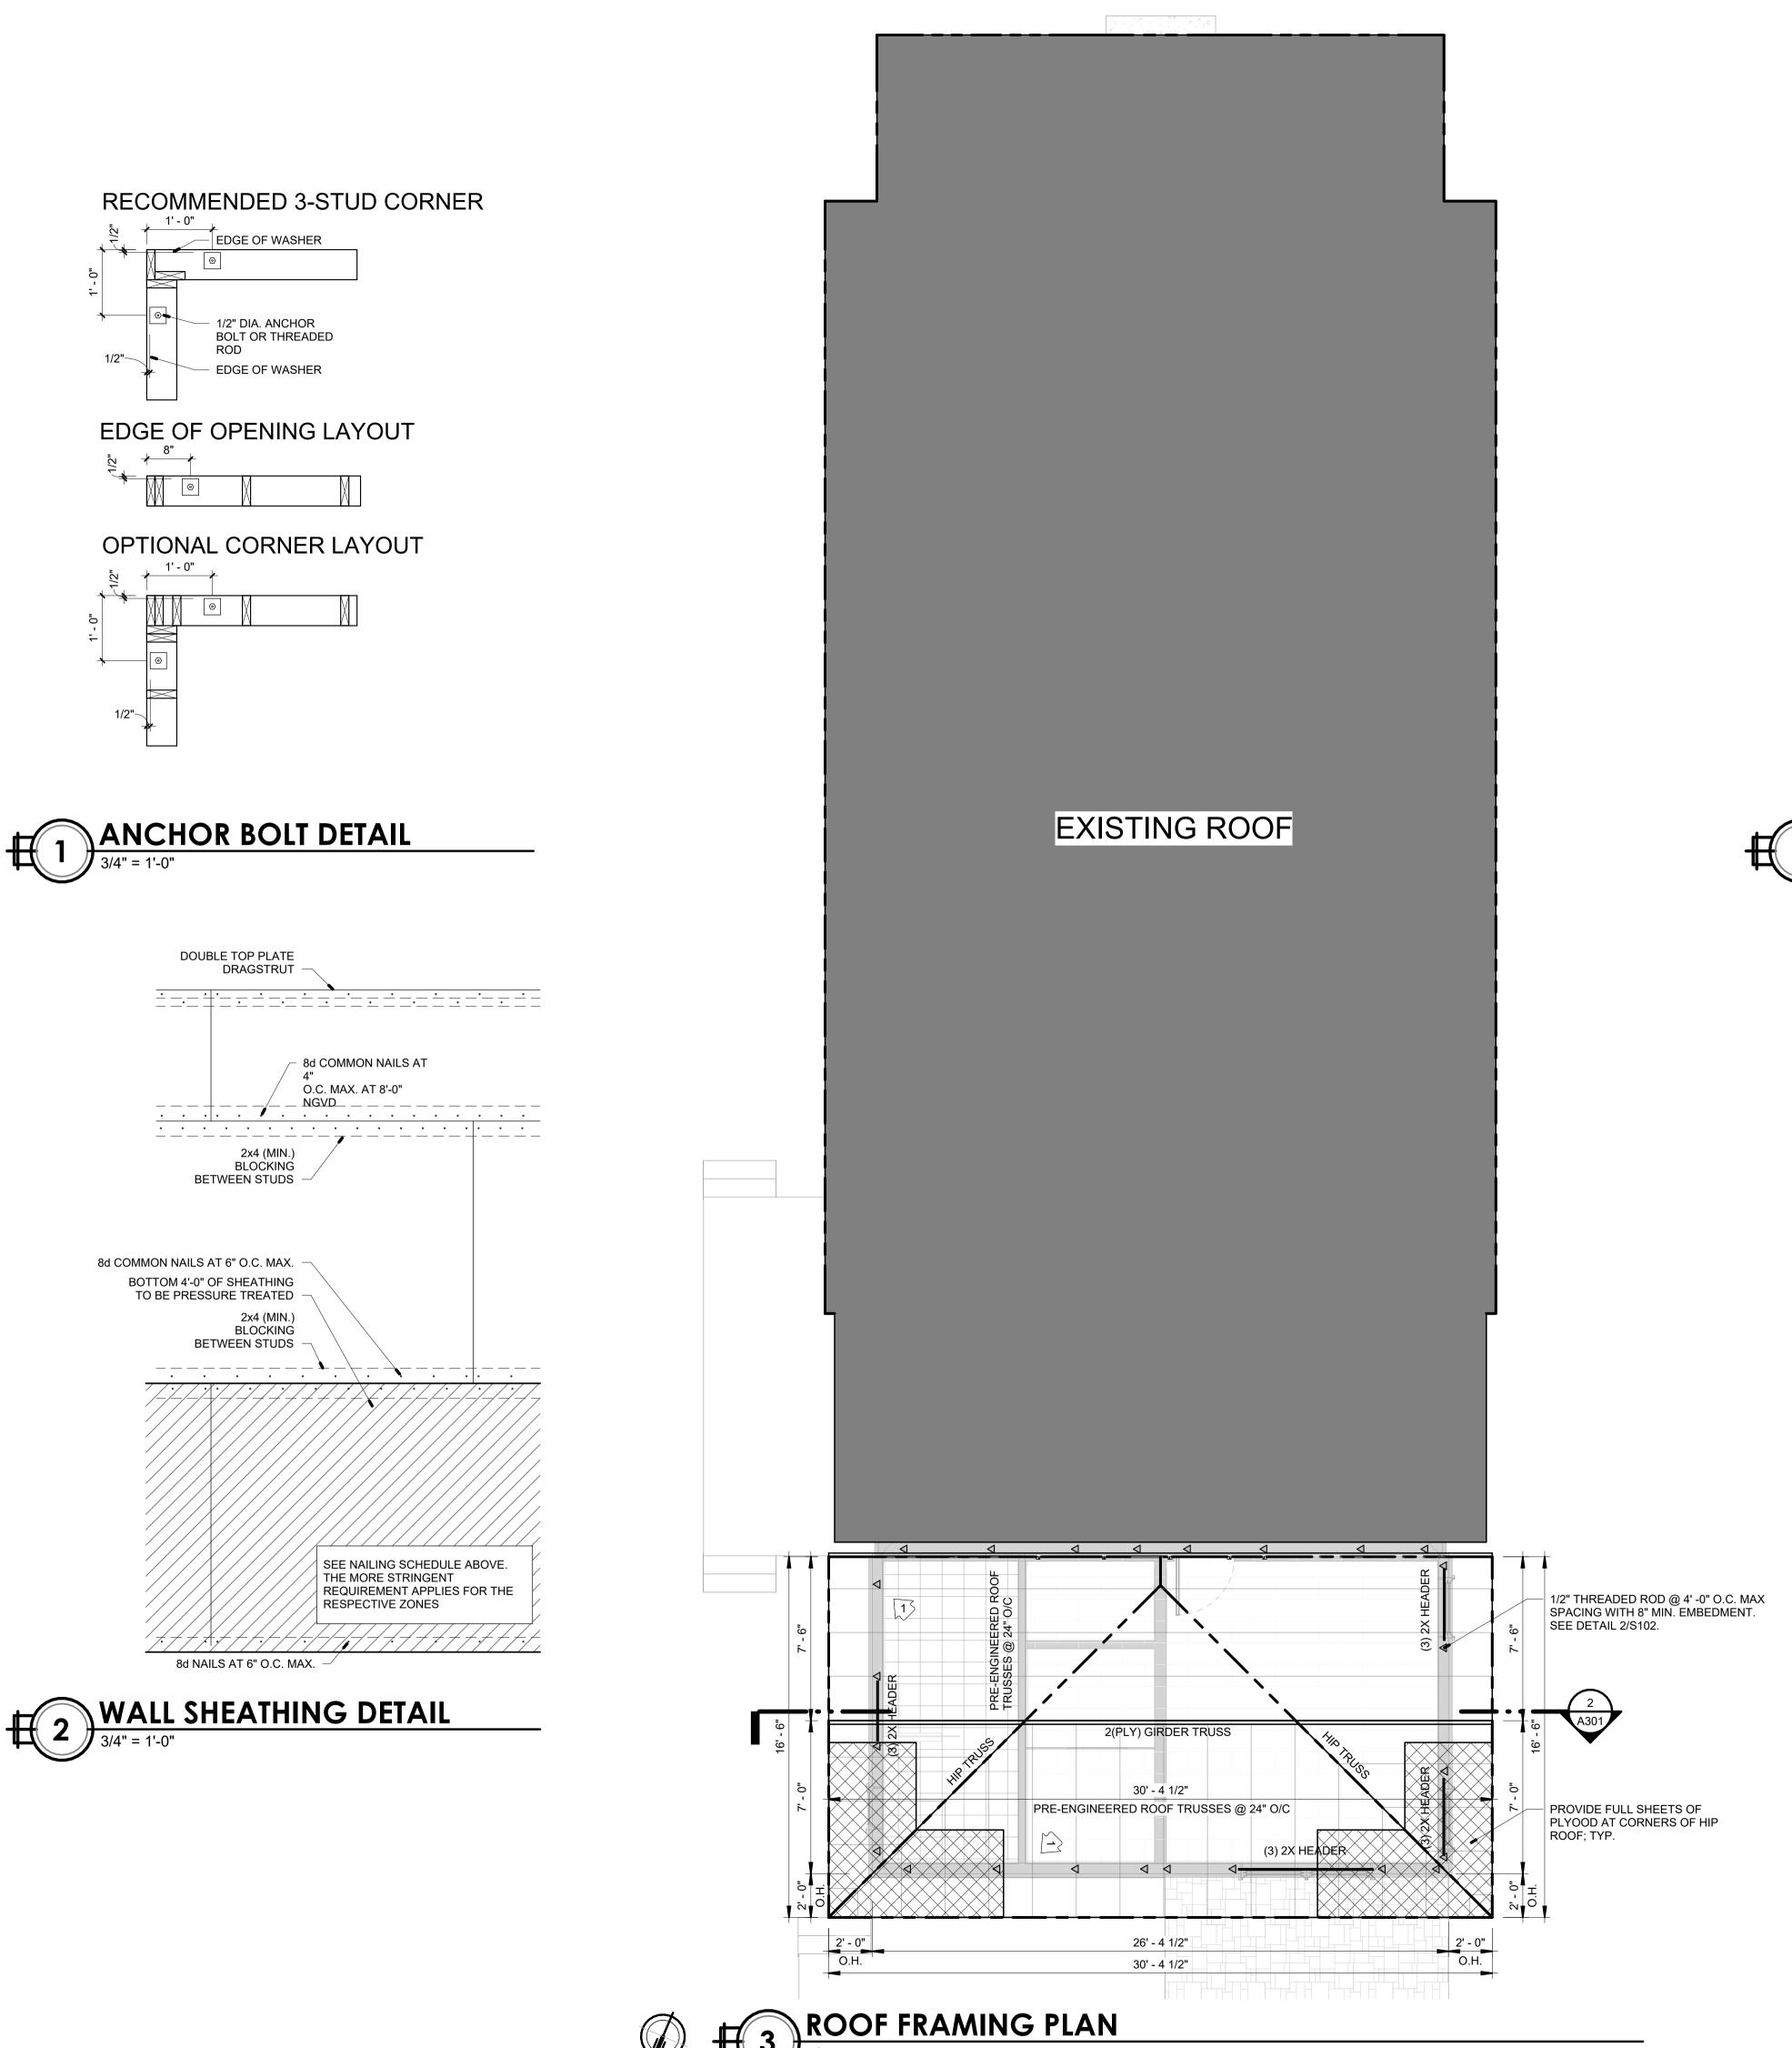
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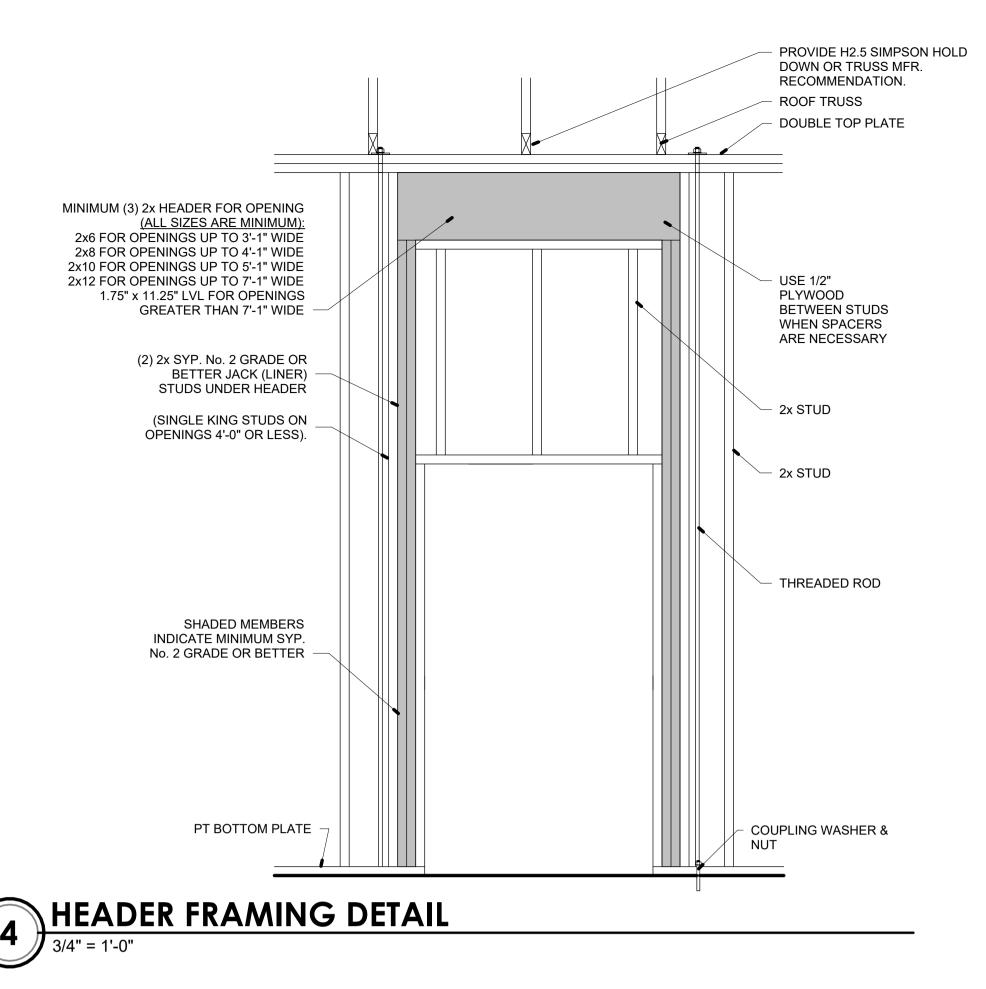
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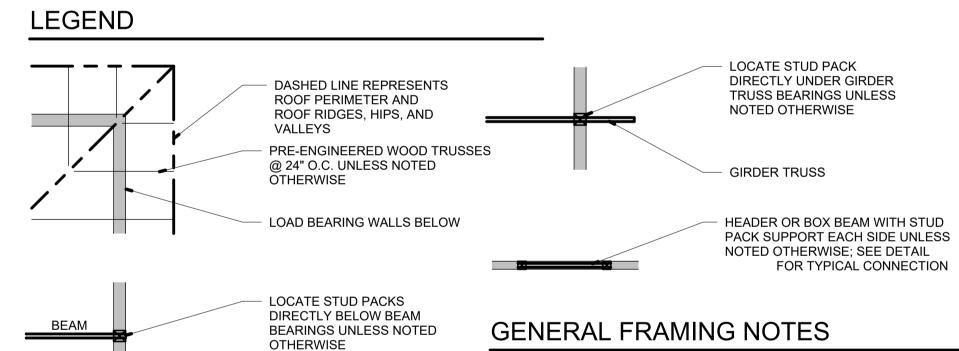
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*FOUNDATION & FLOOR **FRAMING PLAN**







FINAL TRUSS LAYOUT TO BE DETERMINED BY FLORIDA REGISTERED

CONTRACTOR TO SUBMIT TRUSS PACK DESIGN TO ARCHITECT FOR

IF ALL EDGES ARE SECURED WITH BLOCKING.

OSB IS NOT AN ACCEPTABLE SUBSTITUTE FOR PLYWOOD.

STRAP EXISTING STICK

TWIST STRAP FRAME ROOF MEMBERS TO

NEW LVL

PROVIDE MIN. 5/8" THICK CDX PLYWOOD SHEATHING. 1/2" MAY BE USED

TRUSS ENGINEER.

APPROVAL.

SIMPSON HOLD DOWN SCHEDULE					EDULE
Mark	MFR.	MFR. No.	FL Product Approval No.	Use	Location
	Simpson	H2.5A	FL 10456	Generic Hurricane Anchor	EACH STUD/TRUSS CONNECTION

FL 10456/ 13872

MTS16

Simpson



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JLR JSS

ISSUE DATE:
06-22-21

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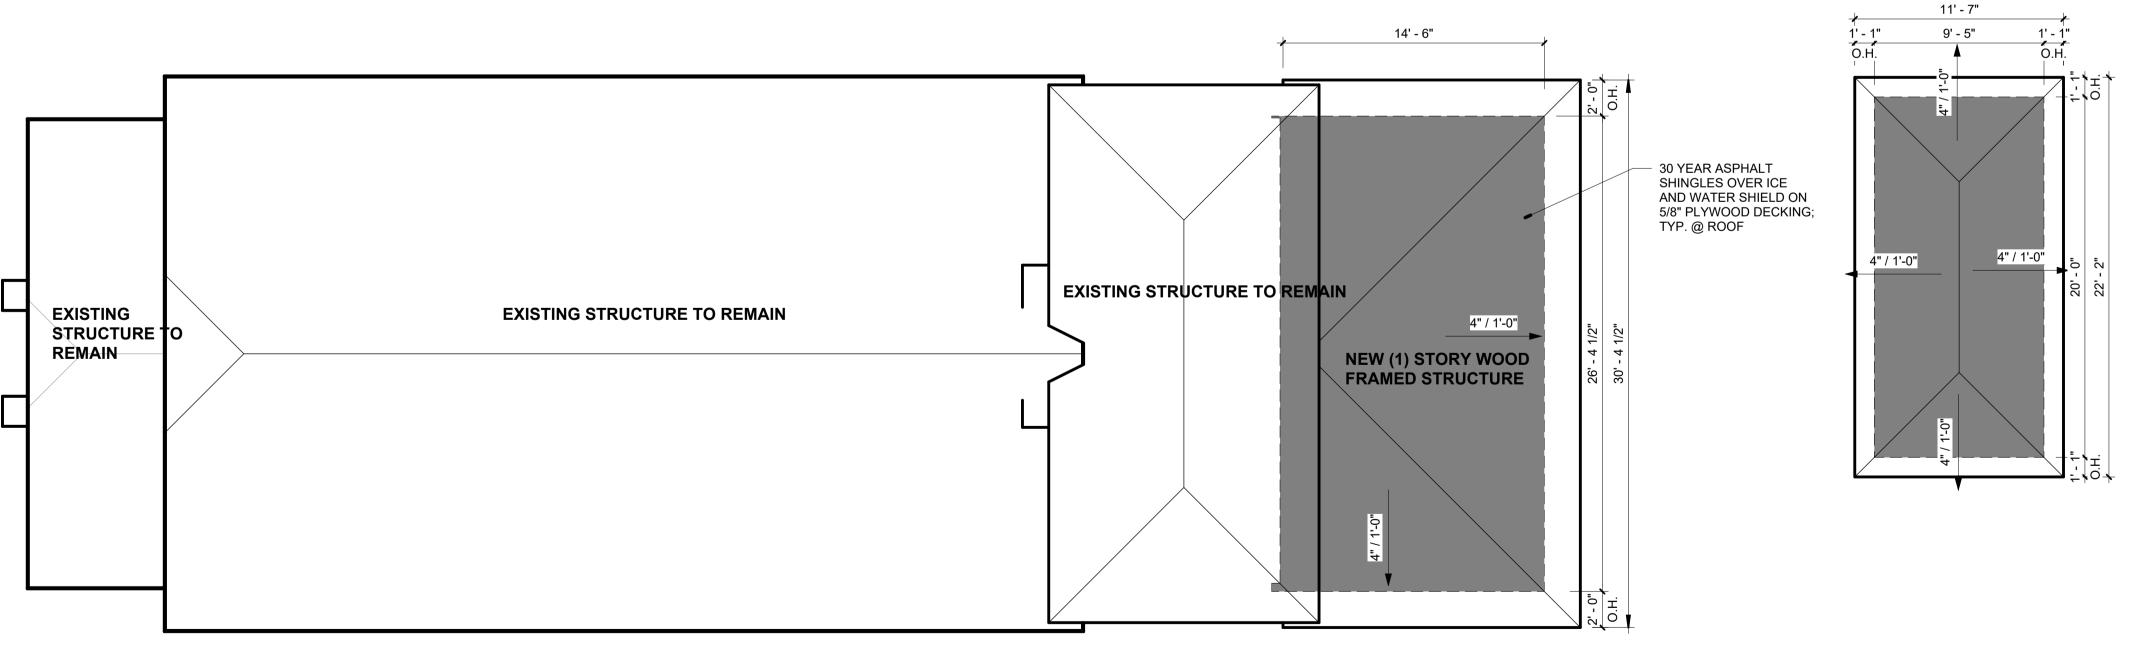
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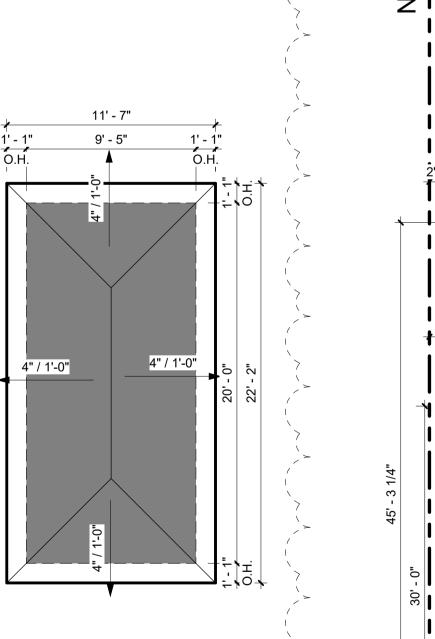
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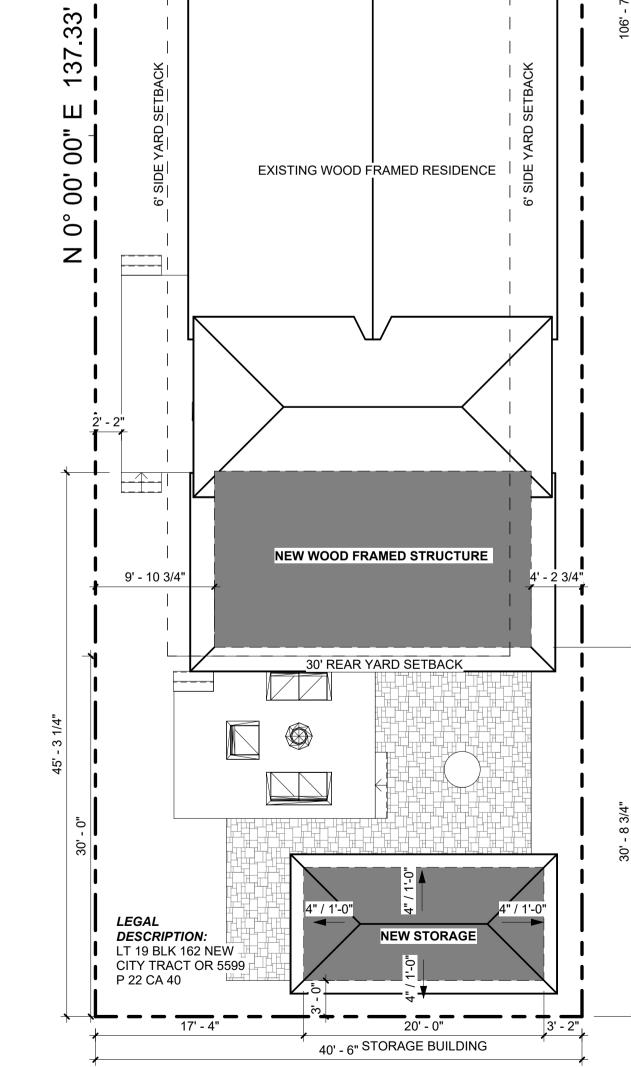
FRAMING PLAN & DETAILS

EET NO:

\$102PROJECT NO: 20044







N90° 00' 00"E 40.50'

30' FRONT YARD SETBACK

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ISSUE DATE: 06-22-21

REVISIONS Revision 1 08/20/20

SHEET TITLE:

SITE AND **ROOF PLAN**

REMOVE WINDOW AND PREPARE

OPENINGS FOR NEW WINDOW


INSTALLATION; SEE WINDOW

SCHEDULE



REMOVE WINDOW AND INFILL

AS REQ'D.

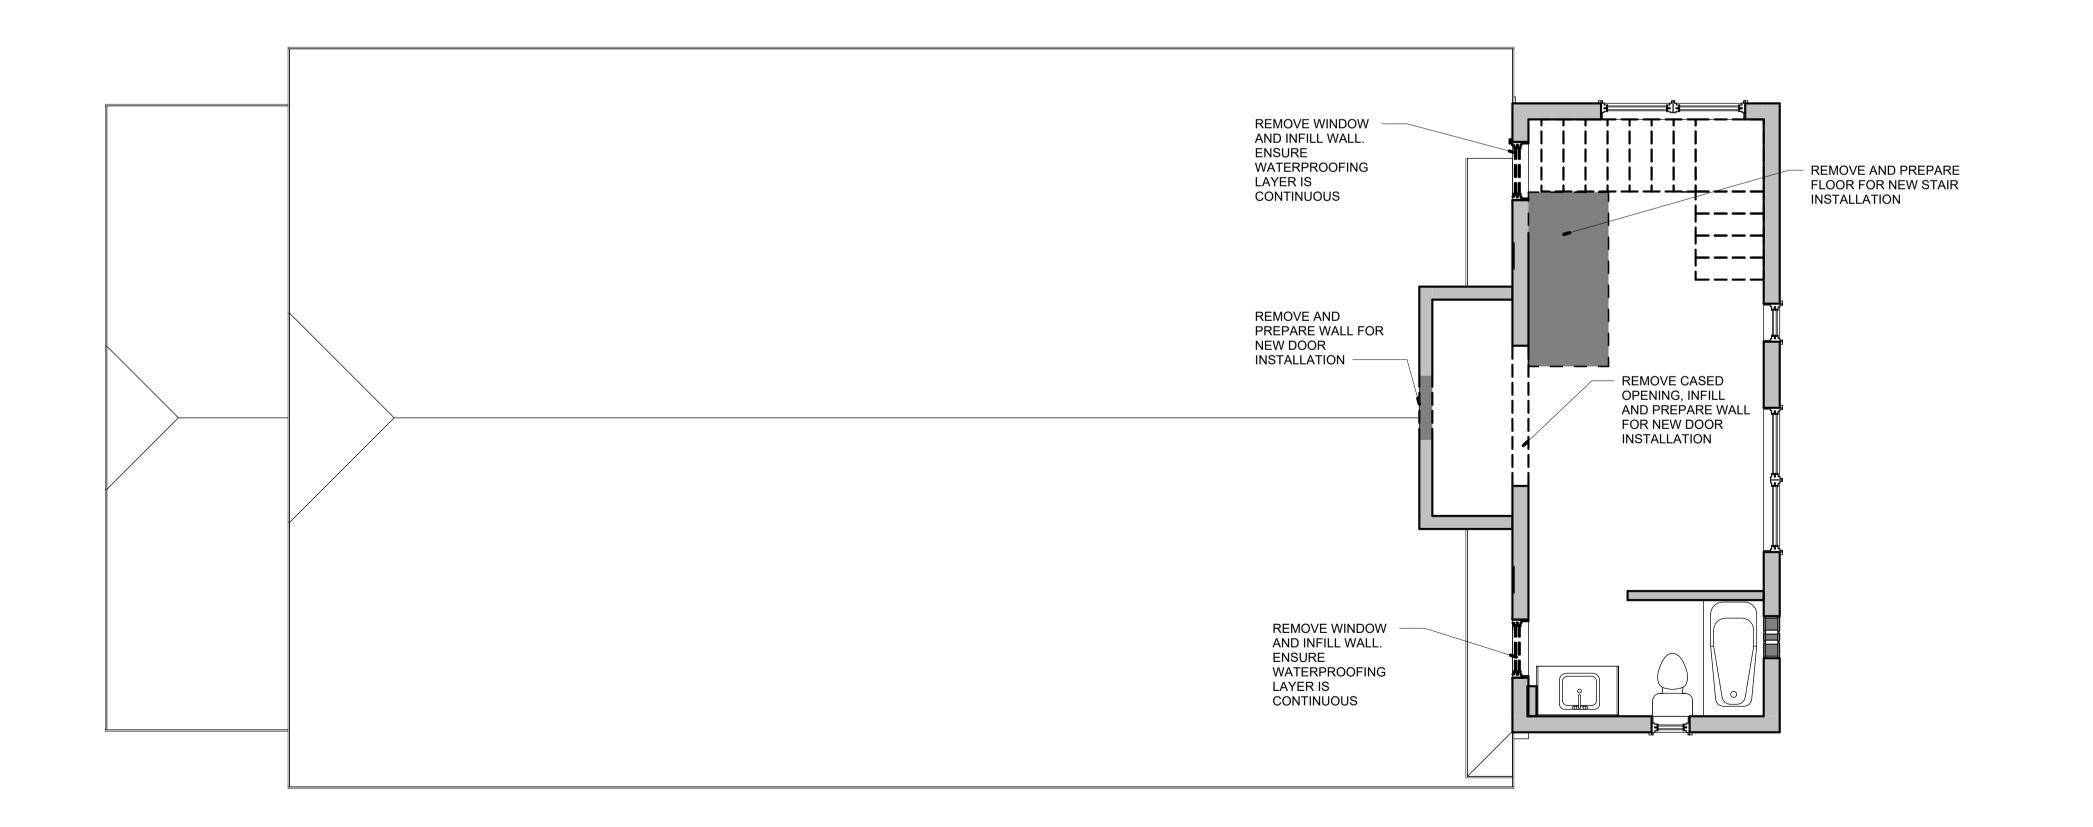

REMOVE WINDOW AND INFILL AS

REQ'D FOR NEW WINDOW

SCHEDULE

INSTALLATION; SEE WINDOW



- GENERAL CONTRACTOR TO VERIFY EXISTING UTILITY LOCATIONS BEFORE COMMENCING WORK.
- DISCONNECT EXISTING UTILITIES AS REQUIRED FOR NEW WORK. RECYCLE AS MUCH DEBRIS AND WASTE MATERIALS AS POSSIBLE. DISPOSE
- REMOVE ALL EXISTING SIDING AND REPLACE WITH NEW COMPOSITE SIDING.

WOODEN DECK



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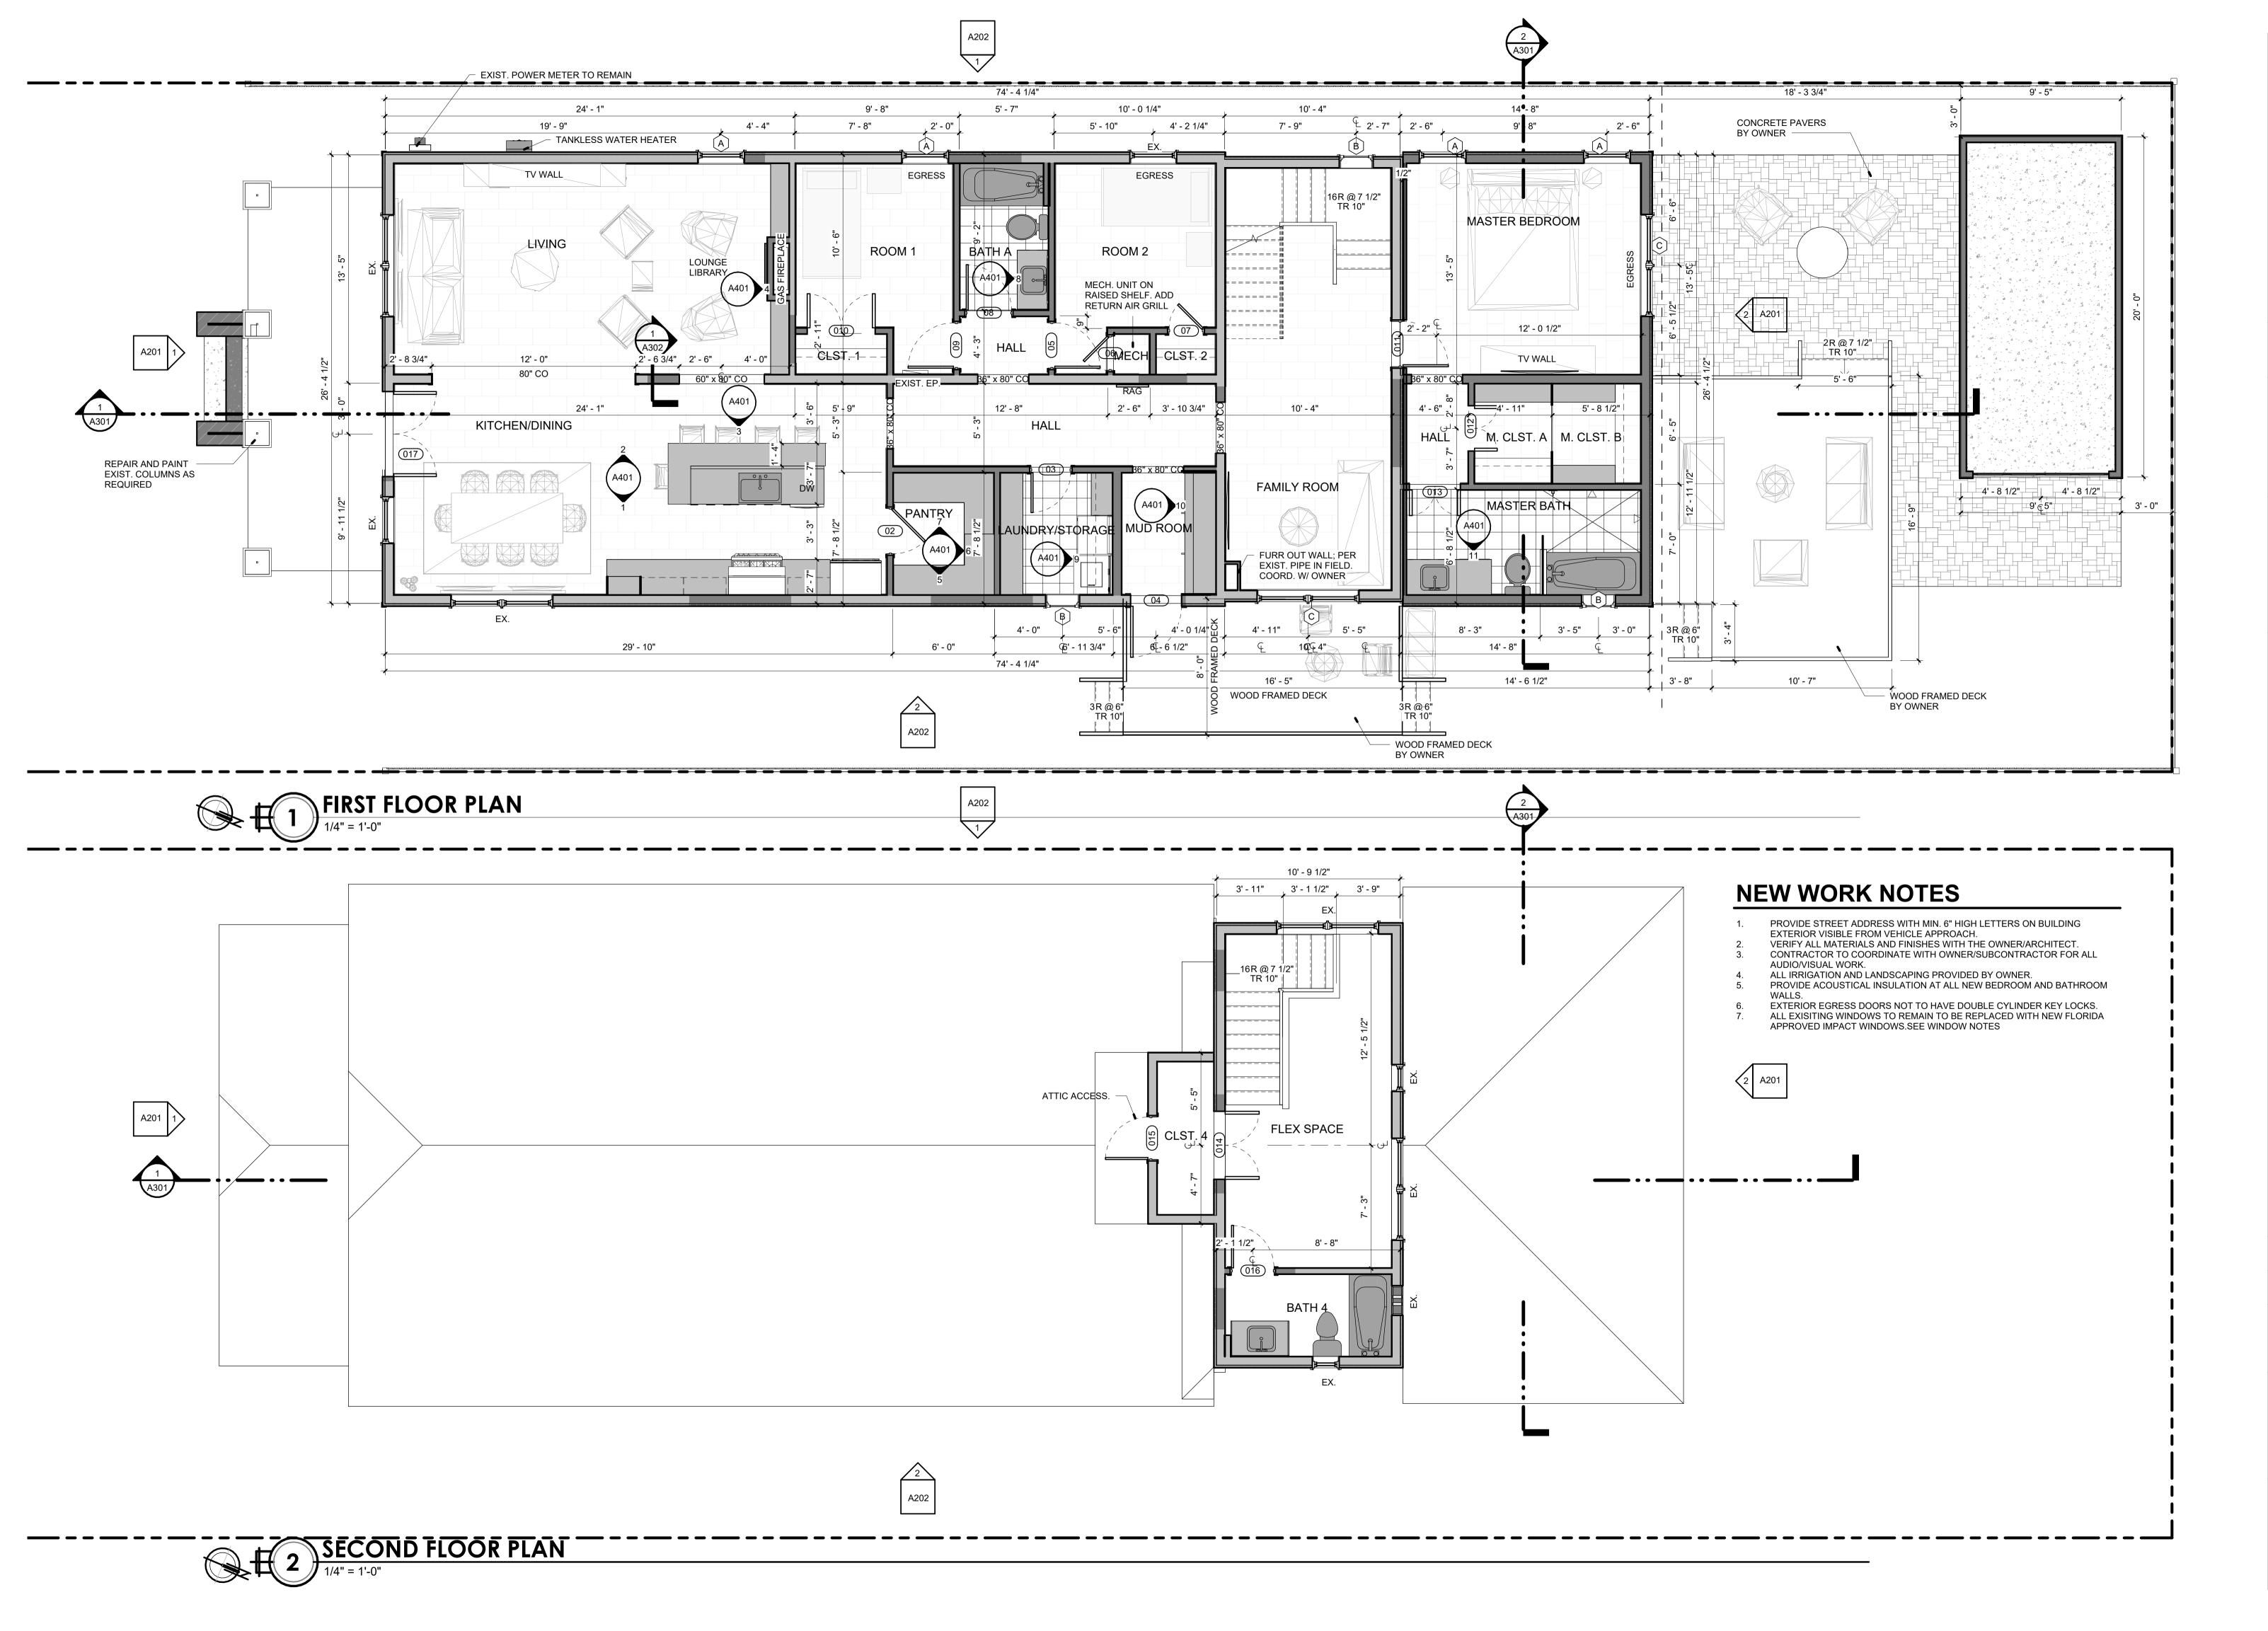
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SHEFTIRST AND **SECOND** FLOOR DEMO **PLANS**



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SHEW WORK FIRST AND **SECOND FLOOR PLANS**

FIRST FLOOR REFLECTED CEILING PLAN



SECOND FLOOR REFLECTED CEILING PLAN

1/4" = 1'-0"

ELECTRICAL LEGEND

3-WAY SWITCH

IN-SINK GARBAGE DISPOSAL


CABLE TV

DOORBELL ANNUNCIATOR

RECESSED LIGHT FIXTURE

WALL MOUNTED (SCONCE) LIGHT FIXTURE

UNDER CABINET DOWNLIGHT STRIP

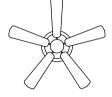

COMBINED SMOKE & CARBON MONOXIDE DETECTOR LISTED OR LABELED BY A NATIONAL RECOGNIZED TESTING LABORATORY. HARDWIRED TO BUILDING ELECTRICAL SYSTEM. INSTALL WITHIN 10'-0" OF ALL SLEEPING AREAS AND ENSURE EACH DEVICE HAS BATTERY

CONFIRM ALL FIXTURES AND LOCATIONS WITH OWNER PRIOR TO

FINAL CONDUIT CONNECTIONS TO HEAT PUMPS, AIR HANDLERS, EXHAUST FANS, AND WATER HEATERS SHALL BE FLEXIBLE METAL (LIQUID TIGHT IN FLAMMABLE, OUTSIDE AND OTHER DAMP AND WET LOCATIONS).

CONDUIT MATERIAL SHALL BE AS FOLLOWS:

B) CONCEALED RISER FROM 36" BELOW GRADE - RIGID NON- METALLIC.

C) ÀBOVE GRADE SUBJECT TO PHYSICAL ABUSE - RIGID GALVANIZED STEEL OR INTERMEDIATE.

F) ALL INTERCOM, FIRE ALARM, CLOCK AND CCTV CONDUITS INSTALLED BELOW GRADE THAT ARE NOT UNDER THE BUILDING SLAB

CODES & EQUIPMENT

ALL WORK SHALL COMPLY WITH LOCAL AND STATE ELEC. CODES, IN ADDITION TO THE NATIONAL ELECTRIC CODE.

ENSURE THE OWNER HAS A COMPLETE AND OPERABLE SERVICE.

ALL ELECTRICAL EQUIPMENT AND DEVICES SHALL BE PROVIDED WITH

THE CONTRACTOR SHALL VERIFY ALL APPLIANCE LOADS PRIOR TO RUNNING THE CIRCUIT. THE MINIMUM CIRCUIT REQUIREMENTS SHALL BE BASED ON THE APPLIANCE NAMEPLATE VALUE OR CODE REQUIREMENTS, WHICHEVER

COORDINATE LOCATIONS OF ELECTRICAL EQUIPMENT, DEVICES, OUTLETS,

VERIFY ALL DOOR SWINGS WITH ARCHITECTURAL DRAWINGS PRIOR TO

WORKING SPACE OF 3 FEET SHALL BE MAINTAINED IN FRONT OF ALL

RECEPTACLES & SWITCHES

ROUTE LIGHT FIXTURE SWITCH LEGS TIED TO DIGITAL KEY PADS AS HOME RUNS TO CLOSET SHOWN AT SOUTH WEST CORNER OF GROUND FLOOR.

DECORATOR LIGHT SWITCH - WHITE ALL DIMENSIONS FOR MOUNTING HEIGHTS OF NEW RECEPTACLES AND

SWITCHES ARE TO THE CENTER OF THE BOX.

TO ROUGH-IN. RECEPTACLES, SWITCHES AND COVER PLATES SHALL BE DECORATOR STYLE.

COLOR SHALL BE WHITE.

RECEPTACLE SPACING MUST BE PER NEC.

ALL BATHROOMS, KITCHEN AND OUTDOOR LOCATIONS TO BE GFCI AS

REQUIRED PER NEC. SWITCHED OUTLETS SHALL HAVE ONLY TOP PORTION OF OUTLET SWITCHED.

SHEFIRST AND **SECOND FLOOR** RCP/LIGHTING

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PROJECT NO: 20044

DUPLEX

GROUND FAULT CIRCUIT INTERRUPTER


SWITCH

4-WAY SWITCH

EXHAUST FAN

PENDANT LIGHT FIXTURE



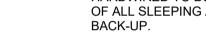

ELECTRICAL NOTES

INSTALLATION.

CONDUITS AND CONNECTIONS

- CONDUITS LEAVING OR ENTERING BUILDING SHALL BE SEALED PER N.E.C.
- TO PREVENT ENTRANCE OF MOISTURE. CONDUIT ROUTINGS AND DEVICE/EQUIPMENT LOCATIONS SHOWN ARE DIAGRAMMATIC ONLY, CONTRACTOR SHALL FIELD ROUTE AND LOCATE AS REQUIRED.
- A) BELOW GRADE RIGID NON-METALLIC. (POWER ONLY).
 - (POWER ONLY)
 - D) ABOVE GRADE NOT SUBJECT TO PHYSICAL ABUSE OR WEATHER -ELECTRICAL METALLIC TUBING. E) INDOORS NOT SUBJECT TO PHYSICAL ABUSE - ROMEX
- -INTERMEDIATE OR RIGID METAL. PVC NOT ALLOWED.


- ELECTRICAL CONTRACTOR SHALL COORDINATE W/ GULF POWER. TO
- SUITABLE PHENOLIC NAMEPLATES.
- IS MORE STRINGENT. FIXTURES, ETC., WITH ARCHITECTURAL PLANS, ELEVATIONS AND REFLECTED
- CEILING PLANS PRIOR TO ROUGH-IN WORK.
- ROUGHING IN FOR SWITCHES. ELECTRICAL PANELS AND DEVICES.


ALL LOW VOLTAGE WIRING AND BOXES BY INTEGRATED SURROUNDINGS.

WHERE TWO SWITCHES ARE SHOWN, PROVIDE SINGLE POLE COMBINATION

VERIFY FLOOR RECEPTACLE LOCATIONS (IF APPLICABLE) WITH OWNER PRIOR

WALL RECEPTACLES SHALL NOT BE INSTALLED BACK TO BACK.

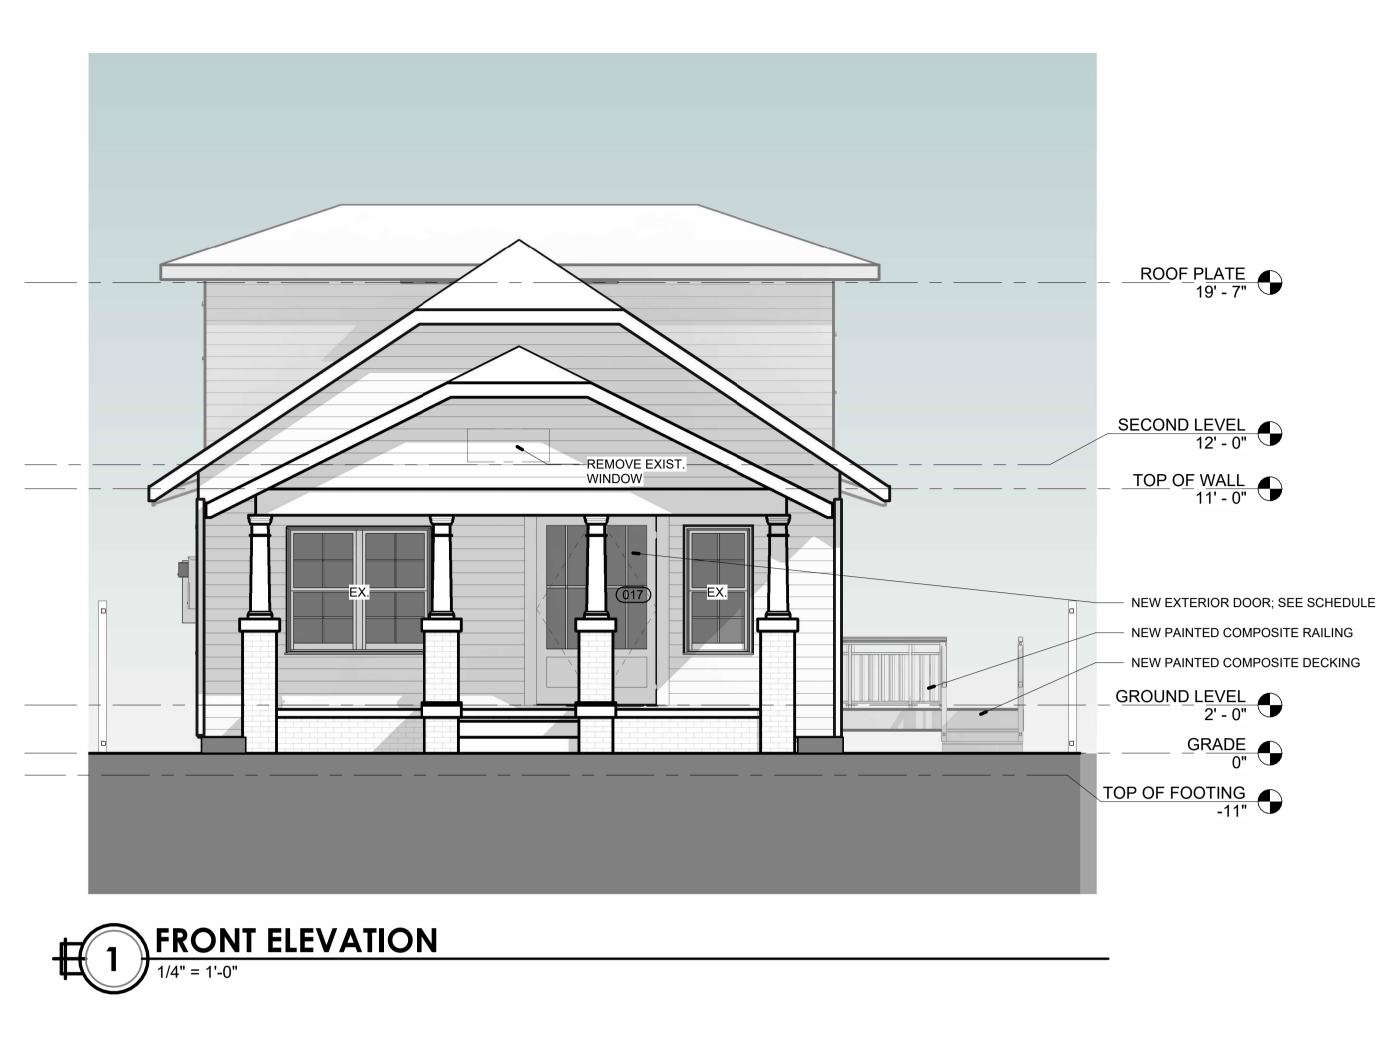

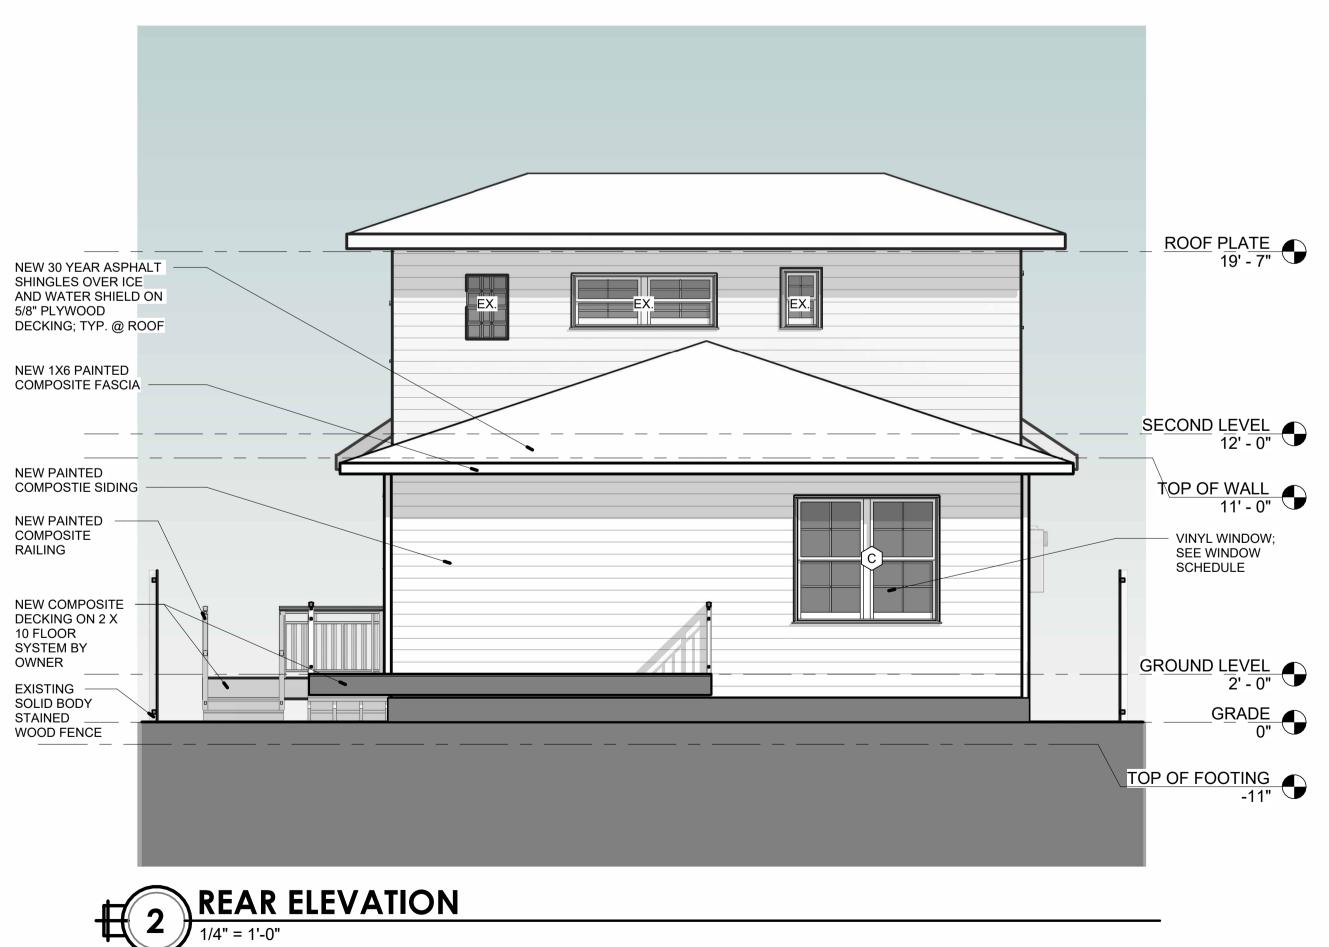



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No. Des. Date

SHEET TITLE:

EXTERIOR ELEVATIONS

SHEET NO:

A201PROJECT NO: 20044









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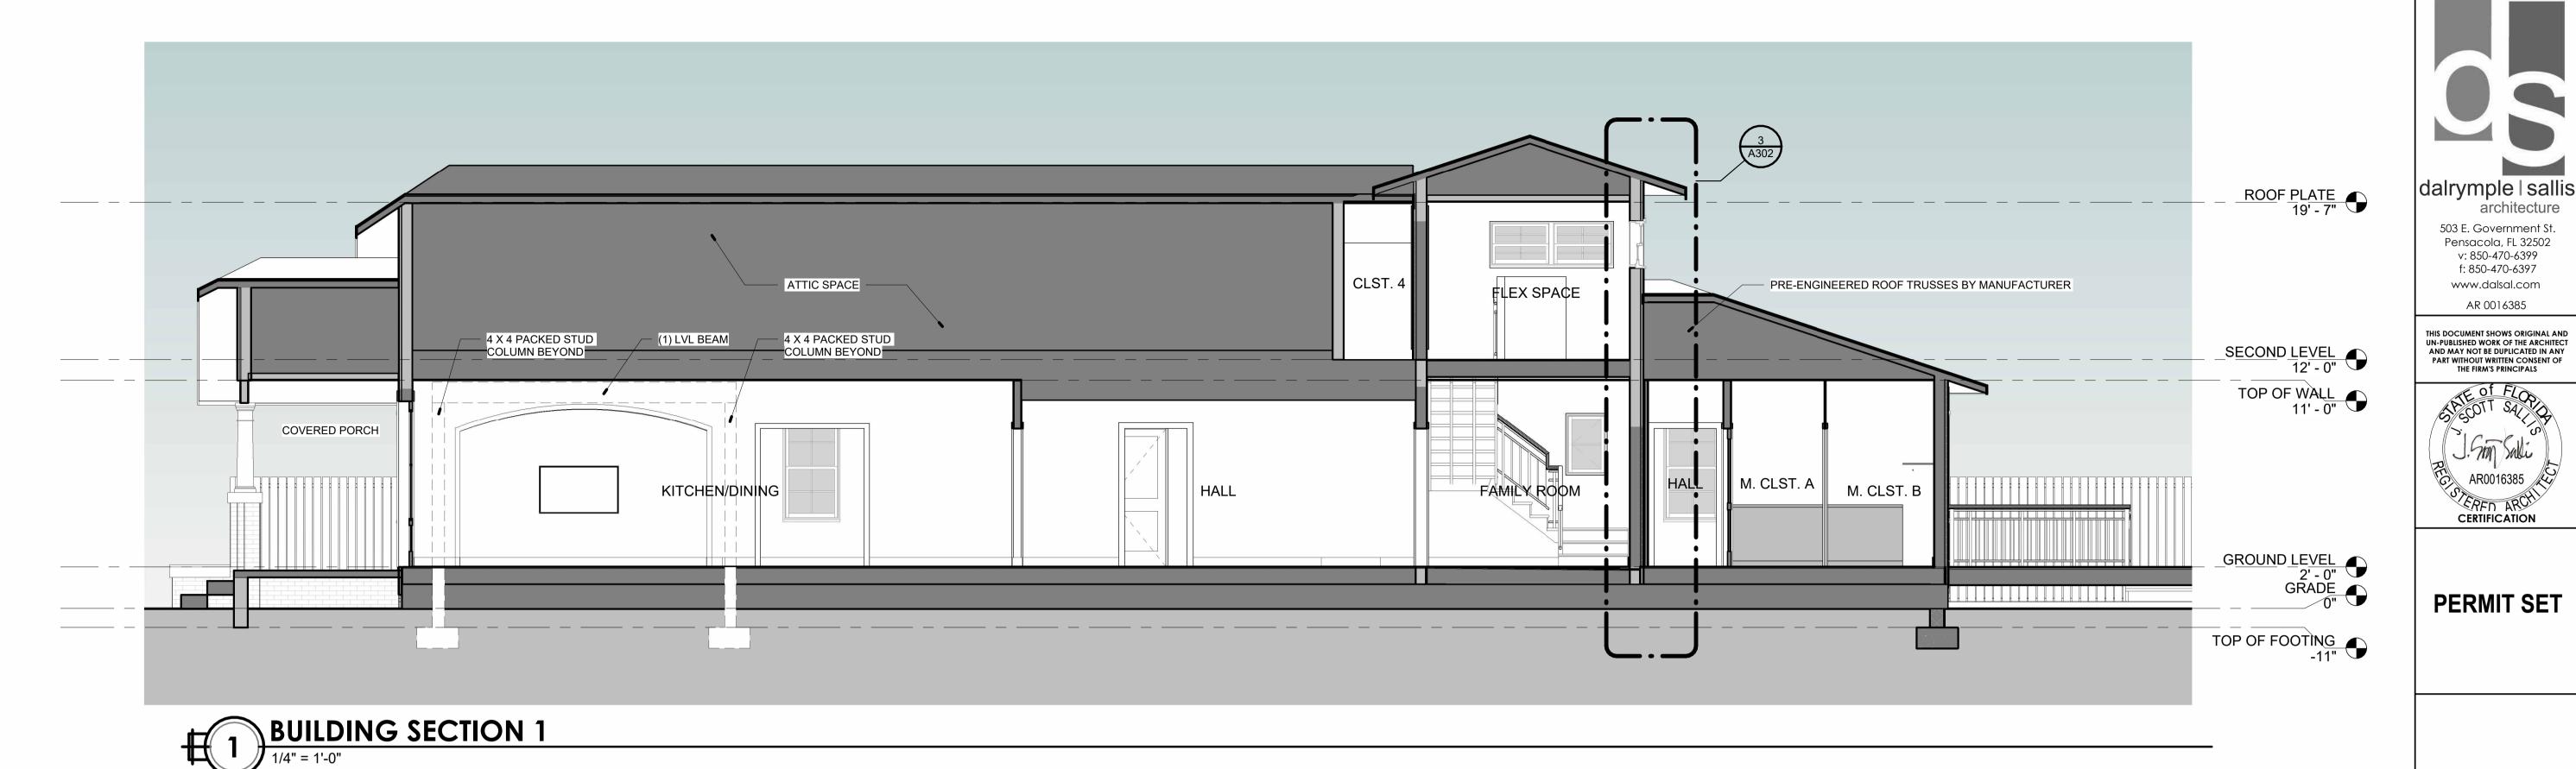
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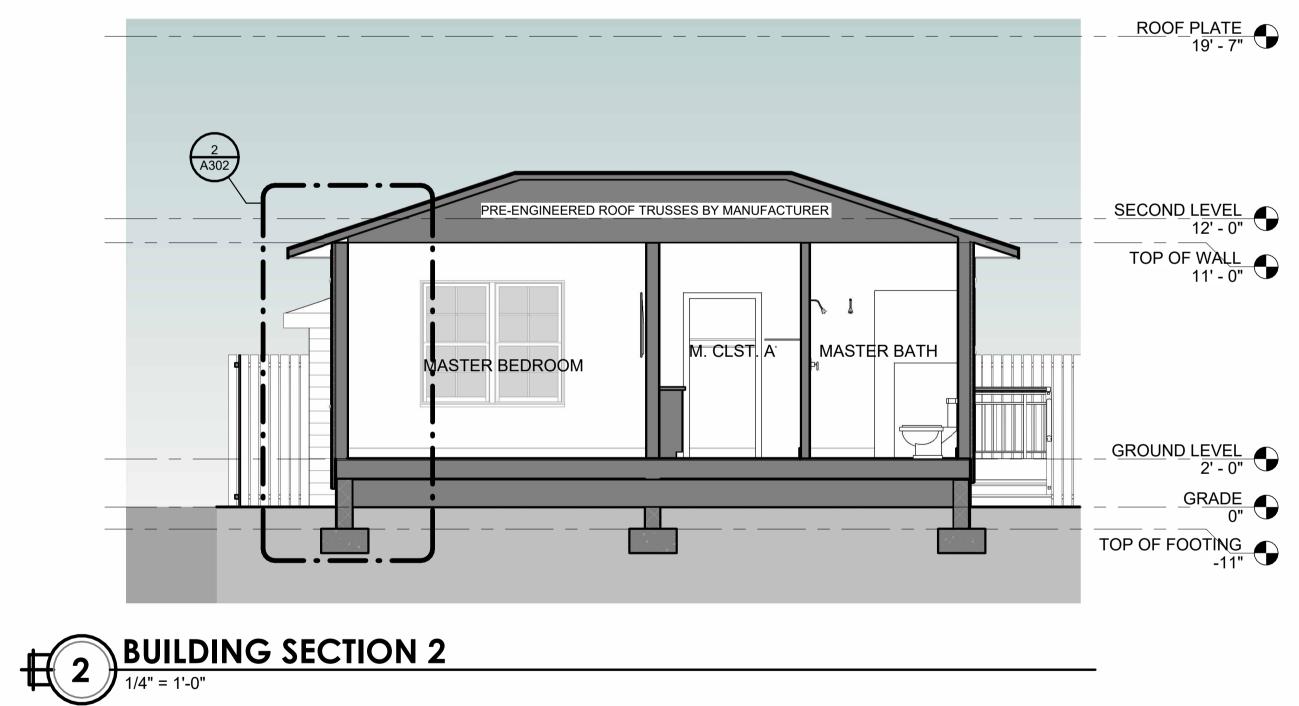
SHEET TITLE:

EXTERIOR ELEVATIONS

SHEET NO:

A20PROJECT NO: 20044





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SHEET TITLE: **BUILDING SECTIONS**

A301 PROJECT NO: 20044

RENOVATION COMERFORD

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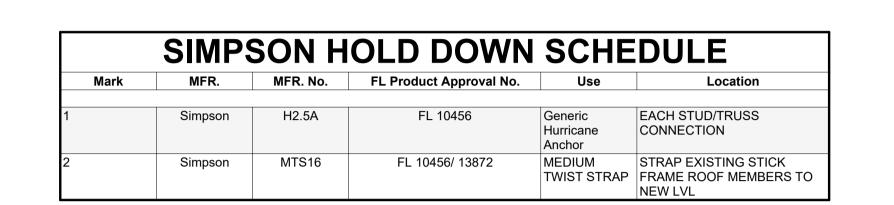
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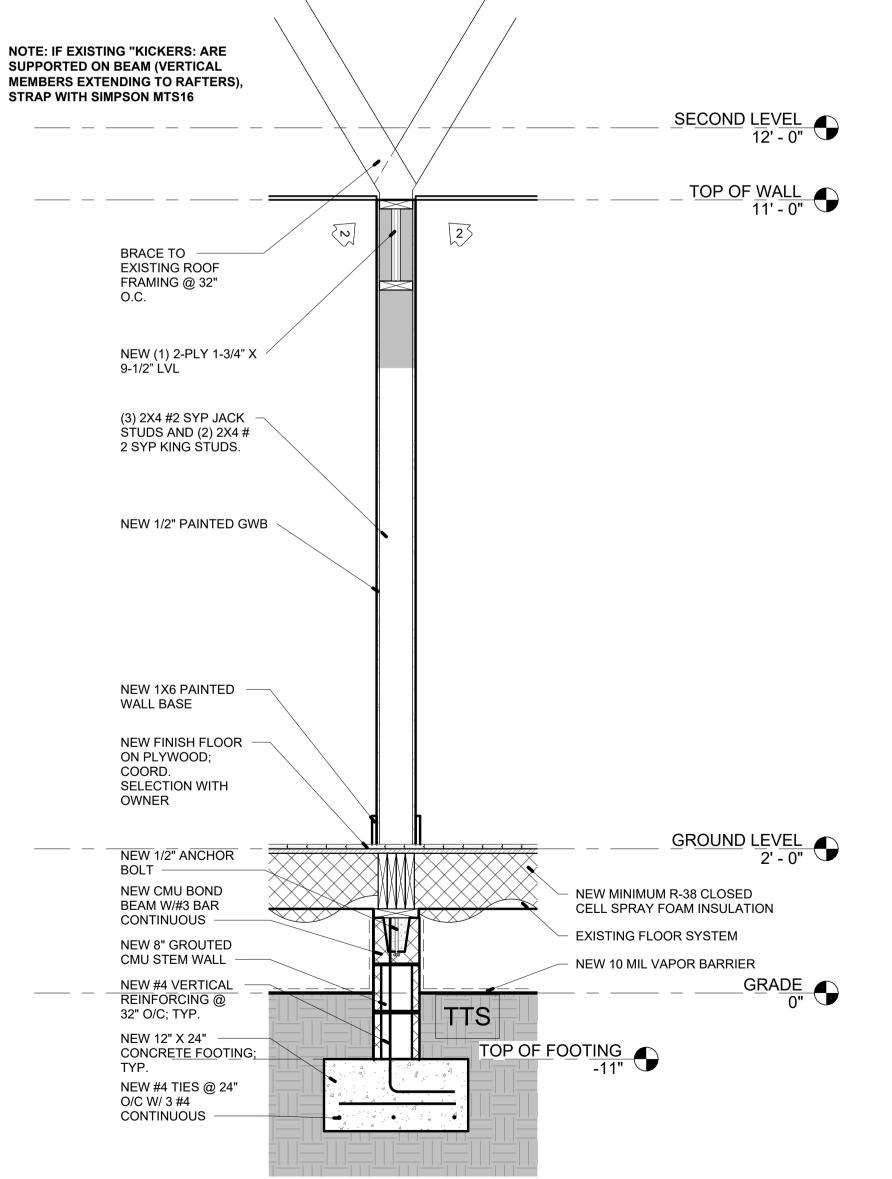
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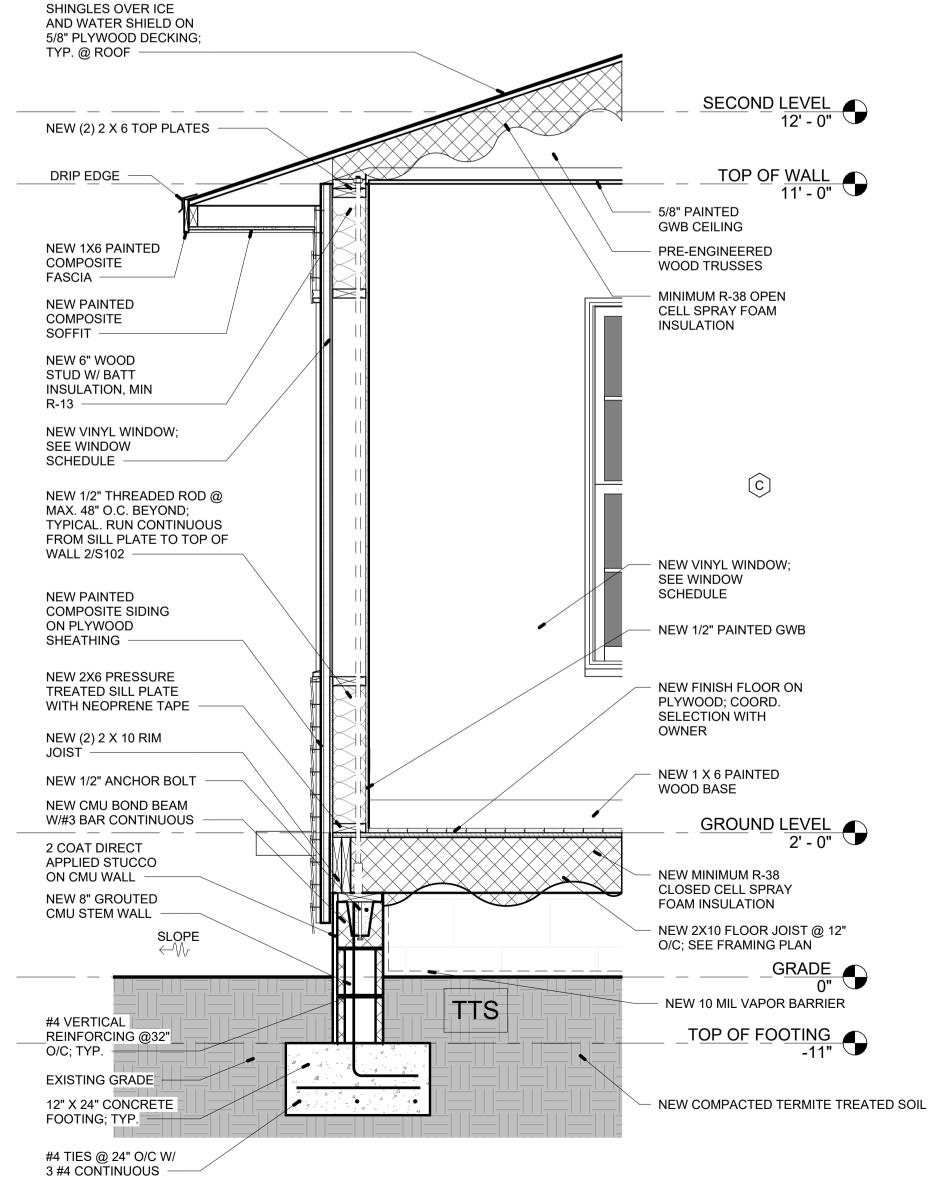
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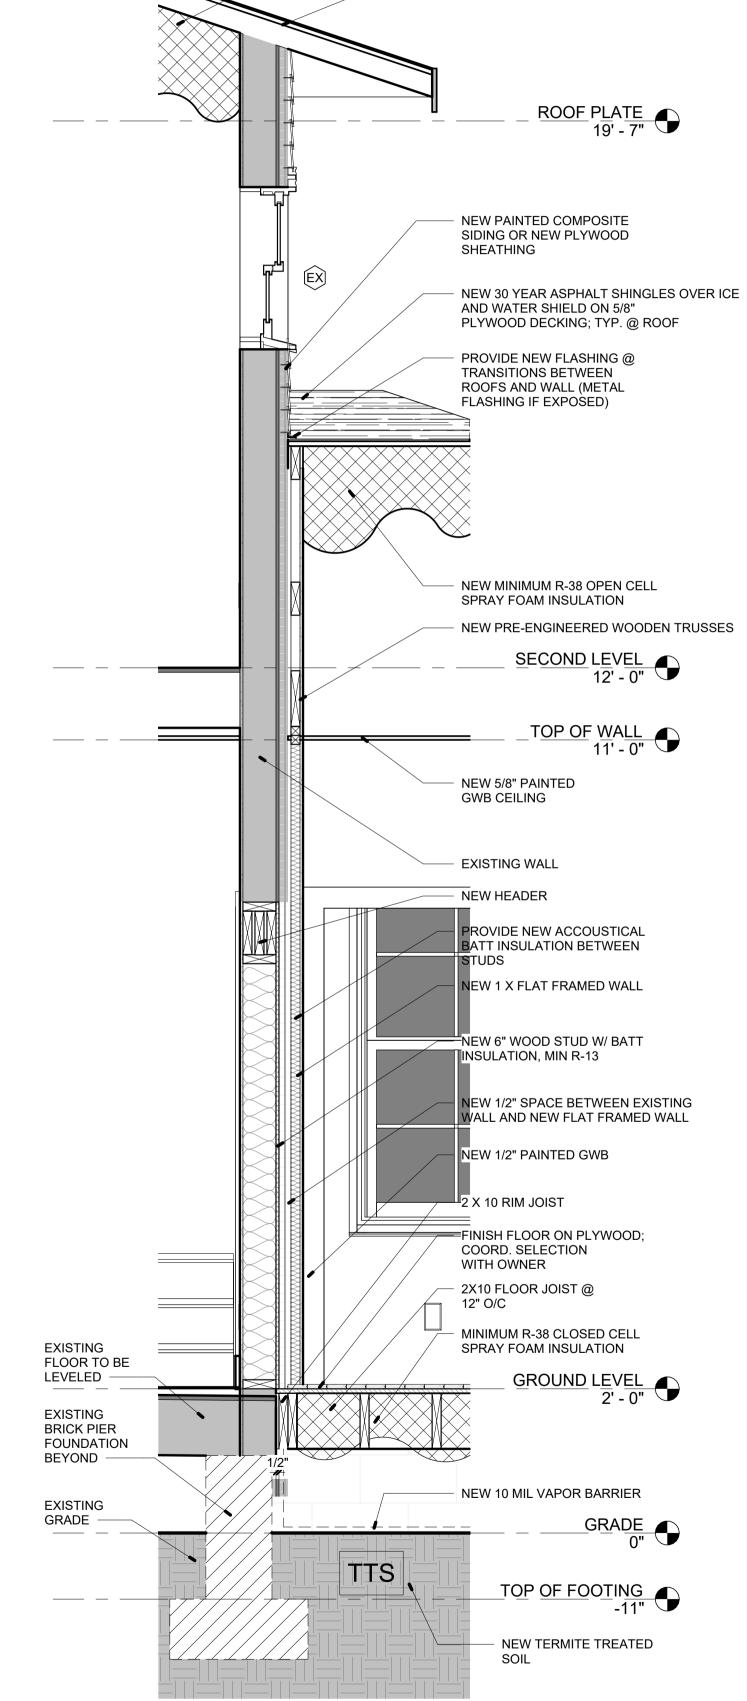
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WALL SECTION 33/4" = 1'-0"

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NEW MINIMUM R-38 OPEN CELL

SPRAY FOAM INSULATION

EXISTING ROOF

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SHEET TITLE:

WALL SECTIONS

SHEET NO:

A302PROJECT NO: 20044


WALL SECTION 1


3/4" = 1'-0"


WALL SECTION 2


3/4" = 1'-0"

NEW 30 YEAR ASPHALT

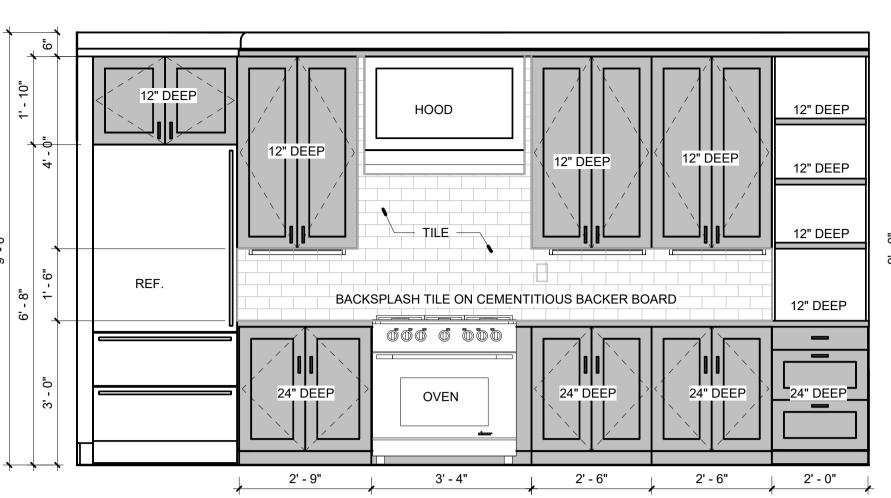

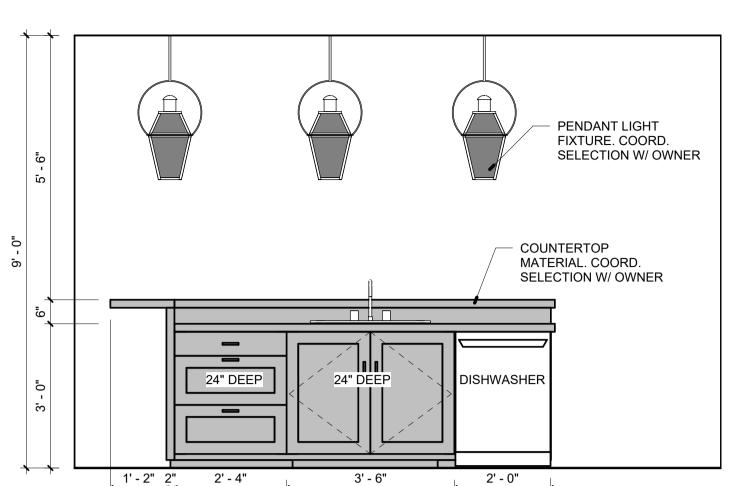

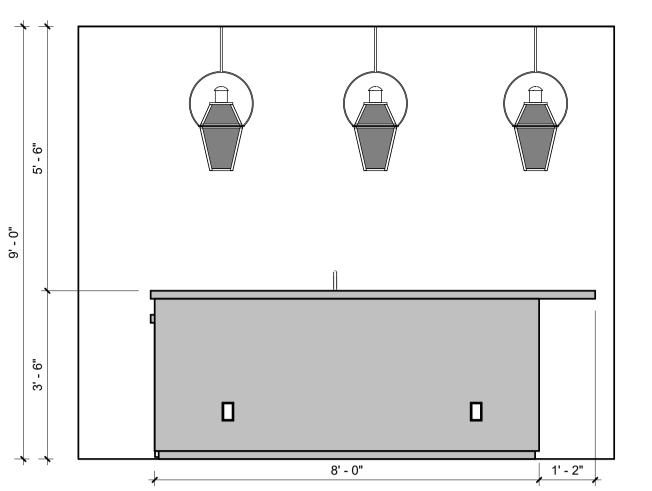

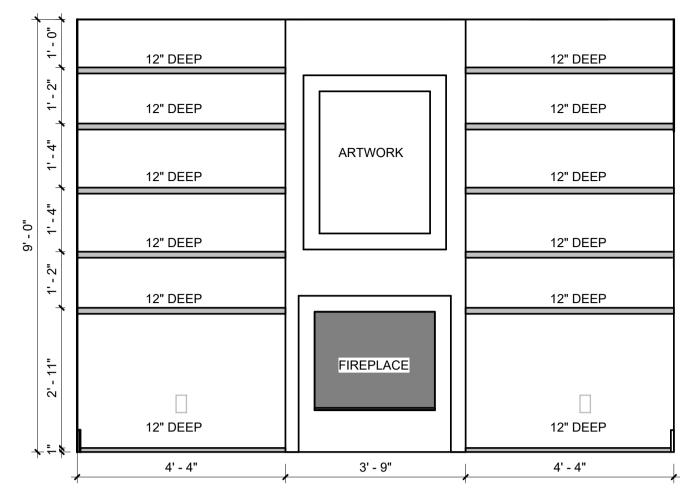


KITCHEN ISLAND ELEV. A.

1/2" = 1'-0"

KITCHEN ISLAND ELEV. B.


1/2" = 1'-0"


FIREPLACE ELEVATION
1/2" = 1'-0"

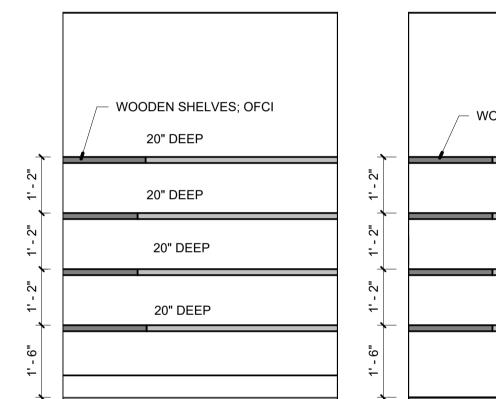



KITCHEN ELEVATION


1/2" = 1'-0"

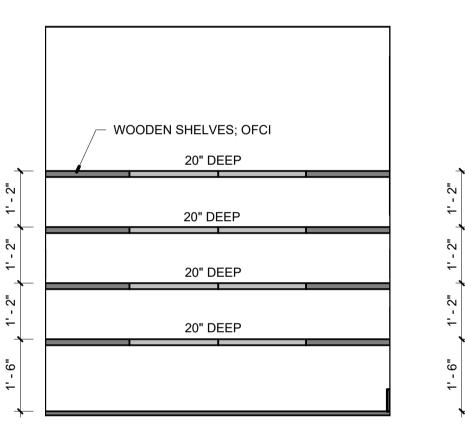

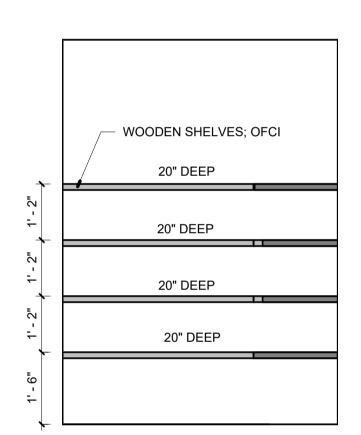

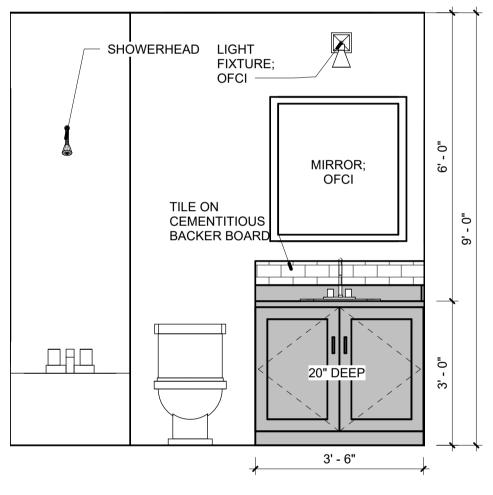

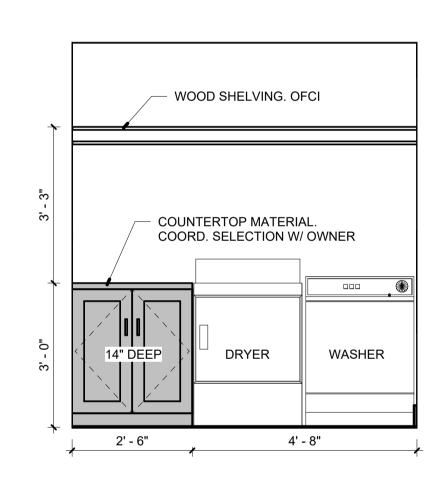

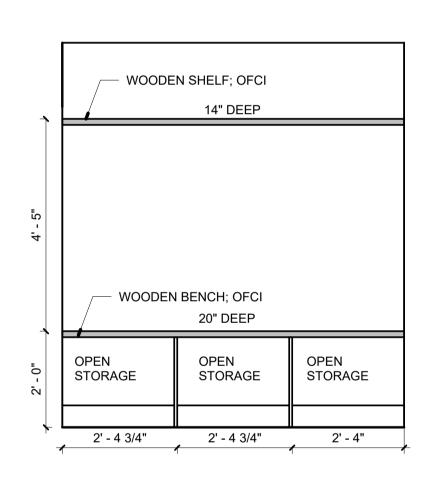















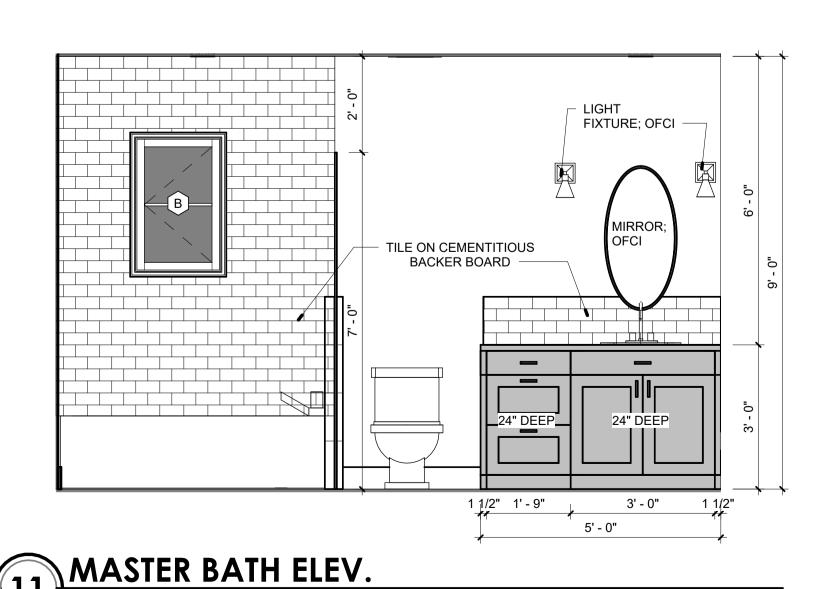

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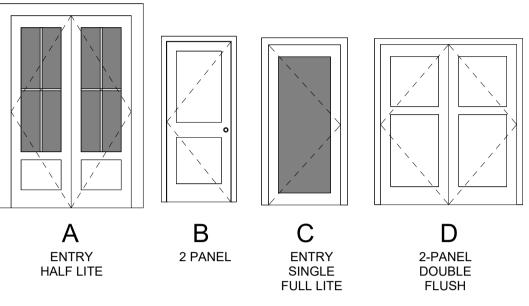
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SHEET TITLE:

INTERIOR **ELEVATIONS**

DOOR NO.			Г	OOR		Hardware	FRAME	
	TYPE MARK	WIDTH	HEIGHT	MATERIAL	FINISH		MATERIAL	Comments
				1				
)2	В	2' - 8"	6' - 8"	WD	PAINT	PASSAGE	WD	
)3	В	2' - 4"	6' - 8"	WD	PAINT	PASSAGE	WD	
)4	С	3' - 0"	6' - 8"	FBG	PAINT	ENTRY	FBG	
)5	В	2' - 8"	6' - 8"	WD	PAINT	PRIVATE	WD	
)6	В	2' - 0"	5' - 0"	WD	PANT	PASSAGE	WD	
)7	В	2' - 0"	6' - 8"	WD	PAINT	PASSAGE	WD	
)8	В	2' - 8"	6' - 8"	WD	PAINT	PRIVATE	WD	
)9	В	2' - 8"	6' - 8"	WD	PAINT	PRIVATE	WD	
)10	D	4' - 0"	6' - 8"	WD	PAINT	PASSAGE	WD	
)11	В	2' - 8"	6' - 8"	WD	PAINT	PRIVATE	WD	
)12	D	2' - 8"	6' - 8"	WD	PAINT	PASSAGE	WD	
)13	D	3' - 0"	6' - 8"	WD	PAINT	PRIVATE	WD	
)14	D	4' - 0"	6' - 8"	WD	PAINT	PASSAGE	WD	
)15	В	2' - 6"	6' - 8"	WD	PAINT	PASSAGE	WD	
)16	В	2' - 6"	6' - 8"	WD	PAINT	PRIVATE	WD	
)17	Α	5' - 0"	8' - 0"	FBG	PAINT	ENTRY	FBG	

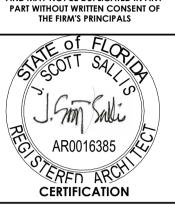
DOOR TYPES



DOOR NOTES

- CONTRACTOR TO VERIFY ALL DOOR STYLES, DOOR AND FRAME MATERIALS, AND HARDWARE WITH
- ALL GLAZING IN DOOR TO BE TEMPERED SAFETY GLAZING.
- WOOD DOORS TO BE SOLID CORE, STAINED.
- PROVIDE DOOR STOPS, BUMPERS, THRESHOLDS AND WEATHERSTRIPS FOR ALL DOORS AS REQUIRED.


ROOM FINISH SCHEDULE													
	Floor Finish	WALLS NORTH Material	_	WALLS SOUTH Material	South Finish	WALLS EAST Material	East Finish	WALLS WEST Material	West Finish	CEILING			
Name										Material	Finish	Height	Comments
BATH A	TILE	MRGWB	PAINT	MRGWB	PAINT	MRGWB	PAINT	MRGWB	PAINT	MRGWB	PAINT	9' - 0"	
CLST. 1	LVT	GWB	PAINT	GWB	PAINT	GWB	PAINT	GWB	PAINT	GWB	PAINT	9' - 0"	
CLST. 2	LVT	GWB	PAINT	GWB	PAINT	GWB	PAINT	GWB	PAINT	GWB	PAINT	9' - 0"	
FAMILY ROOM	LVT	GWB	PAINT	GWB	PAINT	GWB	PAINT	GWB	PAINT	GWB	PAINT	9' - 0"	
HALL	LVT	GWB	PAINT	GWB	PAINT	GWB	PAINT	GWB	PAINT	Exist. T&G	PAINT	8' - 0"	
HALL	LVT	GWB	PAINT	GWB	PAINT	GWB	PAINT	GWB	PAINT	GWB	PAINT	9' - 0"	
HALL	LVT	GWB	PAINT	GWB	PAINT	GWB	PAINT	GWB	PAINT	Exist. T&G	PAINT	9' - 0"	
KITCHEN/DINING	LVT	GWB	PAINT	MRGWB	PAINT	GWB	PAINT	GWB	PAINT	Exist. T&G	PAINT	9' - 0"	
LAUNDRY/STORAGE	LVT	MRGWB	PAINT	MRGWB	PAINT	MRGWB	PAINT	MRGWB	PAINT	MRGWB	PAINT	9' - 0"	
LIVING	LVT	GWB	PAINT	GWB	PAINT	GWB	PAINT	GWB	PAINT	Exist. T&G	PAINT	9' - 0"	
M. CLST. A	LVT	GWB	PAINT	GWB	PAINT	GWB	PAINT	GWB	PAINT	GWB	PAINT	9' - 0"	
M. CLST. B	LVT	GWB	PAINT	GWB	PAINT	GWB	PAINT	GWB	PAINT	GWB	PAINT	9' - 0"	
MASTER BATH	TILE	MRGWB	PAINT	MRGWB	PAINT	MRGWB	PAINT	MRGWB	PAINT	MRGWB	PAINT	9' - 0"	
MASTER BEDROOM	LVT	GWB	PAINT	GWB	PAINT	GWB	PAINT	GWB	PAINT	GWB	PAINT	9' - 0"	
MECH.	LVT	GWB	PAINT	GWB	PAINT	GWB	PAINT	GWB	PAINT	GWB	PAINT	9' - 0"	
MUD ROOM	LVT	GWB	PAINT	GWB	PAINT	GWB	PAINT	GWB	PAINT	GWB	PAINT	9' - 0"	
PANTRY	LVT	GWB	PAINT	GWB	PAINT	GWB	PAINT	GWB	PAINT	GWB	PAINT	9' - 0"	
ROOM 1	LVT	GWB	PAINT	GWB	PAINT	GWB	PAINT	GWB	PAINT	GWB	PAINT	9' - 0"	
ROOM 2	LVT	GWB	PAINT	GWB	PAINT	GWB	PAINT	GWB	PAINT	GWB	PAINT	9' - 0"	
SECOND LEVEL		'	•						•	•			
BATH 4	TILE	MRGWB	PAINT	MRGWB	PAINT	MRGWB	PAINT	MRGWB	PAINT	MRGWB	PAINT	7' - 7"	EXISTING CEILING HEIGHT
CLST. 4	LVT	GWB	PAINT	GWB	PAINT	GWB	PAINT	GWB	PAINT	GWB	PAINT	8' - 0"	EXISTING CEILING HEIGHT
FLEX SPACE	LVT	GWB	PAINT	GWB	PAINT	GWB	PAINT	GWB	PAINT	GWB	PAINT	7' - 7"	EXISTING CEILING HEIGHT

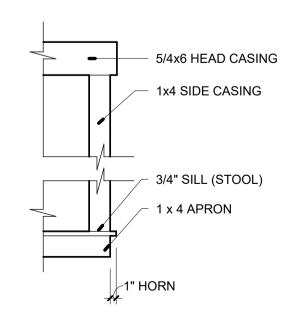



WINDOW SCHEDULE									
Type Mark	Width	Height	Head Height	Comments					
A	2' - 9"	5' - 3"	7' - 5"						
В	2' - 0"	3' - 0"	7' - 5"						
С	6' - 0"	5' - 3"	<varies></varies>						
			8' - 0"						

WINDOW TYPES

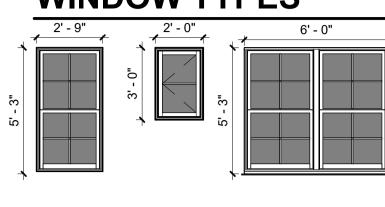


SINGLE HUNG FIXED CASEMENT

WINDOW NOTES

ALL WINDOWS TO BE VINYL, IMPACT-RATED PRODUCT. ALL WINDOWS TO HAVE MIN. LOW-E GLASS COATING.

FLASHING PROCESS FOR NEW WINDOWS

- IF LIQUID VAPOR BARRIER IS NOT USED, CUT BUILDING WRAP VAPOR BARRIER AS SHOWN. FOLD BOTTOM AND TOP SIDE FLAPS INTO OPENING AND FASTEN. TEMPORARILY HOLD TOP FLAP UP ABOVE OPENING. IF LIQUID VAPOR BARRIER IS USED, PAINT BARRIER INTO OPENING.
- PROVIDE SILL FLASHING TAPE OR ADDITIONAL LIQUID FLASHING THAT OVERHANGS OPENING 1" AND EXTENDS UP OPENING SIDES A MINIMUM OF 6".
- PROVIDE 2ND LAYER OF SILL FLASHING OR LIQUID FLASHING TO OVERLAP FIRST LAYER BY 1". DO NOT EXTEND SILL FLASHING PAST INTERIOR FACE OF FRAMING.
- INSTALL WINDOW FROM EXTERIOR OF BUILDING, PLUMB, SQUARE AND VERIFY OPERATION. FASTEN WINDOW
- IN OPENING WITH 2" GALVANIZED ROOFING NAILS AT 6" O.C. PROVIDE SIDE FLASHING TAPE OR ADDITIONAL LIQUID FLASHING TO EXTEND 2" ABOVE TOP AND BOTTOM OF
- PROVIDE TOP FLASHING TAPE OR LIQUID FLASHING TO EXTEND PAST EDGE OF SIDE FLASHING TAPE BY 1". DO
- NOT TAPE OR SEAL BOTTOM NAILING FIN.
- IF LIQUID VAPOR BARRIER IS NOT USED, FOLD DOWN TOP FLAP OF BUILDING WRAP VAPOR BARRIER. IF LIQUID VAPOR BARRIER IS USED, APPLY ADDITIONAL LAYER OF LIQUID FLASHING ABOVE WINDOW.
- PROVIDE FLASHING TAPE/ADDITIONAL LIQUID FLASHING AT DIAGONAL CUTS AT LEAST 1" LONGER THAN CUT. WHERE EXTERIOR SEALANT IS REQUIRED, USE OSI QUAD MAX CHEMICALLY CURING SEALANT, OR ARCHITECT

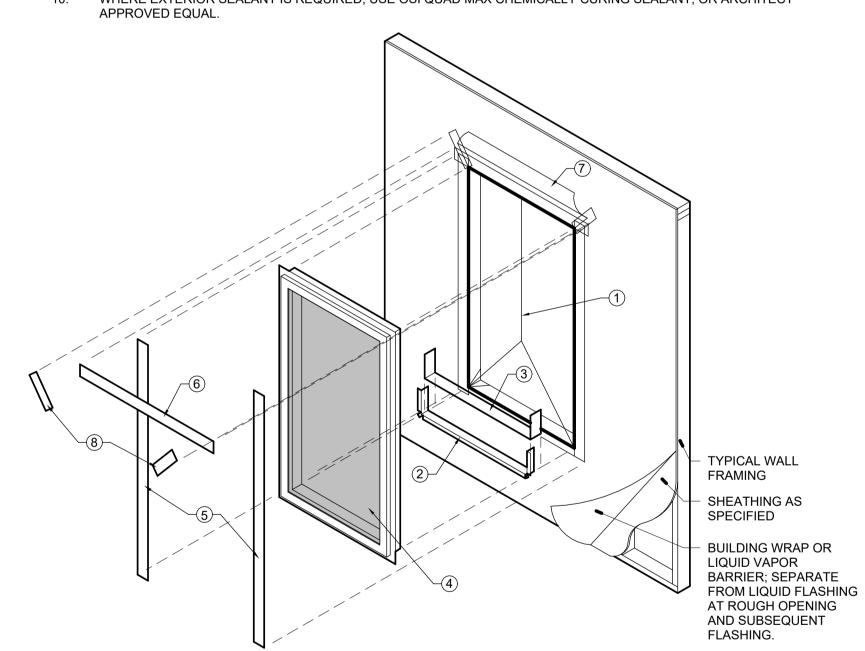

WINDOW FLASHING DETAIL

1/2" = 1'-0"

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Pensacola, FL 32502

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CHECKED BY: JLR JSS

ISSUE DATE: 06-22-21 **REVISIONS**

SCHEDULES AND DIAGRAMS

A601 PROJECT NO: 20044



AERIAL VIEW



RENDERED PLAN VIEW


NOTE: ALL 3D VIEWS ARE CONCEPTUAL AND NOT CONSIDERED CONTRACT DOCUMENTS

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COMERFORD RENOVATION

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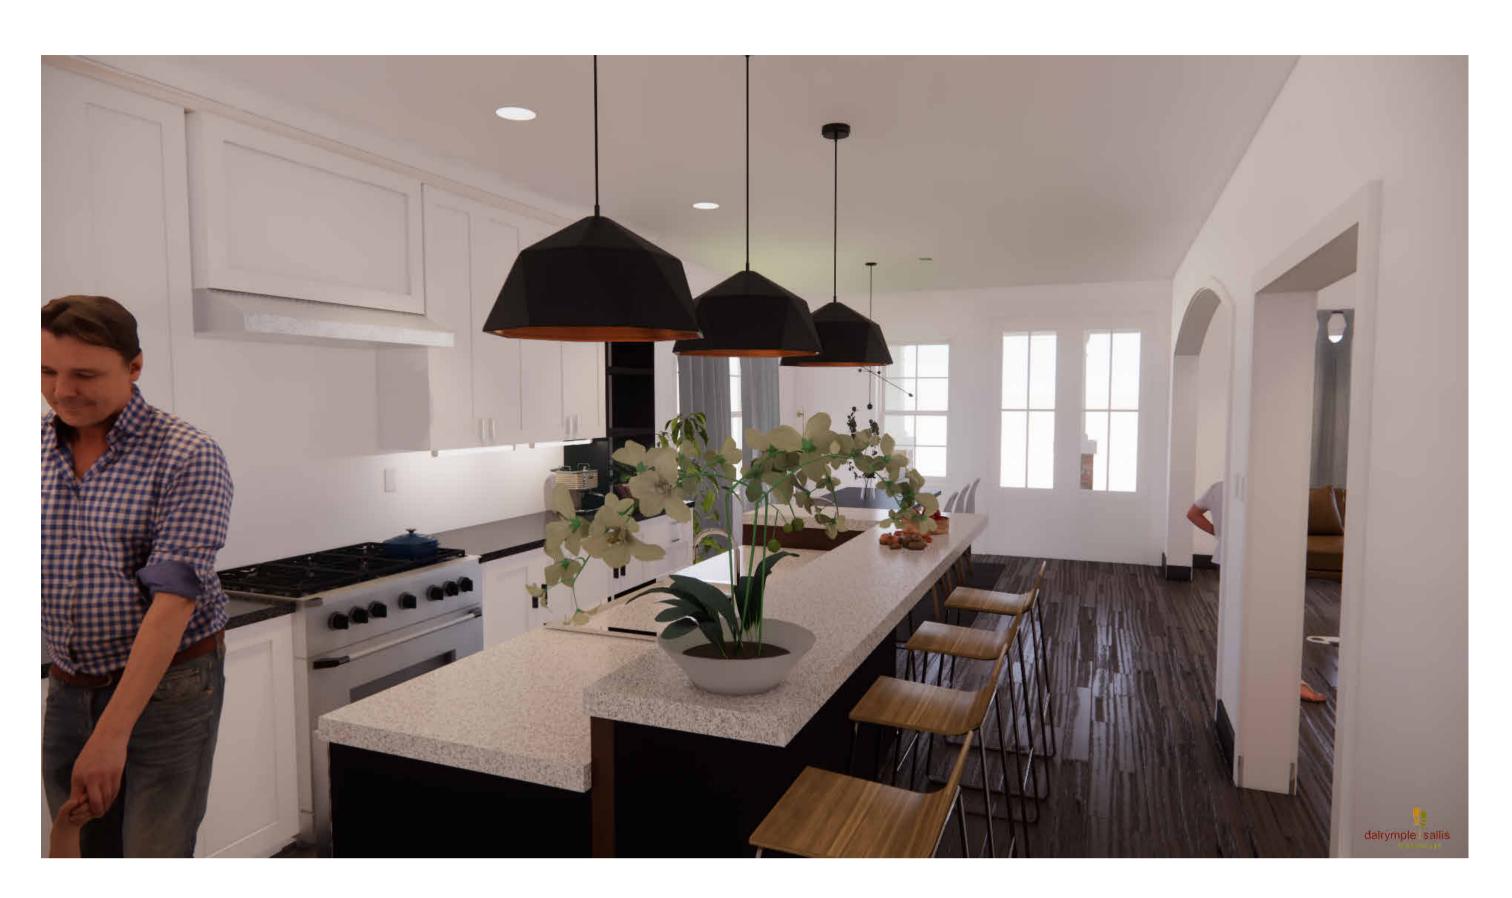
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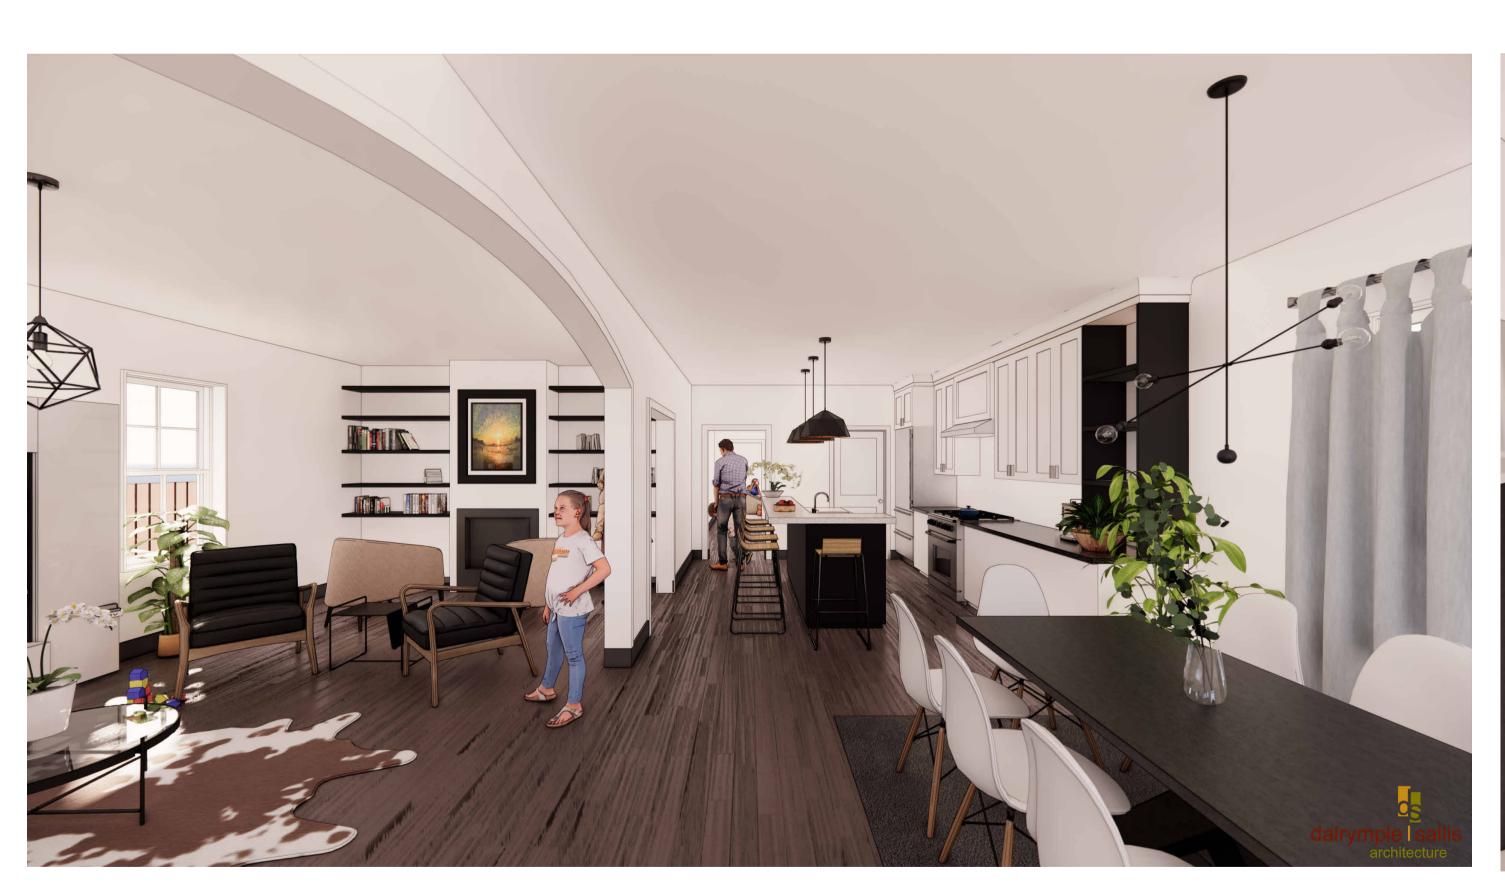
3D RENDERED PLAN VIEWS

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RENOVATION COMERFORD

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06-22-21
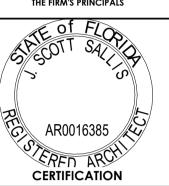
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3D INTERIOR PERSPECTIVE **VIEWS**



City of Pensacola

Memorandum

File #: 21-00778 Zoning Board of Adjustments 10/20/2021

TO: Zoning Board of Adjustments Members

FROM: Leslie Statler, Senior City Planner

DATE: 9/9/2021

SUBJECT:

1818 E. Strong Street - THIS ITEM HAS BEEN POSTPONED UNTIL FURTHER NOTICE R-1AAA

BACKGROUND:

Click or tap here to enter text.